

SANTA FE COUNTY APPROVALS

SFC Fire Marshall Bus SFC P/W Director SFC Water Utilities Division Director Date: 4/13/15 SFC Land Use Director



SANTA FE COUNTY PUBLIC WORKS 424 NM SR 599

SANTA FE, NEW MEXICO 87504 TELEPHONE NO.: 505-992-3010

NUMERIC COME CONFIDURATION	REV NO	REV DATE	DESCRIPTION	
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SANTA FE COUNTY PUBLIC WORKS DEPARTMENT 424 NM599 FRONTAGE ROAD SANTA FE, NEW MEXICO 87507

CERTIFICATION:

I, STEVEN K. MORROW, REGISTERED PROFESSIONAL ENGINEER NO. 13679 HEREBY CERTIFY THAT THE FOLLOWING PLANS AND DESIGNS WERE PREPARED

UNDER MY SUPERVISION AND DIRECTION AND THAT

SAME IS TRUE AND CORRECT TO THE BEST OF MY KNOWLEDGE BELIEF.

STEVEN K. MORROW, N.M.P.E. 11-20-14

I	N	DEX	OF DRAWINGS
SEQUENCE		SHEET	DESCRIPTION
1		G-001	TITLE SHEET AND INDEX TO DRAWINGS
2		G-002	INDEX MAP AND GENERAL NOTES
3		G-003	CONSTRUCTION NOTES AND PUBLIC UTILITY CONTACT INFORMATION
4		G-004	SUMMARY OF QUANTITIES
5		G-005	RIGHT-OF-WAY / PROPERTY MAP
6		G-006	DRAINAGE PLAN
7		G-007	DRAINAGE DETAILS
8		G-008	TYPICAL ROADWAY SECTIONS
9		G-009	ENVIRONMENTAL COMMITMENT
10		G-010	SEDIMENT EROSION CONTROL AND RESEEDING PLAN
11		G-011	EL GANCHO WAY — EXISTING UTILITY PLAN
12,		G-012	OLD SANTA FE TRAIL EXISTING UTILITY PLAN
13		G-013	OLD SANTA FE TRAIL EXISTING UTILITY PLAN
14		G-014	OLD SANTA FE TRAIL EXISTING UTILITY PLAN
15		C-101	EL GANCHO WAY ROADWAY- PLAN AND PROFILE
16		C-102	OLD SANTA FE TRAIL ROADWAY - PLAN AND PROFILE - B.O.P. TO STA. 22+00
17		C-103	OLD SANTA FE TRAIL ROADWAY - PLAN AND PROFILE - STA. 22+00 TO STA. 35+00
18		C-104	OLD SANTA FE TRAIL ROADWAY - PLAN AND PROFILE - STA. 35+00 TO STA. 48+00
19		C-105	OLD SANTA FE TRAIL ROADWAY - PLAN AND PROFILE - STA. 48+00 TO E.O.P.
20		C-201	INTERSECTION DETAILS
21		C-202	INTERSECTION DETAILS
22		C-203	EL GANCHO WAY DRIVEWAY - PLAN AND PROFILES
23		C-204	OLD SANTA FE TRAIL DRIVEWAY - PLAN AND PROFILES
24		C-301	EXISTING SIGNAGE PLAN
25		C-302	TRAFFIC CONTROL, STRIPING PLAN AND DETAILS
26		C-303	EL GANCHO WAY STRIPING PLAN
27		C-304	EL GANCHO WAY-OLD SANTA FE TRAIL INTERSECTION DETAILS
28		C-401	CULVERT CROSSING SECTIONS
29		W-101	INDEX TO WATERLINE DRAWINGS
30		W-201	EL GANCHO WAY WATERLINE PLAN & PROFILE STA.09+12.50 TO STA.23+02.84
31		W-202	OLD SANTA FE TRAIL WATERLINE PLAN & PROFILE STA.11+00 TO STA.23+00
32		W-203	OLD SANTA FE TRAIL WATERLINE PLAN & PROFILE STA.23+00 TO STA.35+00
33		W-204	OLD SANTA FE TRAIL WATERLINE PLAN & PROFILE STA.35+00 TO STA.47+00
34		IW-205	OLD SANTA FE TRAIL WATERLINE PLAN & PROFILE STA.47+00 TO STA.59+00
35		W-206	OLD SANTA FE TRAIL WATERLINE PLAN & PROFILE STA.59+00 TO STA.71+00
36		W-207	OLD SANTA FE TRAIL WATERLINE PLAN & PROFILE STA.71+00 TO STA.75+42.84
37		W-501	MASTER METER VAULT DETAIL
38		W-502	AIR AND VACUUM STATION DETAIL
39		W-503	STANDARD WATERLINE DETAILS
40		W-504	MISCELLANIFOLIS LITHLITY DETAILS THESE DRAWINGS DO NOT INCLUDE NECESSARY OF
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NOVEMBER, 2014

plans for the

OLD SANTA FE TRAIL ROAD IMPROVEMENTS AND WATERLINE TL2N N.M.D.O.T. CN C5111204 SFC PROJECT No. 0798

> CIVIL / WATER **RESOURCES ENGINEERS**

> > Steven K. Morrow, P.E.

GEOTECHNICAL ENGINEERS

Geo-Test, Inc. Charles M. Miller, P.E.

ENVIRONMENTAL CONSULTANT

Marron and Associates Christina Kelso

SUBSURFACE UTILITY ENGINEERS

CobbFendley Sean Wolfe, P.E.

SURVEYOR


Surveying Control Inc. Steve Toler, P.S.

MOLZENCORBIN

ENGINEERS | ARCHITECTS | PLANNERS

2701 Miles Road SE, Albuquerque, New Mexico 87106 505 242 5700 office 505 242 0673 fax

G-001

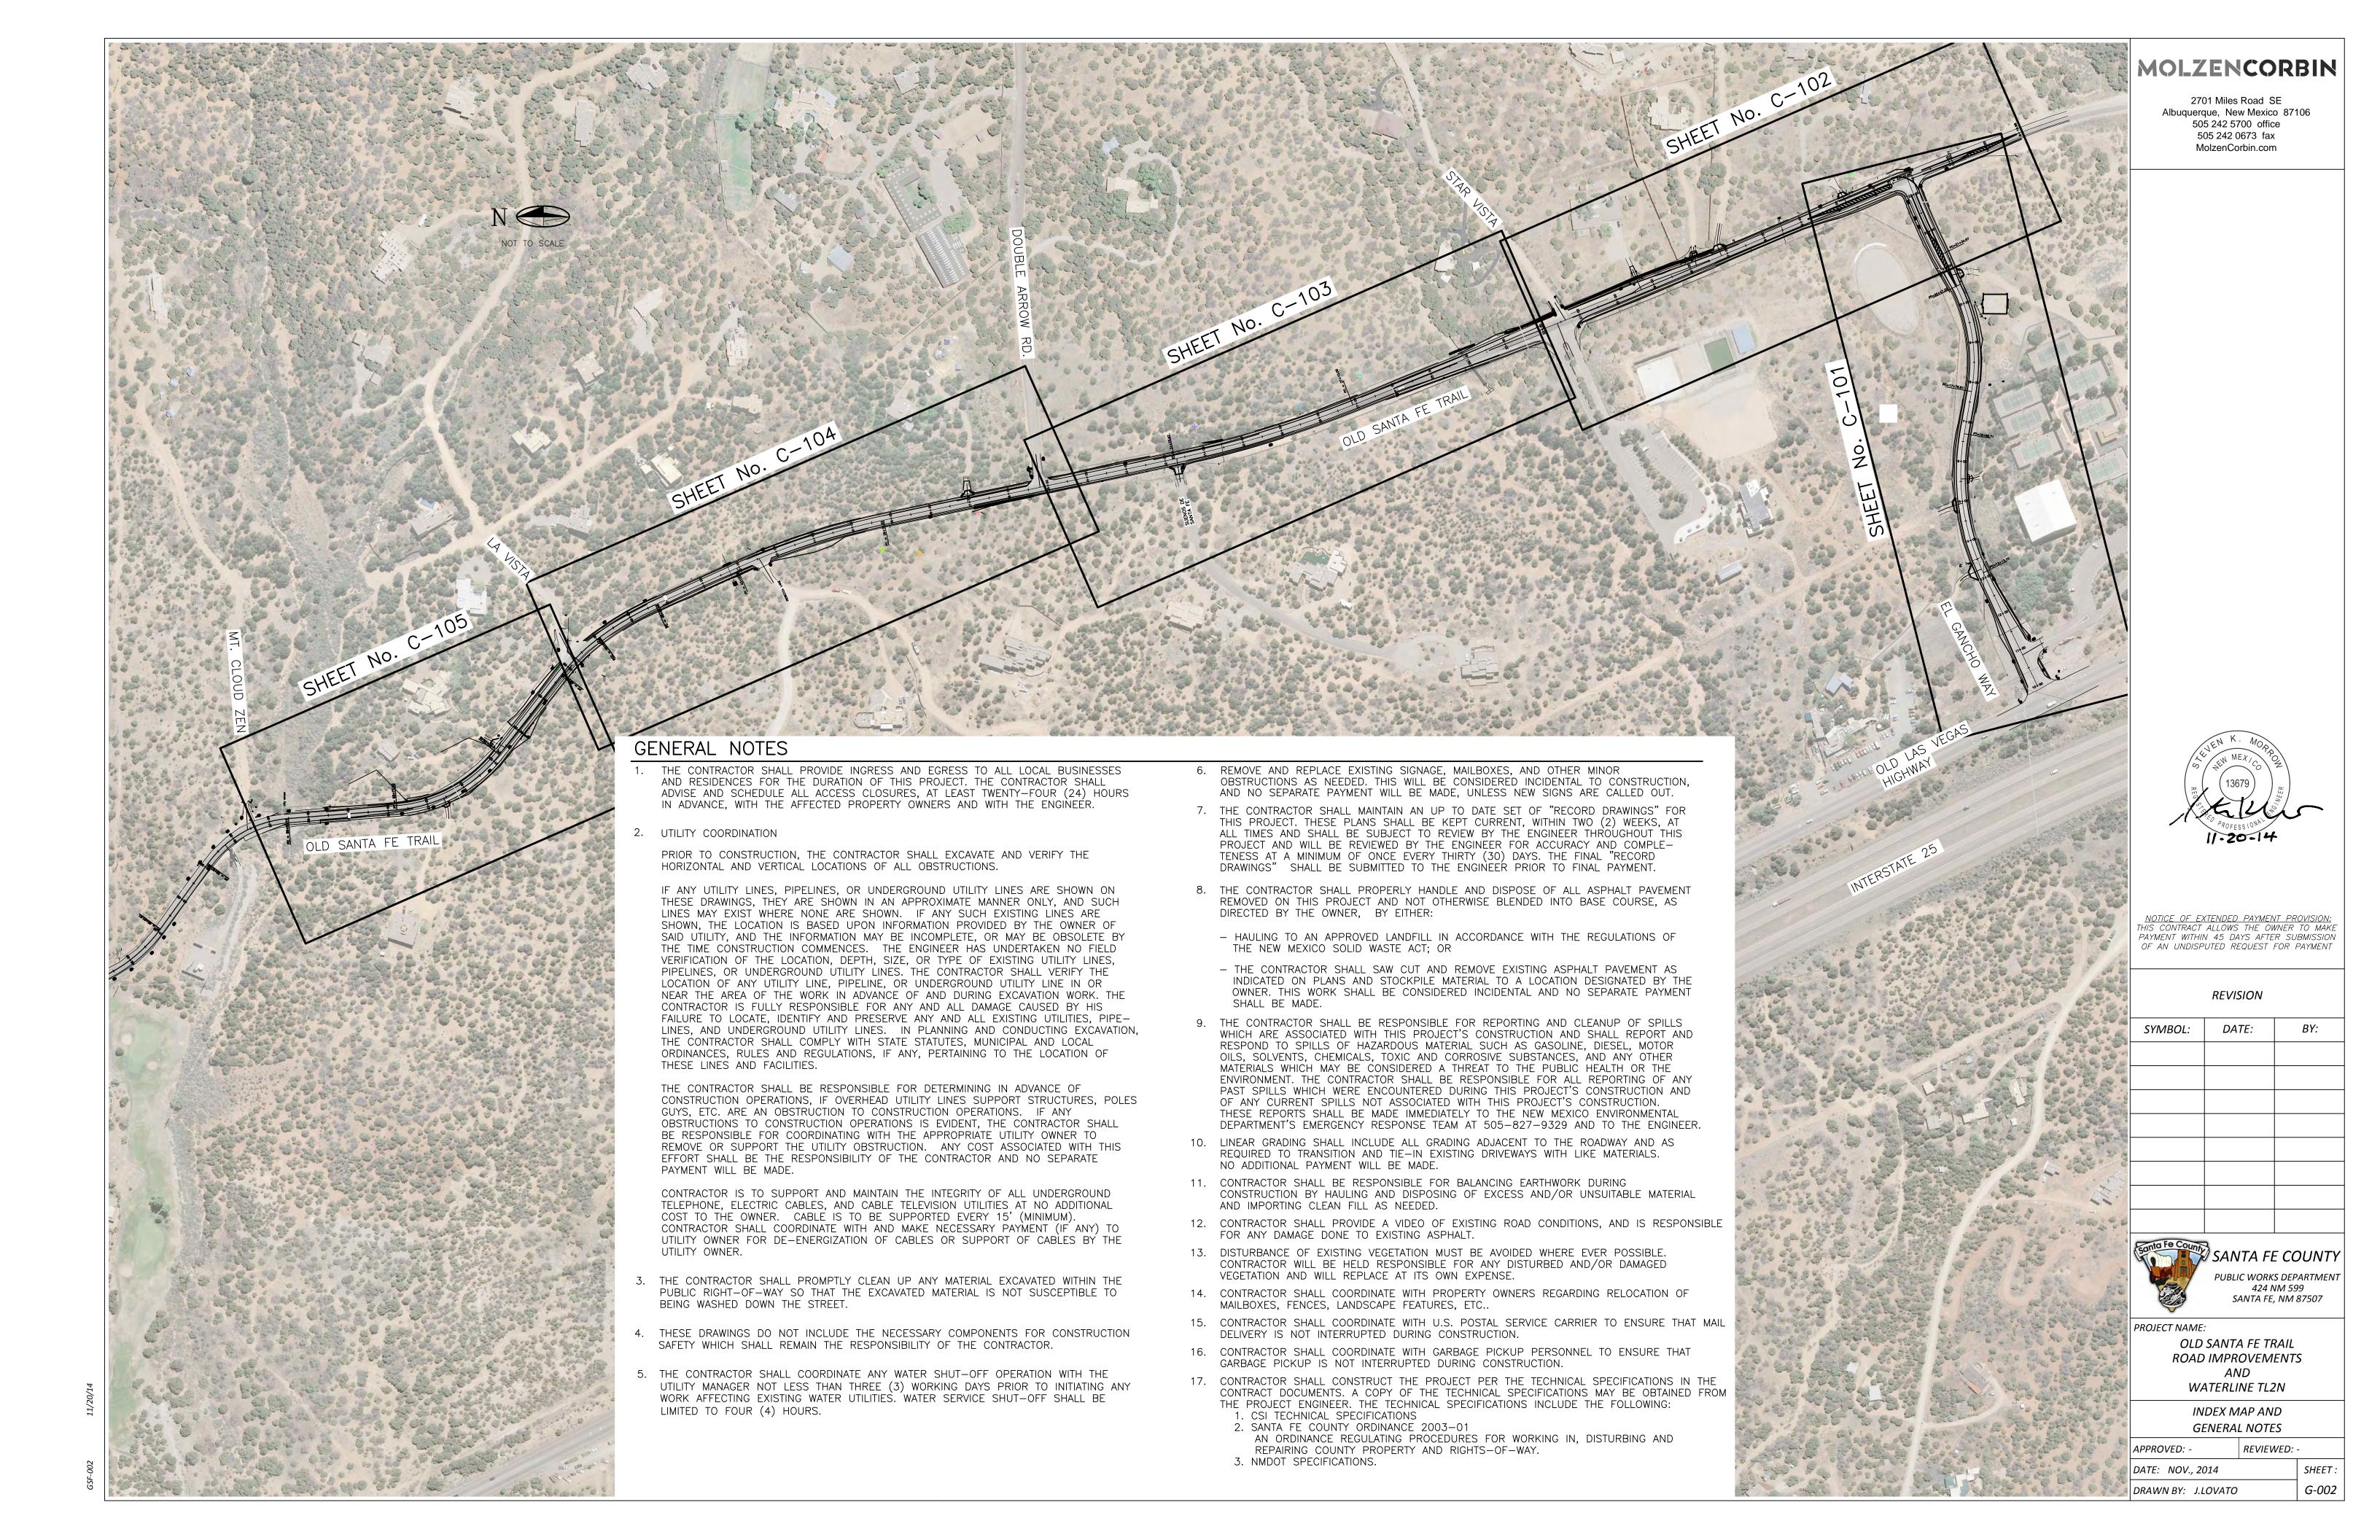

- 1. ALL ROADWAY CONSTRUCTION AND RE-CONSTRUCTION SHALL COMPLY WITH THE NEW MEXICO DEPARTMENT OF TRANSPORTATION
- STANDARD SPECIFICATIONS FOR ROAD AND BRIDGE CONSTRUCTION LATEST EDITION. 2. A TRAFFIC CONTROL PLAN STAMPED BY A NM PROFESSIONAL ENGINEER IS REQUIRED FOR ALL PROJECTS WITHIN ANY SANTA FE COUNTY
- 3. THE CONTRACTOR MUST ADHERE TO ALL REQUIREMENTS AS SET FORTH IN ORDINANCE 2003-1 EXCAVATION/RESTORATION
- 4. THE CONTRACTOR SHALL PROVIDE ALL TRAFFIC CONTROL DEVICES IN ACCORDANCE WITH N.M. DOT STANDARD SPECIFICATIONS FOR ROAD AND BRIDGE CONSTRUCTION AND ANY APPLICABLE SPECIAL PROVISION AND/OR SUPPLEMENTAL SPECIFICATION, AS WELL AS THE MOST CURRENT EDITION OF THE MANUAL OF UNIFORM TRAFFIC CONTROL DEVICES. UNLESS OTHERWISE SPECIFIED HEREIN, ALL COSTS RELATED TO TRAFFIC CONTROL SHALL BE INCIDENTAL TO THE PROJECT.
- 5. DRAINAGE PIPE SPECIFIED AS CORRUGATED METAL PIPE (CMP) SHALL BE 16-GAUGE MINIMUM.
- 6. CONTRACTOR SHALL NOT BEGIN ANY CONSTRUCTION ACTIVITY WITHOUT THE APPLICABLE PERMITS FROM SANTA FE COUNTY. A COPY OF THE APPROVED DRAWINGS SHALL ALWAYS BE AVAILABLE AT THE CONSTRUCTION SITE DURING BUSINESS HOURS CONTRACTOR / APPLICANT MUST SUBMIT THE FOLLOWING DOCUMENTS AS PER ORDINANCE 2003-1:
- COPY OF THEIR CONTRACTORS LICENSE - COPY OF THEIR LIABLITY INSURANCE
- \$15,000.00 PERFORMANCE BOND - COMPLETED PERMIT APPLICATION (AND ASSOCIATED FEES IF REQUIRED)
- TRAFFIC CONTROL PLAN MUST BE STAMPED BY A PROFESSIONAL ENGINEER

ORDINANCE FOR ALL WORK WITHIN SANTA FE COUNTY RIGHT OF WAY.

- PRE PROJECT VIDEO DOCUMENTATION
- SUBMIT APPLICATION AND ALL PERTINENT DOCUMENTS TO: JOHNNY P. BACA, CPO
 - TRAFFIC MANAGER
 - SANTA FE COUNTY PUBLIC WORKS DEPARTMENT 424 NM STATE ROAD 599 SANTA FE, NEW MEXICO 87507 OFFICE (505) 992.3020 FAX (505) 992.3028

jpbaca@santafecountynm.gov

- 7. A SANTA FE COUNTY INITIATED PRECONSTRUCTION CONFERENCE SHALL BE CONDUCTED IN THE PRESENCE OF THE PROJECT ENGINEER AND OR THE OWNER'S PROJECT REPRESENTATIVE (OPR) PRIOR TO THE INITIATION OF ANY CONSTRUCTION ACTIVITY. IN ADDITION, THE CONTRACTOR SHALL NOTIFY THE COUNTY NO LESS THAN 24 HRS FROM THE BEGINNING OF ANY CONSTRUCTION WORK.
- 8. THE OPR SHALL BE RESPONSIBLE FOR INITIATING ANY NECESSARY REVISIONS TO THE APPROVED DESIGN DRAWINGS, ALL APPROPRIATE DRAWINGS AND DESIGN CRITERIA TO SUPPORT SUCH CHANGES. ALL CHANGE-SUPPORTING DOCUMENTATION SHALL BE STAMPED BY A LICENSED ENGINEER IN NEW MEXICO, AND APPROVED BY SANTA FE COUNTY AS A CHANGE ORDER PRIOR TO EXECUTING ANY WORK.
- 9. THE CONTRACTOR SHALL RETAIN THE SERVICES OF A NEW MEXICO PROFESSIONAL SURVEYOR FOR VERIFICATION OF CRITICAL HORIZONTAL AND VERTICAL CONTROL AND THE CERTIFICATION OF RECORD DRAWINGS. CRITICAL ELEVATIONS OR HORIZONTAL CONTROL MAY BE IDENTIFIED IN THE DRAWINGS. OR MAY BE IDENTIFIED BY THE COUNTY PROJECT MANAGER OR OPR AT HIS/HER DISCRETION. THE CONTRACTOR SHALL MAINTAIN AT THE SITE A COPY OF ALL FIELD NOTES, TO BE MADE AVAILABLE FOR REVIEW BY THE COUNTY PROJECT MANAGER OR OPR AT ANY TIME DURING THE EXECUTION OF THE PROJECT. THE UPDATING OF SUCH DRAWINGS AND FIELD NOTES SHALL BE DONE FREQUENTLY. NOT LESS THAN ONCE EVERY TWO WEEKS PRIOR TO FINAL ACCEPTANCE OF THE PROJECT, CONTRACTOR SHALL SUBMIT TO THE OPR COMPLETE RECORD DRAWINGS, SHOWING ANY REVISED CRITICAL X,Y, AND Z DATA FOR PIPE INVERTS, MANHOLE RIMS, VALVE BOXES, SERVICE CONNECTIONS ETC. THESE DATA SHALL BE STAMPED BY A NEW MEXICO REGISTERED PROFESSIONAL SURVEYOR, AND SUBMITTED TO THE COUNTY PROJECT MANAGER OR OPR IN PRELIMINARY FORM FOR REVIEW AND APPROVAL. ANY REVISIONS NECESSARY SHALL BE RE-SUBMITTED IN THE FINAL PROJECT CLOSEOUT SUBMITTAL PRIOR TO FINAL ACCEPTANCE OF THE PROJECT. FINAL AS-BUILTS SHALL BE SUBMITTED ON 24X36 AND IN PDF FORMAT.
- 10. IF EXISTING UTILITIES HAVE BEEN SHOWN ON THESE DRAWINGS THEY ARE FOR REFERENCE PURPOSES ONLY. THE CONTRACTOR SHALL BE RESPONSIBLE FOR THE SPOT-LOCATION OF ALL EXISTING UNDERGROUND UTILITIES BY THE APPROPRIATE UTILITY COMPANY. CONTRACTOR SHALL CONTACT NEW MEXICO ONE CALL AT 811, TO COORDINATE SPOT LOCATION OF UNDERGROUND UTILITIES NO LESS THAN 2 DAYS PRIOR TO INITIATING ANY WORK.
- 11. FOR ALL CONCRETE USED, THE DESIGN COMPRESSIVE STRENGTH AT 7 DAYS 1,500 PSI MINIMUM, AND 4,000 PSI AT 28 DAYS. THE CONCRETE SHALL BE A 6 BAG MIX AND MAXIMUM 3/4 INCH AGGREGATE SIZE. AIR ENTRAINMENT SHALL BE BETWEEN 4 AND 7 PERCENT.
- 12. THREE (3) CONCRETE CYLINDER SAMPLES SHALL BE TAKEN FOR EVERY 50 CUBIC YARDS OF CONCRETE INSTALLED, OR A MINIMUM OF ONE SAMPLE PER DAY, WHICHEVER IS GREATER. CONCRETE CYLINDERS SHALL BE TEST-BROKEN AT 7 DAY INTERVALS. TEST RESULTS SHALL BE SUBMITTED DIRECTLY TO THE OPR, AND TO THE COUNTY IN THE FINAL PROJECT CLOSEOUT SUBMITTAL, PRIOR TO FINAL ACCEPTANCE OF
- 13. NOT LESS THAN 5 DAYS PRIOR TO INITIATING ANY WORK, THE CONTRACTOR SHALL SUBMIT A DUST SUPPRESSION AND EROSION CONTROL PLAN FOR THE PROJECT MANAGER AND OR OPR'S APPROVAL. ALL CONSTRUCTION WORK SHALL BE PERFORMED IN SUCH A MANNER THAT WILL HAVE NO ADVERSE EFFECT UPON ADJACENT PROPERTIES OR PUBLIC ROADWAYS.
- 14. CLEARING SHALL BE KEPT TO A MINIMUM, AND STABILIZATION OF BARE SURFACES SHALL BEGIN PROMPTLY AFTER COMPLETION OF CONSTRUCTION ACTIVITIES, AND IN COMPLIANCE WITH EPA REQUIREMENTS IN THE PROJECT'S SWPPP.
- 15. CONTRACTOR SHALL CONFINE ALL CONSTRUCTION OPERATIONS TO THE LIMITS OF THE PROJECT DEFINED IN THESE DRAWINGS, AND IN NO WAY ENCROACH ONTO ADJACENT PROPERTIES, UNLESS LEGAL EASEMENTS ARE PROVIDED. CONTRACTOR SHALL BE HELD SOLELY RESPONSIBLE FOR ANY AGREEMENTS NEEDED, OR DAMAGE CAUSED BY CONSTRUCTION ACTIVITIES TO PUBLIC OR PRIVATE PROPERTY, INCLUDING ROADS AND UTILITIES.
- 16. OVER-EXCAVATION OF ANY UTILITY TRENCHES SHALL NOT BE PERMITTED, UNLESS IT IS DETERMINED, TO THE SATISFACTION OF THE DESIGN ENGINEER, THAT THE SUBSOIL IS NOT SUITABLE FOR PIPE BEDDING AND MUST BE REPLACED WITH IMPORTED FILL. OVER-EXCAVATION PERFORMED UNNECESSARILY BY THE CONTRACTOR SHALL BE REMEDIED WITH CLASSIFIED FILL AND COMPACTION AS REQUIRED FOR CLASS-D BEDDING OR BETTER, AT THE CONTRACTOR'S EXPENSE.
- 17. ONE SET OF BACKFILL DENSITY TESTS SHALL BE PERFORMED FOR EVERY 12 INCH LIFT FOR EACH 200 LINEAR FEET OF PIPELINE, OR FOR ANY STRUCTURE THAT REQUIRES COMPACTED FOUNDATION OR CONTROLLED BACKFILL. FOR PIPELINES OR UTILITIES IN ROADWAYS THE THE TESTING INTERVAL SHALL BE FOR EACH 100 LINEAR FEET.
- 18. SUBGRADE, BASE MATERIAL, ASPHALT-TREATED BASE, AND ASPHALT SURFACE COURSE (MARSHALL) SHALL BE TESTED FOR COMPACTION EVERY 100 LINEAR FEET. ONE ASPHALT SAMPLE SHALL BE TAKEN FOR EVERY 500 TONS INSTALLED, OR ONE A DAY, WHICHEVER IS LESS, SAMPLES SHALL BE TESTED AND THE RESULTS SENT TO THE OPR.
- 19. BASECOURSE SHALL BE COMPACTED TO NO LESS THAN 95% OF MAXIMUM DENSITY USING AASHTO, T-180 MODIFIED MOISTURE DENSITY TEST. BASECOURSE SHALL MEET GRADATION REQUIREMENTS SPECIFIED IN TABLE 421 CLASS B, NMDOT, "STANDARD SPECIFICATIONS FOR
- 20. CONTRACTOR SHALL SUBMIT ASTM OR AASHTO CERTIFICATES OF MATERIALS' COMPLIANCE TO THE OPR, BUT NO LESS THAN 5 DAYS PRIOR TO INITIATING ANY WORK INVOLVING SUCH MATERIALS. OPR SHALL SUBMIT THESE MATERIAL CERTIFICATES TO THE COUNTY IN THE FINAL PROJECT CLOSEOUT SUBMITTAL, PRIOR TO FINAL ACCEPTANCE OF THE PROJECT.
- 21. CONTRACTOR SHALL TAKE ALL NECESSARY MEASURES TO PROTECT HORIZONTAL AND VERTICAL CONTROL SURVEY MONUMENTS (MARKS) FROM DAMAGE DURING CONSTRUCTION. IF DURING THE EXECUTION OF THE PROJECT, THE CONTRACTOR'S ACTIVITIES DISTURB OR DESTROY SUCH MARKS, A NEW MEXICO LICENSED SURVEYOR HIRED BY THE CONTRACTOR, AT THE CONTRACTOR'S EXPENSE, SHALL RE-ESTABLISH THE MARKS IN ACCORDANCE WITH THE STANDARDS AND PROCEDURES SET FORTH BY THE "GEODETIC MARK PRESERVATION GUIDEBOOK". FOR MORE INFORMATION CONTACT NGS MARK PRESERVATION CENTER, NOAA (505) 768-3606.
- 22. CONTRACTOR SHALL PROTECT AND MAINTAIN ALL EXISTING STRUCTURES FREE OF DUST AND/OR CONSTRUCTION DEBRIS AT ALL TIMES DURING THE EXECUTION OF THE PROJECT. ALL EXISTING AND NEW STRUCTURES SHALL BE CLEANED PRIOR TO FINAL ACCEPTANCE OF THE PROJECT. ALL COSTS RELATED TO THIS ITEM SHALL BE INCIDENTAL TO THE WORK AND NO EXTRA PAYMENTS SHALL BE MADE TO THE
- 23. CONTRACTOR SHALL REPAIR ANY EXISTING STRUCTURE OR UTILITY CONDUIT, AND ITS UTILITY CORRIDOR/EASEMENT DAMAGED AS A RESULT OF THE EXECUTION OF THE PROJECT, AT NO ADDITIONAL COST TO SANTA FE COUNTY OR THE RESPECTIVE UTILITY. EXISTING ROADS ACCESS FOR ADJACENT PROPERTIES SHALL BE MAINTAINED UNDER ALL TYPICAL WEATHER CONDITIONS.
- 24. ALL AREAS DISTURBED BY THE CONSTRUCTION ACTIVITIES OF THIS PROJECT SHALL BE RESTORED, RE-GRADED, PER THE RE-VEGETATION PLAN, OR IN A MANNER ACCEPTABLE TO SANTA FE COUNTY, AND IN COMPLIANCE WITH PROJECT'S SWPPP
- 25. CONTRACTOR SHALL BE SOLELY RESPONSIBLE FOR EROSION CONTROL INCIDENTAL TO THE CONSTRUCTION ACTIVITIES. THE CONTRACTOR SHALL SUBMIT TO SANTA FE COUNTY A STORM WATER POLLUTION PREVENTION PLAN (SWPPP) THAT WILL ADDRESS ALL CONSTRUCTION PHASES. THIS SHALL BE DONE IN ACCORDANCE WITH THE MOST CURRENT NATIONAL POLLUTION DISCHARGE ELIMINATION SYSTEM (NPDES) GENERAL CONSTRUCTION PERMIT (2012 GCP) REQUIREMENTS FOR ALL CONSTRUCTION ACTIVITIES. IN ADDITION, THE CONTRACTOR SHALL PROCURE A STORM WATER POLLUTION PERMIT FROM USEPA, A MINIMUM OF 30 DAYS PRIOR TO INITIATING ANY SITE WORK.
- 26. CONTRACTOR SHALL PROVIDE AN AREA TO STORE CONSTRUCTION DEBRIS WHERE IT WILL NOT BE A NUISANCE TO THE SURROUNDING NEIGHBORHOOD. ALL DEBRIS SHALL BE CONTAINED IN SUCH A MANNER THAT WILL PREVENT SCATTERING, AND BE IN COMPLIANCE WITH THE PROJECT'S SWPPP. ALL DEBRIS, INCLUDING TREES AND UNDERGROWTH SHALL BE DISPOSED OF PROPERLY WITHIN AN APPROVED LANDFILL, AND REMOVED FROM THE SITE PRIOR TO FINAL INSPECTION.
- 27. CONTRACTOR SHALL BE SOLELY RESPONSIBLE FOR THE PROTECTION OF THE WORK MATERIALS AND EQUIPMENT PRIOR TO AND AFTER THEIR INSTALLATION AS APPLICABLE, UNTIL THE PROJECT'S FINAL ACCEPTANCE BY SANTA FE COUNTY.
- 28. THE MAXIMUM DEVIATION OF THE TOP OF SURFACE AT THE CURB AND GUTTER SHALL NOT EXCEED 1/8 INCH PER 10 FEET, NOR SHALL THE INSIDE FACE DEVIATE MORE THAN 1/4 INCH PER 10 FEET FROM A STRAIGHT LINE. PRIOR OR DURING THE COUNTY'S FINAL INSPECTION, ALL CURB AND GUTTER SHALL BE TESTED FOR POSITIVE WATER FLOW. ANY AREAS THAT FAIL THIS TEST SHALL BE REJECTED.
- 29. UTILITY LINES SHALL BE BORED UNDER ALL EXISTING STREETS, CONCRETE FEATURES, AND A MINIMUM 12-INCH SEPARATION SHALL BE MAINTAINED BETWEEN LINES. ALL CURB, GUTTER, SIDEWALK AND ASPHALT DAMAGE IN COUNTY, STATE OR PRIVATE RIGHT OF WAY RESULTING FROM ANY CONSTRUCTION ACTIVITY SHALL BE REPAIRED BEFORE FINAL INSPECTION AT THE CONTRACTORS EXPENSE.
- 30. A COMPLETION LETTER FROM EACH UTILITY COMPANY SHALL BE SUBMITTED TO THE COUNTY UTILITIES DEPARTMENT PRIOR TO
- 31. NO ALTERATION OR MODIFICATION TO ANY DRAINAGE WAY OR ARROYO SHALL BE PERMITTED WITHOUT FIRST OBTAINING A WRITTEN APPROVAL FROM THE COUNTY FLOOD PLAN ADMINISTRATOR.
- 32. THE DESIGN ENGINEER AND SANTA FE COUNTY WAIVE ANY AND ALL RESPONSIBILITY AND IS NOT LIABLE FOR PROBLEMS THAT MAY ARISE FROM THE CONTRACTOR'S FAILURE TO FOLLOW THESE DRAWINGS, SPECIFICATIONS, THE DESIGN INTENT THEY CONVEY, OR FOR PROBLEMS ARISING FROM FAILURE TO OBTAIN AND/OR FOLLOW THE ENGINEER'S WRITTEN RESPONSE TO REQUESTS FOR INFORMATION OR CLARIFICATION WITH RESPECT TO ANY ERRORS, OMISSIONS, INCONSISTENCIES, AMBIGUITIES

- 33. ALL ACCESS AND EXCAVATION PERMITS ARE TO BE OBTAINED FROM THE SANTA FE COUNTY PUBLIC WORKS DEPARTMENT. SUCH PERMITS SHALL BE REQUESTED FOR ALL CURB CUTS OR DRIVEWAYS TO BE BUILT IN COUNTY RIGHT OF WAY. DRIVEWAYS SHALL NOT BE INSTALLED PRIOR TO COUNTY'S APPROVAL OF SITE SPECIFIC PLANS AND THE CONTRACTOR HAS PROCURED A PERMIT FROM THE COUNTY PUBLIC WORKS DEPARTMENT.
- DAMAGED SIGNS WILL BE REPLACED AT THE CONTRACTORS EXPENSE.
- · RELOCATION / DEMOLITION OF EXISTING LANDSCAPING IN RIGHTS-OF WAY WILL BE DONE BY THE CONTRACTOR.
- · SIGNAGE TO BE REINSTALLED AS PER THE MOST CURRENT EDITION OF THE M.U.T.C.D. STANDARDS.
- ANCHORS MUST BE 6" ABOVE GRADE.
- MAILBOX RELOCATION WILL BE COORDINATED WITH THE U.S.P.S LOCAL OFFICE.
- REGULATORY SIGNAGE AFFECTED MUST BE PLACED ON TEMPORARY STANDS.

WATERLINE CONSTRUCTION

- 1. ALL WATER LINE AND FITTING MATERIALS AND THEIR INSTALLATION SHALL COMPLY WITH THE AMERICAN WATERWORKS ASSOCIATION (AWWA) STANDARDS, THE NEW MEXICO STANDARD SPECIFICATIONS FOR PUBLIC WORKS CONSTRUCTION, (NMAPWA) 2006 EDITION, OR SUBSEQUENT REVISIONS, AND THE SANTA FE COUNTY WATER UTILITY CONSTRUCTION STANDARD AND SPECIFICATIONS MANUAL, UNLESS OTHERWISE INDICATED ON THESE DRAWINGS. WHEN CONFLICT ARISES AMONG THESE, THE
- 2. LOCATION OF LINES AND FITTINGS SHALL BE IN ACCORDANCE WITH THE DETAILS SHOWN ON THESE DRAWINGS.
- 3. UNLESS OTHERWISE INDICATED ON THESE DRAWINGS, PIPELINES AND ALL APPURTENANT FITTINGS SHALL BE DUCTILE IRON, PVC C-900, WITH CLASS-D BEDDING OR BETTER. MECHANICAL OR MEGALUG (R) JOINTS, OR THERMAL FUSION JOINING RESPECTIVELY (HDPE). EXCAVATION SHALL BE PROPERLY MADE TO ACCOMMODATE THE PIPE'S BELL ENDS AS NECESSARY. WATERLINES SHALL BE 6" DIAMETER OR LARGER.
- 4. ALL WATER LINES SHALL BE INSTALLED IN THEIR OWN TRENCH, WITH NO OTHER UTILITIES IN THE TRENCH, BURIED UNDER A MINIMUM 48 INCHES OF COMPACTED BACKFILL.
- 5. WHEN CROSSING, WATER LINES SHALL ALWAYS BE ABOVE SEWER LINES, AND A MINIMUM 18-INCH CLEARANCE SHALL BE ALLOWED BETWEEN THE BOTTOM OF THE WATER LINE AND THE TOP OF ANY SANITARY SEWER, UNLESS SPECIAL CROSSING PROVISIONS ARE SHOWN ON THESE DRAWINGS.
- 6. TYPICAL HORIZONTAL SEPARATION BETWEEN WATER LINES AND ANY SANITARY SEWER LINE SHALL BE MINIMUM 10 FEET, AND SEPARATE TRENCHES SHALL BE EXCAVATED IN ALL CASES.
- 7. CONTRACTOR SHALL BE SOLELY RESPONSIBLE FOR DISINFECTION AND PRESSURE TESTING OF ALL NEW WATER LINES, IN ACCORDANCE WITH AWWA STANDARDS. COUNTY UTILITY PERSONNEL SHALL BE PRESENT DURING SUCH TESTING, AND AN INSPECTION REPORT SHALL BE SUBMITTED BY THE CONTRACTOR TO THE COUNTY UTILITIES PRIOR TO FINAL ACCEPTANCE OF THE PROJECT. THE CONTRACTOR SHALL BE RESPONSIBLE FOR COORDINATING WITH THE COUNTY UTILITY STAFF FOR THEIR PRESENCE DURING FIELD TESTING OF LINES. BACTERIA TEST RESULTS OVER 30 DAYS OLD, BY THE COMPLETION OF THE PROJECT SHALL BE RETESTED AT NO ADDITIONAL EXPENSE TO THE OWNER.
- 8. ALL VALVES 12" DIAMETER OR SMALLER SHALL BE FULL-PORT GATE TYPE, RESILIENT SEATING, MECHANICAL OR MEGALUG (R) JOINTS, PIPE, AND INSTALLED IN COMPLIANCE WITH THE COUNTY WATER SYSTEM DETAILS.
- 9. UPON COMPLETION ONE VALVE SHALL BE TIED TO ONE OR MORE OF THE SANTA FE COUNTY'S PERMANENT SURVEY MONUMENTS, (OR OTHER VISIBLE WATER FEATURES OR FIXTURES) SUCH AS FIRE HYDRANTS AND WATER METERS WITH DISTANCES BETWEEN ALL FITTINGS AND APPÙRTENANCES PROVIDED AS REQUIRED IN THE UTILITY DEPARTMENTS CONSTRUCTION STANDARDS AND SPECIFICATIONS MANUAL. THE WORK SHALL BE PERFORMED BE A REGISTERED NEW MEXICO LICENSED SURVEYOR, OR ENGINEER WITH INFORMATION PROVIDED BY THE CONTRACTOR.
- 10. ALL FIRE HYDRANTS SHALL BE SUPPLIED WITH NFP CONNECTORS, AND NUMBERED (NUMBER SUPPLIED BY THE COUNTY FIRE DEPARTMENT). HYDRANTS SHALL BE INSTALLED TO ALLOW A MINIMUM HORIZONTAL CLEARANCE OF 3-FEET ALL AROUND THEM.
- 11. WATER SERVICE CONNECTIONS AND METERS SHALL BE 1-INCH MINIMUM DIAMETER FOR LOTS THAT WILL BE THE SITE FOR RESIDENTIAL BUILDINGS EQUIPPED WITH FIRE SUPPRESSION SYSTEMS. OTHERWISE, CONNECTIONS AND METERS SHALL BE STANDARD 5/8 INCH DIAMETER. METER SETTERS SHALL BE PER STANDARD REQUIRED IN SANTA FE COUNTY UTILITY DEPARTMENT'S
- CONSTRUCTION STANDARDS AND SPECIFICATIONS MANUAL. METERS SHALL BE NEPTUNE T-10 WITH E-CODE, R-9001 REGISTER AND RADIO TRANSMITTER. 12. LOCATE WIRES SHALL BE INSTALLED ON ALL WATER LINES. THE LOCATE WIRE MUST BE VISIBLE IN ALL VALVE VAULTS, MANHOLES OR OTHER ACCESS STRUCTURES. THIS WILL BE VERIFIED DURING THE PRELIMINARY INSPECTION PRIOR TO PAVING. THE LOCATE WIRE SHALL BE A CONTINUOUS, 12 GAUGE, SOLID STRAND INSULATED COPPER WIRE. SPLICES OF THE LOCATE WIRE SHALL FOLLOW THE SPECIFICATIONS IN THE SANTA FE COUNTY UTILITY DEPARTMENT'S CONSTRUCTION STANDARDS AND SPECIFICATIONS MANUAL.
- 13. BLUE CARSONITE MARKERS WITH SFCU I.D. STICKERS ARE REQUIRED ON ALL VALVES AND APPURTENANCES, AND EVERY 300 FEET ALONG PIPELINES
- 14. PURPLE CARSONITE MARKERS WITH I.D. STICKERS ARE REQUIRED ON ALL VALVES AND APPURTENANCES, AND EVERY 300 FEET ALONG PIPELINES THAT ARE NOT IN ROADWAY.

DRY UTILITIES

- 1. SHADING AND BEDDING MATERIAL SHALL BE TYPE IV. CLASS 1 FOR DIRECT BURY CABLE, AND TYPE IV. CLASS 2 FOR CABLE IN CONDUIT. TYPE 111 MATERIAL SHALL BE CONSIDERED SUITABLE FOR EITHER TYPE OF INSTALLATION.
- 2. IF TRENCH-RUN MATERIAL MEETS BACKFILL MATERIAL REQUIREMENTS, 3-INCH BEDDING MAY BE OMITTED, PROVIDED
- THAT THE TRENCH BOTTOM IS SMOOTH, FLAT, AND WITHOUT SURFACE IRREGULARITIES. 3. SEPARATION BETWEEN JACKETED PRIMARY AND COMMUNICATION CABLES SHALL BE AT LEAST 12 INCHES.
- 4. WARNING TAPE SHALL BE PLACED A MINIMUM 12 INCHES ABOVE THE UPPER LEVEL OF UTILITIES AT THE CENTER OF
- THE TRENCH. 5. DRY UTILITY REQUIREMENTS SPECIFIED BY THE RESPECTIVE UTILITY SHALL BE FOLLOWED.

ENVIRONMENTAL EROSION AND SEDIMENT CONTROL REQUIREMENTS

- 1. THE CONTRACTOR SHALL SUBMIT TO THE PROJECT MANAGER AND OR OWNER'S PROJECT REPRESENTATIVE (OPR) A SWPPP PLAN THAT COMPLIES WITH THE 2012 CONSTRUCTION GENERAL PERMIT AND SUBSEQUENT REVISIONS
- 2. AT A MINIMUM, ALL AREAS DENUDED AND/OR DISTURBED BY CONSTRUCTION TRAFFIC SHALL BE SPRAYED WITH WATER
- ON A DAILY BASIS TO CONTROL DUST GENERATION. ADDITIONAL WATER SHALL BE APPLIED ON WINDY DAYS AS NEEDED OR AS REQUIRED BY SANTA FE COUNTY.
- 3. AS SOON AS FINAL GRADES ARE ACHIEVED, AND PROPER CLIMATIC CONDITIONS PREVAIL, NATIVE GRASS SEEDS SHALL BE APPLIED. CONTRACTOR SHALL PERFORM THIS ACTIVITY IN CONFORMANCE WITH THE APPROVED TERRAIN MANAGEMENT PLAN FOR SEED MIX DETAILS, AS WELL AS APPLICATION AND CARE METHODOLOGY.
- 4. GRAVEL BAGS AND OTHER EPA APPROVED DEVICES SHALL BE INSTALLED AROUND DROP INLET GRATES IMMEDIATELY AFTER THEIR INSTALLATION TO PREVENT SEDIMENT FROM ENTERING THE STORM WATER SYSTEM. SEDIMENT DEPOSITED AROUND GRAVEL BAGS AND OTHER EPA APPROVED DEVICES SHALL BE SWEPT AND REMOVED IMMEDIATELY UPON DEPOSITION.
- 5. SILT FENCES OR WADDLES MEETING EPA REQUIREMENTS FOR SEDIMENT CONTROL SHALL BE INSTALLED AT ALL SLOPES IN STRICT ACCORDANCE WITH SWPPP PLAN.
- 6. CONTRACTOR SHALL DISPOSE OF ITEMS DESIGNATED FOR REMOVAL WITHOUT SALVAGE, WHICH ARE UNSUITABLE FOR USE AS CONSTRUCTION MATERIALS IN THIS PROJECT. DISPOSAL SHALL BE PERFORMED IN AN ENVIRONMENTALLY SOUND SITE, SECURED BY THE CONTRACTOR IN CLOSE COORDINATION WITH THE APPROPRIATE REGULATORY AGENCIES. CONTRACTOR SHALL NOTIFY THE PROJECT MANAGER AND OR OPR, IN WRITING, OF ANY RELEVANT DETAILS IN CONNECTION WITH THE DISPOSAL OPERATIONS.
- 7. BORROW MATERIAL, CONSTRUCTION WASTE, VEGETATIVE DEBRIS, ETC SHALL NOT BE PLACED IN WETLAND AREAS ARROYOS, OR ANY AREAS ENDANGERED SPECIÉS, OR HABITAT RESOURCES MAY BE AFFECTED. BORROW AREAS NOT CONTIGUOUS TO THE PROJECT SITE SHALL BE SHOWN
- 8. CONTRACTOR SHALL BE RESPONSIBLE FOR CLEANING UP SPILLS ASSOCIATED WITH THE PROJECT'S CONSTRUCTION ACTIVITIES. CONTRACTOR SHALL REPORT AND PROPERLY RESPOND TO SPILLS OF HAZARDOUS MATERIALS SUCH AS GASOLINE, DIESEL, MOTOR OIL, SOLVENTS, TOXIC AND CORROSIVE SUBSTANCES, AND OTHER MATERIALS WHICH MAY REPRESENT A THREAT TO THE HEALTH AND WELFARE OF HIS WORKERS, THE GENERAL PUBLIC, OR THE ENVIRONMENT, CONTRACTOR SHALL REPORT EVIDENCE OF PAST SPILLS ENCOUNTERED DURING CONSTRUCTION, OR PRESENT SPILLS NOT ASSOCIATED WITH THE CONSTRUCTION OF THIS PROJECT. REPORTS SHALL BE MADE IMMEDIATELY TO THE THE PROJECT MANAGER AND OR OPR AND THE APPROPRIATE STATE AGENCY RESPONSIBLE FOR THE EMERGENCY RESPONSE. CLEAN UP OF ANY UNREPORTED SPILLS THAT MAY HAVE OCCURRED DURING THE CONSTRUCTION OF THIS PROJECT, IDENTIFIED AFTERWARDS SHALL BE THE SOLE RESPONSIBILITY OF THE CONTRACTOR.
- 9. ALL WORK PERFORMED IN THE VICINITY OF EXISTING STREAMS, WATER IMPOUNDMENTS, WETLANDS OR IRRIGATION WATER SOURCES SHALL BE PERFORMED IN SUCH A MANNER AS TO MINIMIZE VEGETATION DAMAGE OR REMOVAL, AS WELL AS ANY SOIL EROSION, CONSTRUCTION EQUIPMENT'S CROSSINGS OF EXISTING STREAMS, WHETHER THE STREAMS ARE EPHEMERAL OR PERENNIAL SHALL BE MINIMIZED, AND IN COMPLIANCE WITH THE CLEAN WATER ACT (CWA), USACE 404, OR OTHER FEDERAL PERMIT REQUIREMENTS.
- 10. ALL WORK PERFORMED IN A FLOOD PLAIN SHALL COMPLY WITH THE SANTA FE COUNTY FLOOD PLAIN ORDINANCE.
- 11. RE-FUELING OPERATIONS AND CONCRETE DUMPING IN THE VICINITY OF ANY BODY OF WATER SHALL BE STRICTLY
- 12. CONTRACTOR SHALL COORDINATED WITH PROJECT ENGINEER TO AVOID DISTURBANCE OF NESTING AREAS IDENTIFIED IN THE PROJECT BIOLOGICAL REPORT AS REQUIRING PROTECTION.
- 13. CONTRACTOR SHALL CONTACT JON GRIEGO, COMPLIANCE OFFICER AT THE CITY OF SANTA FE (505) 955-6516 TO OBTAIN A DUST CONTROL PERMIT.

PUBLIC UTILITY CONTACTS					
CABLE TV	COMCAST	2534 CAMINO ENTRADA, S.F., N.M.	1-505-438-1930	DAVE AIKIN	
TELECOMMUNICATIONS	CENTURYLINK	2701 SAWMILL ROAD, S.F., N.M.	1-505-660-0921	JEFF CORIA	
ELECTRIC	PNM	4645 STATE HWY 14, S.F., N.M.	1-505-469-4010	DENNIS HERNANDEZ	
GAS	GAS CO. of N.M.	6 FOREST LANE, S.F., N.M.	1-505-697-3618	RON CLUFF	
SEWER/WATER/STORM	S.F. CO. PUBLIC WORKS	P.O. BOX 276, S.F., N.M.	1-505-992-3046	ROBERT GEORGE	
SEWER/WATER/STORM	S.F. CO. PUBLIC WORKS	P.O. BOX 276, S.F., N.M.	1-505-992-3046	PAUL CASAUS	

TERRAIN MANAGEMENT AND RE-VEGETATION WORK REQUIREMENTS

- 1. ALL AREAS DISTURBED BY THE CONSTRUCTION ACTIVITIES OF THIS PROJECT, INCLUDING ANY TEMPORARY ACCESS ROAD, SHALL BE RE-GRADED TO THEIR ORIGINAL CONTOURS, AND RE-SEEDED IN ACCORDANCE WITH THE FOLLOWING PLAN AFTER COMPLETION OF THE CONSTRUCTION OPERATIONS.
- 2. CONTRACTOR SHALL BE RESPONSIBLE FOR THE SUCCESSFUL RECOVERY OF DISTURBED AREAS FOLLOWING RE-VEGETATION THROUGH THE FIRST GROWING SEASON AFTER COMPLETION OF THIS PROJECT. IN THE EVENT THAT THE REVEGETATION PLAN CANNOT BE ACCOMPLISHED BEFORE SEPTEMBER 1 DUE TO CONSTRUCTION DELAYS, AND DISTURBED SURFACES MUST REMAIN EXPOSED AFTER THIS DATE, THE CONTRACTOR SHALL INSTALL TEMPORARY PROTECTION SUCH AS A COVER CROP OR A MULCH TO PREVENT SOIL EROSION, AT NO ADDITIONAL COST TO THE OWNER. A TEMPORARY CONSTRUCTION FENCE SHALL BE MAINTAINED AROUND THE DISTURBED AREA UNTIL THE NEW VEGETATION IS ESTABLISHED.
- 3. AREAS WITH A SLOPE LESS THAN 4:1 SHALL BE TREATED WITH DRILL SEEDING, WHILE SLOPES EXCEEDING 4:1 SHALL BE TREATED WITH BROADCAST OR HYDRO SEEDING AND SHALL INCLUDE HAND-RAKING OR CHAIN-HARROWING TO COVER SEED TO A DEPTH OF 1/4-INCH TO 1/2-INCH. SLOPES EXCEEDING 3:1 SHALL BE TREATED WITH THE EROSIN BLANKET, MEETING NMDOT CLASS D SPECIFICATIONS AND IN COMPLIANCE WITH THE EPA'S (CONSTRUCTION GENERAL PERMIT) FOR FINAL STABILIZATION. ALL TOP SOIL WHICH MUST BE REMOVED OR DISTURBED DURING CONSTRUCTION SHALL BE SAVED AND STOCKPILED AT A LOCATION DESIGNATED BY THE OPR. ANY DISTURBED AREA TO BE SEEDED WHICH HAS LESS THAN 6 INCH TOTAL TOP SOIL DEPTH SHALL BE SUPPLEMENTED TO A 6 INCH DEPTH WITH THE STOCKPILED MATERIAL.
- 4. THE SEED BED SHALL BE PREPARED TO A MINIMUM 4-INCH DEPTH BY TILLING WITH A DISC, HARROW, OR CHISELING TOOLS. ALL COMPETITIVE VEGETATION SHALL BE UPROOTED DURING THIS PREPARATION, AND THE SOIL SHALL BE UNIFORMLY WORKED TO A SMOOTH. FIRM SURFACE FREE OF CLODS, STONES OR OTHER EXTRANEOUS MATERIALS 4 INCH OR LARGER THAT WOULD INTERFERE WITH SEEDING EQUIPMENT AND GERMINATION. SEED BED PREPARATION BY MECHANICAL MEANS WILL NOT BE REQUIRED ON SLOPES EXCEEDING 3:1 IF, IN THE OPINION OF THE PROJECT MANAGER AND OR OPR, SEED BED PREPARATION ON THESE SLOPES IS IMPRACTICAL OR UNSAFE. ALL TILLING SHALL BE PERFORMED ACROSS THE SLOPE WHEN PRACTICAL AND SHALL BE PERFORMED IN TWO DIRECTIONS WHENEVER ONE PASS IS INSUFFICIENT, IN THE OPR'S OPINION, TO ADEQUATELY BREAK UP THE SOIL. TILLING SHALL NOT BE PERMITTED WHEN THE WIND BLOWS AT MORE THAN 10 MPH CAUSING DUST GENERATION AND MOVEMENT IN TO ADJACENT AREAS. NO WORK SHALL BE PERFORMED WHEN THE SOIL'S MOISTURE CONTENT IS UNFAVORABLE, OR THE GROUND CONDITIONS ARE NOT SUITABLE FOR TILLING.
- 5. SEED SHALL BE UNIFORMLY APPLIED OVER THE AREA TO BE TREATED. THE CONTRACTOR'S EQUIPMENT SHALL NOT TRAVEL OVER THE SEEDED AREAS. IF RAIN OR OTHER NATURAL PHENOMENA, WHICH MAKE THE SOIL UNSUITABLE FOR SEEDING, THE CONTRACTOR SHALL RE-PREPARE THE SOIL AS DESCRIBED HEREBY AT NO ADDITIONAL COST TO THE OWNER. SEEDS SHALL BE DRILLED TO A MINIMUM OF 1/2-INCH, UNLESS OTHERWISE INDICATED ON THESE DRAWINGS. DIRECTION OF SEEDING SHALL BE ACROSS THE SLOPES AND ON THE CONTOUR WHENEVER POSSIBLE.
- 6. BROADCAST SEEDING SHALL ONLY BE PERFORMED IN SLOPES EXCEEDING 3:1 OR IN AREAS INACCESSIBLE TO THE SEED DRILL. BROADCAST SEEDING SHALL BE PERFORMED WITH A ROTARY SPREADER OR A SEEDER BOX WITH GEAR FEED MECHANISM IF DRILL SEEDING IS NOT PRACTICAL. RICE HULLS OR OTHER FILLERS SHALL BE USED TO PREVENT UNEVEN SEPARATION OF LIGHTER SEED. SEED BED SHALL BE LIGHTLY RAKED IMMEDIATELY FOLLOWING THE SEEDING OPERATION, TO PROVIDE 1/2-INCH SOIL COVER OVER THE SEED.
- 7. MULCH SHALL BE PLACED OVER ALL SEEDED AREAS. THE MULCH SHALL BE MADE OF STRAW OR HAY, AND APPLIED TO PRODUCE A DEPTH OF 1-1/2-INCH TO 2-INCH. STRAW OR HAY WITH NOXIOUS SEEDS OR PLANTS, ROTTED, BRITTLE, SHORT FIBERED, OR IMPROPERLY CURED IS NOT ACCEPTABLE.
- 8. SEED MIX AND SEEDING RATE ARE AS FOLLOWS:


SEED	PERCENTAGE OF SEED MIX
SIDE OATS GRAMA	20%
BLUE GRAMA	30%
LITTLE BLUESTEM	20%
INDIAN RICEGRASS	10%
SHEEP FESCUE	10%
STREAMBANK WHEATGRASS	4%
ALKALI SACATON	3%
GALLETA	3%
WILD FLOWER MIX	5% OF TOTAL SEED WEIGHT

NOTE: POUNDS PER ACRE OF SEED MIXTURE: 15-20 LBS IF DRILLED; 20-25 LBS. IF BROADCAST, SEED SHALL BE CERTIFIED NOXIOUS WEED FREE.

DRYLAND BLEND

- WORKMANSHIP AND MATERIALS SHALL CONFORM TO THE LATEST EDITION OF THE NMDOT'S STANDARD SPECIFICATIONS FOR HIGHWAY AND BRIDGE CONSTRUCTION AND TO THE SUPPLEMENTAL SPECIFICATIONS AND SPECIAL PROVISIONS.
- WORK SHALL BE PERFORMED SO THAT DANGER, INCONVENIENCE, AND DELAY TO THE TRAVELING PUBLIC IS HELD TO A
- PLANS TO PROTECT AND HANDLE TRAFFIC DURING CONSTRUCTION SHALL BE SUBMITTED FOR REVIEW TO NMDOT PRIOR TO CONSTRUCTION
- 4. ALL TEMPORARY TRAFFIC CONTROL ASSOCIATED WITH WORK IN NMDOT RIGHT-OF-WAY MUST FULLY MEET THE REQUIREMENTS OF THE NEW MEXICO DEPARTMENT OF TRANSPORTATION (NMDOT) DISTRICT 1 AND DISTRICT 5.
- STEEL, IRON, AND MANUFACTURED PRODUCTS SHALL BE IN COMPLIANCE WITH BUY AMERICA FOR THIS PROJECT PURSUANT

LEGEND

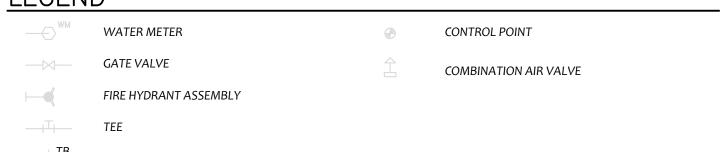

ALUM	ALUMINUM
AV	AIR VALVE
AWWA	AMERICAN WATER WORKS ASSOCIATION
CAV	COMBINATION AIR VALVE
CMP	CORRUGATED METAL PIPE
DIP	DUCTILE IRON PIPE
DPCO	DOUBLE PRESSURE CLEANOUT
DR	DIAMETER RATIO
FO	FIBER OPTIC
FT	FOOT
G	GAS LINE
LF	LINEAR FEET
LOE	LIMIT OF EXCAVATION
MJ	MECHANICAL JOINT
NMDOT	NEW MEXICO DEPARTMENT OF TRANSPORTATION
NTS	NOT TO SCALE
Ø	DIAMETER
OHE	OVERHEAD ELECTRIC
OPR	OWNER'S PROJECT REPRESENTATIVE
PG	PAGE
PVC	POLYVINYL CHLORIDE
ROW	RIGHT OF WAY
SFCO	SANTA FE COUNTY
STA	STATION
T	TELEPHONE

WATERLINES

MOLZENCORBIN

2701 Miles Road SE Albuquerque, New Mexico 87106 505 242 5700 office 505 242 0673 fax MolzenCorbin.com



<u>NOTICE OF EXTENDED PAYMENT PROVISION:</u> IS CONTRACT ALLOWS THE OWNER TO MAKE PAYMENT WITHIN 45 DAYS AFTER SUBMISSION OF AN UNDISPUTED REQUEST FOR PAYMENT

REVISION

SYMBOL:	DATE:	BY:

SANTA FE COUNTY PUBLIC WORKS DEPARTMENT 424 NM 599 *SANTA FE, NM 87507*

PROJECT NAME:

OLD SANTA FE TRAIL ROAD IMPROVEMENTS AND

CONSTRUCTION NOTES AND PUBLIC UTILITY CONTACT INFORMATION

WATERLINE TL2N

APPROVED: | REVIEWED: -SHEET | DATE: NOV., 2014 G-003 DRAWN BY: J.LOVATO

OR CONFLICTS.

DESCRIPTION

JACK AND BORE, 24" STEEL CASING, WITH

12" WATERLINE PIPE, DR18 PVC, INCLUDING

12" CARRIER PIPE, DIP WITH INTEGRAL JOINT

CASING SPACERS AND END SEALS, CIP

TRENCH, COMPACTED BACKFILL,

APPURTENANCES, CIP

APPURTENANCES, CIP

APPURTENANCES, CIP

RESTRAINT, CIP

RESTRAINED JOINTS, FITTINGS, AND

8" WATERLINE, DR18 PVC, INCLUDING

RESTRAINED JOINTS, FITTINGS, AND

6" WATERLINE, DR18 PVC, INCLUDING

RESTRAINED JOINTS, FITTINGS, AND

ROCK EXCAVATION, FOR TRENCH TO

UNSUITABLE MATERIAL, SUPPLY AND

HAULING OF IMPORTED BACKFIL MATERIAL

INSTALL WATERLINE, REMOVAL OF

PLACEMENT AND COMPACTION, CIP

CLEARING AND GRUBBING

12" GATE VALVE AND BOX

8" GATE VALVE AND BOX

6" GATE VALVE AND BOX

Asphalt Pavement Removal and Replacement

16" LINE STOP

CONNECTION

PREP, CIP

TRAFFIC CONTROL

801000 | CONSTRUCTION STAKING

603280 SWPPP/NPDES PERMIT

ALTERNATE#1

Additive Alternate #1

Waterline Improvements

NO.

AIR/VACUUM VALVE AND BOX

ENVIRONMENTAL MONITERING

801XXX UTILITY RELOCATION ALLOWANCE

801012 MATERIAL TESTING ALLOWANCE

MOBILIZATION/DEMOBILIZATION

6" STUBOUT FOR FUTURE FIRE HYDRANT

3" SP IV A SPHALT PA VEMENT REMOVAL,

TACK COAT, BASE COURSE, AND GRADE

DISPOSAL, AND REPLACEMENT, INCLUDING

DESCRIPTION

FIRE HYDRANT ASSEMBLY, ATTACH TO

PROTECTIVE BOLLARDS FOR EACH FIRE

618000 TRAFFIC CONTROL ADDITIVE ALTERNATE #1

MOBILIZATION/DEMOBILIZATION ADDITIVE

EXISTING STUBOUT, 5'BURY, CIP

HYDRANT (3 PER HYDRANT)

TRENCH, COMPACTED BACKFILL,

TRENCH, COMPACTED BACKFILL,

UNIT

LF

LF

LF

LF

ACRE

EA

EA

EA

EA

EA

EA

ALLOW

LS

LS

ALLOW

ALLOW

LS

LS

UNIT

EA

EA

ESTIM QUANT

85

7300

100

550

110

100

1.78

17

9

11

8

11

850

ESTIM QUANT

11

33

Base Bid

ITEM

NO.

11

12

Miscellaneous

Waterline Improvements

SUMMARY OF WATERLINE QUANTITIES
SOMMAN IN OF WATERLINE QUANTITIES

SUMMARY OF ROADWAY QUANTITIES

Additive	Alternate #2		
ITEM NO.	DESCRIPTION	UNIT	ESTIM QUANT
Waterline	e Improvements	10.5	1 1 1 2 1 1 1 1
23	FIRE HYDRANT ASSEMBLY WITH STUBOUT, ERASE ITEM NUMBER 13 IN BASE BID, 5' BURY, CIP	EA	11
24	PROTECTIVE BOLLARDS FOR EACH FIRE HYDRANT (3 PER HYDRANT)	EA	33
621000	MOBILIZATION/DEMOBILIZATION ADDITIVE ALTERNATE #1	LS	1
618000	TRAFFIC CONTROL ADDITIVE ALTERNATE#1	LS	1

ditive Altern	ate #3	
ГЕМ		0.000
NO.	DESCRIPTION	UNIT

NO.	DESCRIPTION	UNIT	ESTIM QUANT
Waterline	e Improvements		
25	MASTER METER, CIP	LS	1
26	SERVICE CONNECTION	LS	1
27	PNM CONNECTION ALLOWANCE	ALLOW	1
621000	MOBILIZATION/DEMOBILIZATION ADDITIVE ALTERNATE #1	LS	1
618000	TRAFFIC CONTROL ADDITIVE ALTERNATE#1	LS	1

ITEM NO.	DESCRIPTION	UNIT	ESTIM QUANT
Multimod	lal Improvements		
207000	SUBGRADE PREP, 12"	SY	9285
208XXX	GRA DING < 2'	SY	5200.0
208XXX	SITE CLEARING AND GRUBBING	ACRE	4.86
303160	A GGREGATE BASE COURSE, 6"	SY	8860
423282	A SPHALT PA VEMENT, 3"	SY	8860
423282	A SPHALT PAVEMENT, DRIVEWAYS	SY	425
423XXX	SAWCUT ASPHALT CONCRETE	LF	11650
423XXX	REMOVE AND DISPOSE EXISTING A SPHALT	SY	3900
570024	CULVERT PIPE, 24"	EA	15
570025	CULVERT PIPE END SECTION, 24"	EA	2
570031	CULVERT PIPE END SECTION, 30"	EA	2
570XXX	CULVERT PIPE, 12"	LF	5
570XXX	CULVERT PIPE END SECTION, 12"	EA	1
570XXX	REMOVE EXISTING CULVERT	LF	205
602000	NEW RIPRAP, 8" NOM. DIAMETER	CY	25
602XXX	REMOVE, SALVAGE, AND RELOCATE EXISTING RIPRAP	CY	20
606000	GUARD RAIL	LF	260
606100	METAL BARRIER END TREATMENTS	EA	6
607220	FENCE RELOCATION	LF	760
609500	STANDARD CURB AND GUTTER	LF	677
623XXX	DROP INLET TYPE "D"	EA	1
632000	SEEDING	ACRE	2.00
663XXX	TELEPHONE PEDESTAL RELOCATION	EA	9
667XXX	RELOCATION OF MAILBOXES	EA	3
701015	RADAR TRAFFIC CONTROL SIGNS	EA	2
701031	REMOVE AND RELOCATE TRAFFIC SIGNS	EA	20
701XXX	INSTALL NEW TRAFFIC SIGNS	EA	26
704700	THERMOPLASTIC MARKING, 4", WHITE	LF	12300
704769	RETROREFLECTIVE THRU ARROW, WHITE	EA	13
704782	RETROREFLECTIVE BICYCLE MARKING, WHITE	EA	13
Miscellan	neous		
603280	SWPPP	LS	1
618000	TRA FFIC CONTROL	LS	1
621000	MOBILIZATION	LS	1
801000	CONSTRUCTION STAKING	LS	1
801XXX	PRE-AUTHORIZED WORK & CHANGES	ALLOW	1
127 - 157 - 14 - 15 - 17 - 17 - 17 - 17 - 17 - 17 - 17		LOVING SELECTION	

801012	MATERIAL TESTING ALLOWANCE	ALLOW	1
Add Alte	rnate #1		
ITEM NO.	DESCRIPTION	UNIT	ESTIM QUANT
Multimod	lal Improvements		
401000	SLURRY SEAL	SY	20905
704700	THERMOPLASTIC MARKING, 6", WHITE	LF	12300
704700	THERMOPLA STIC MARKING, 4", YELLOW	LF	12500

ALLOW

801XXX UTILITY RELOCATION ALLOWANCE

MOLZENCORBIN

2701 Miles Road SE Albuquerque, New Mexico 87106 505 242 5700 office 505 242 0673 fax MolzenCorbin.com

NOTICE OF EXTENDED PAYMENT PROVISION: HIS CONTRACT ALLOWS THE OWNER TO MAKE PAYMENT WITHIN 45 DAYS AFTER SUBMISSION OF AN UNDISPUTED REQUEST FOR PAYMENT

REVISION SYMBOL: DATE:



PROJECT NAME:


APPROVED: -

OLD SANTA FE TRAIL **ROAD IMPROVEMENTS** ANDWATERLINE TL2N

SUMMARY OF **QUANTITIES**

DATE: NOV., 2014 G-004 DRAWN BY: J.LOVATO


REVIEWED:

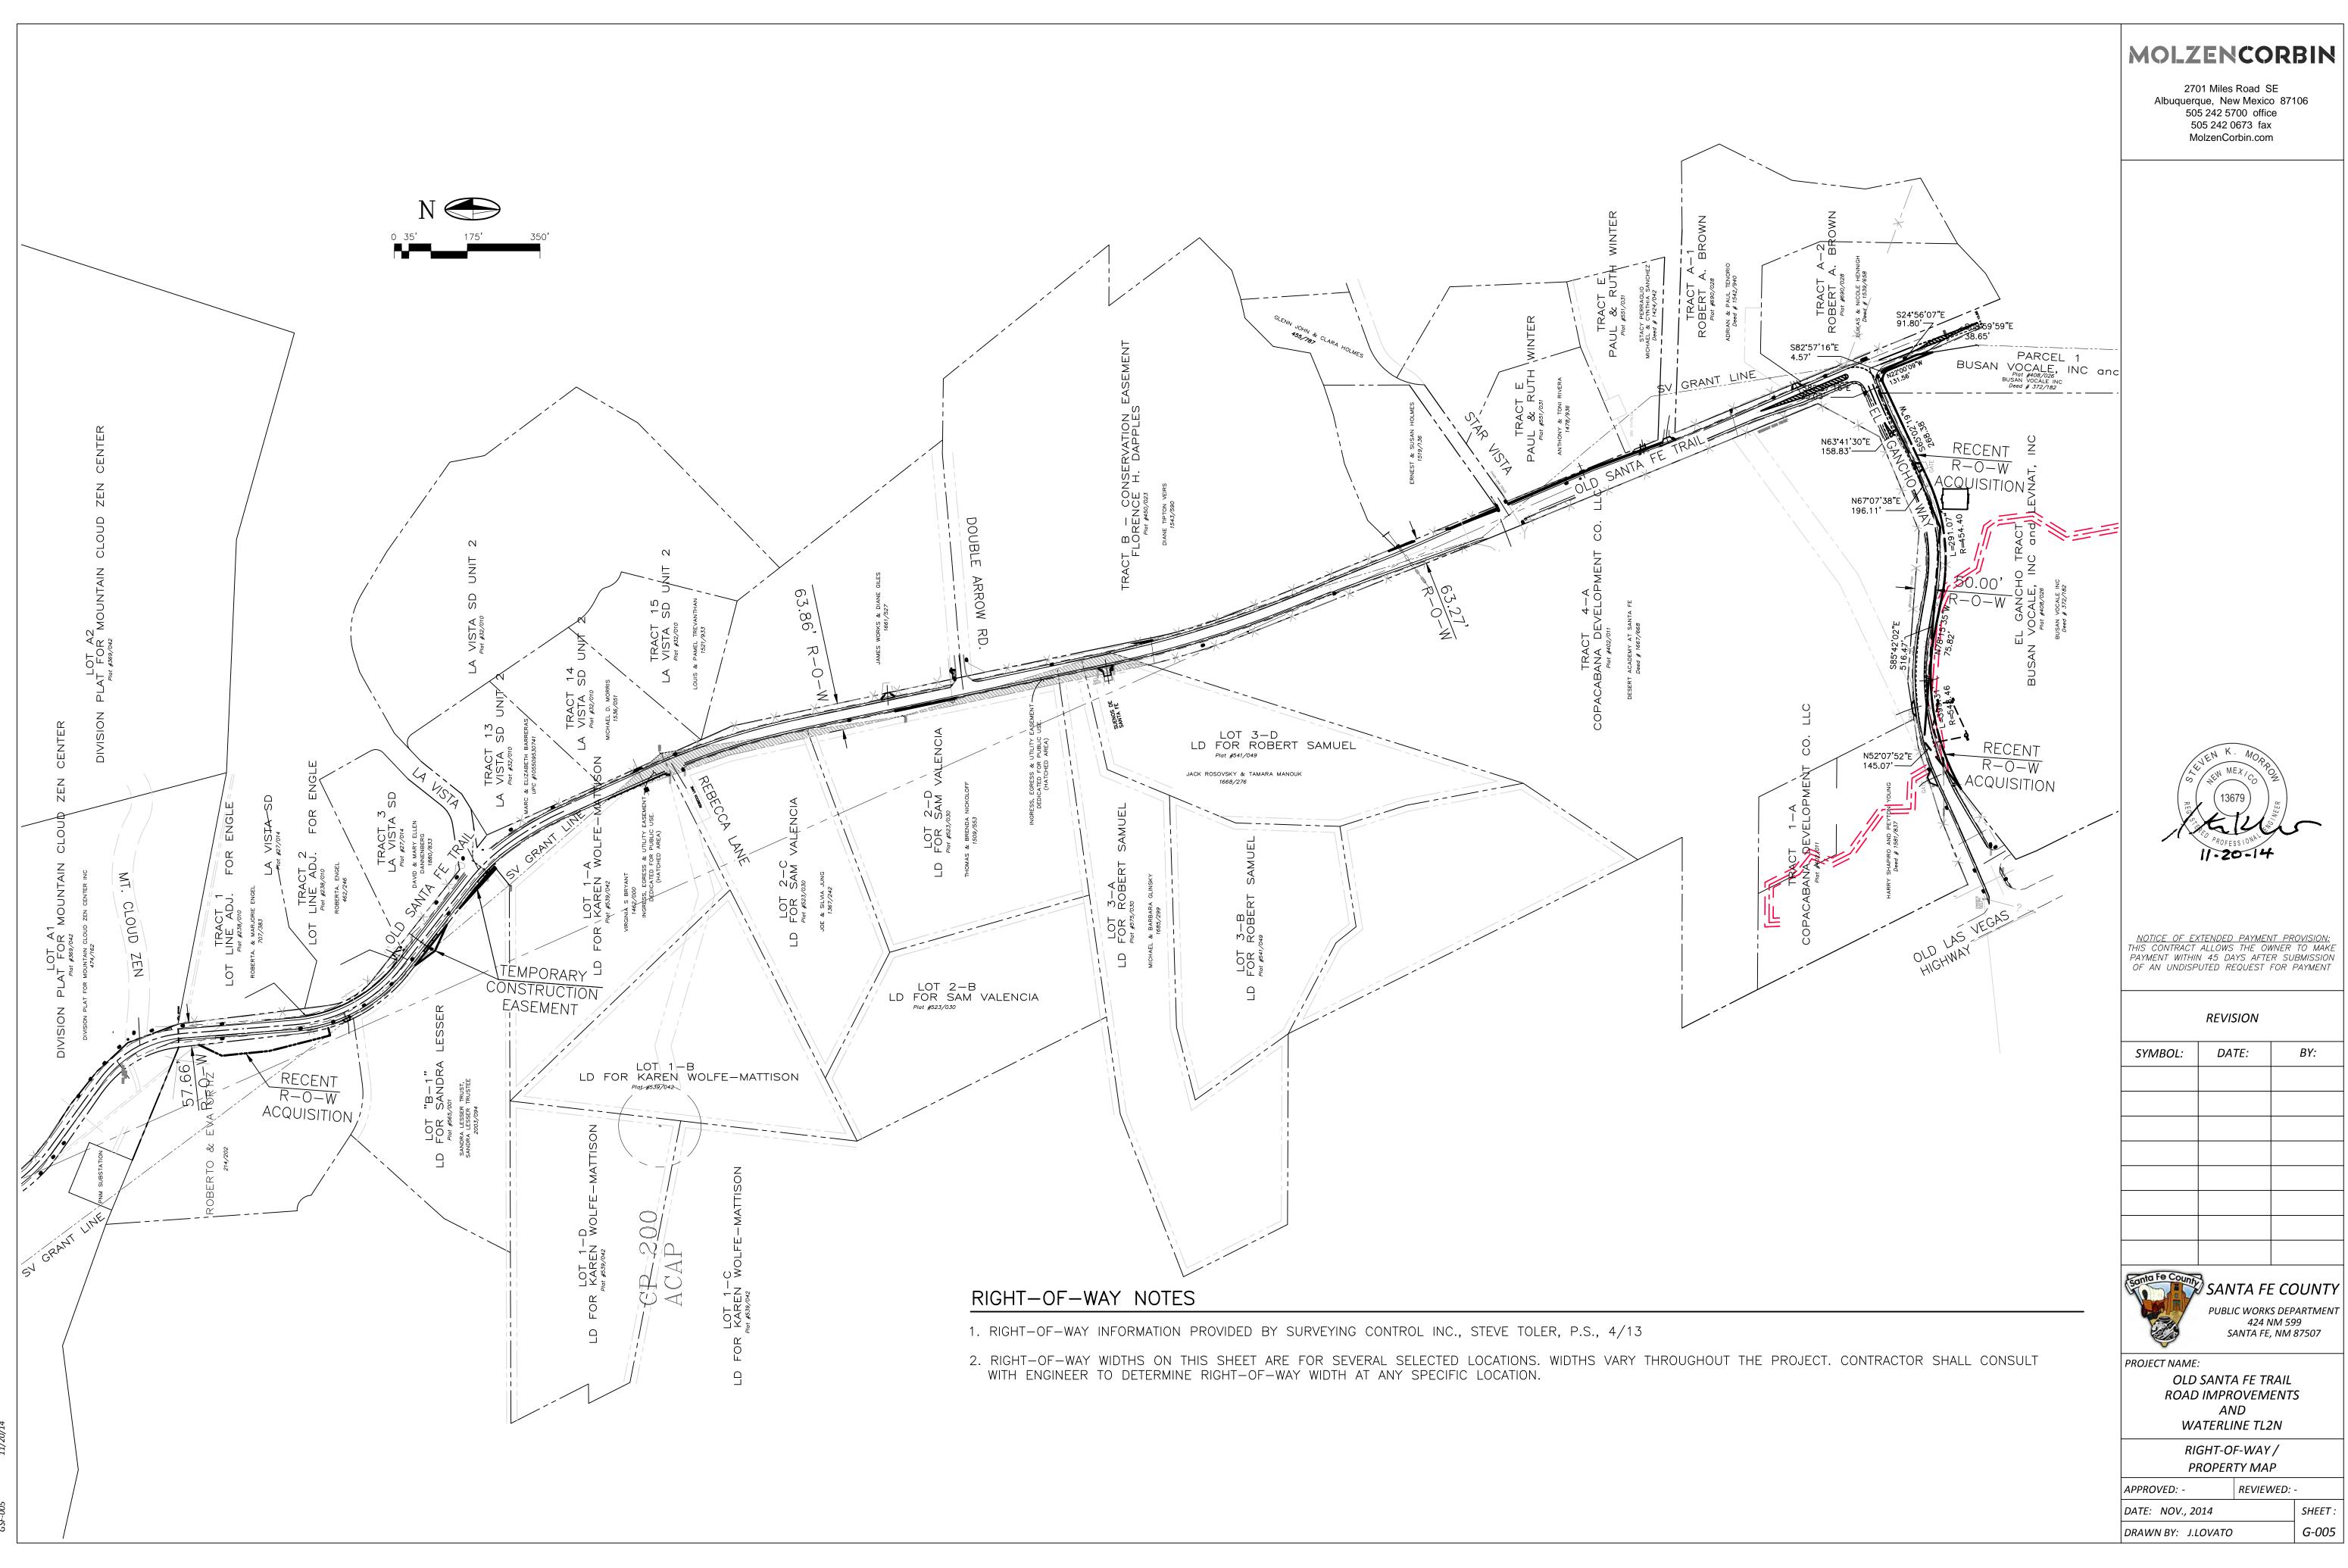

SYMBOL:	DATE:	BY:



SHEET :

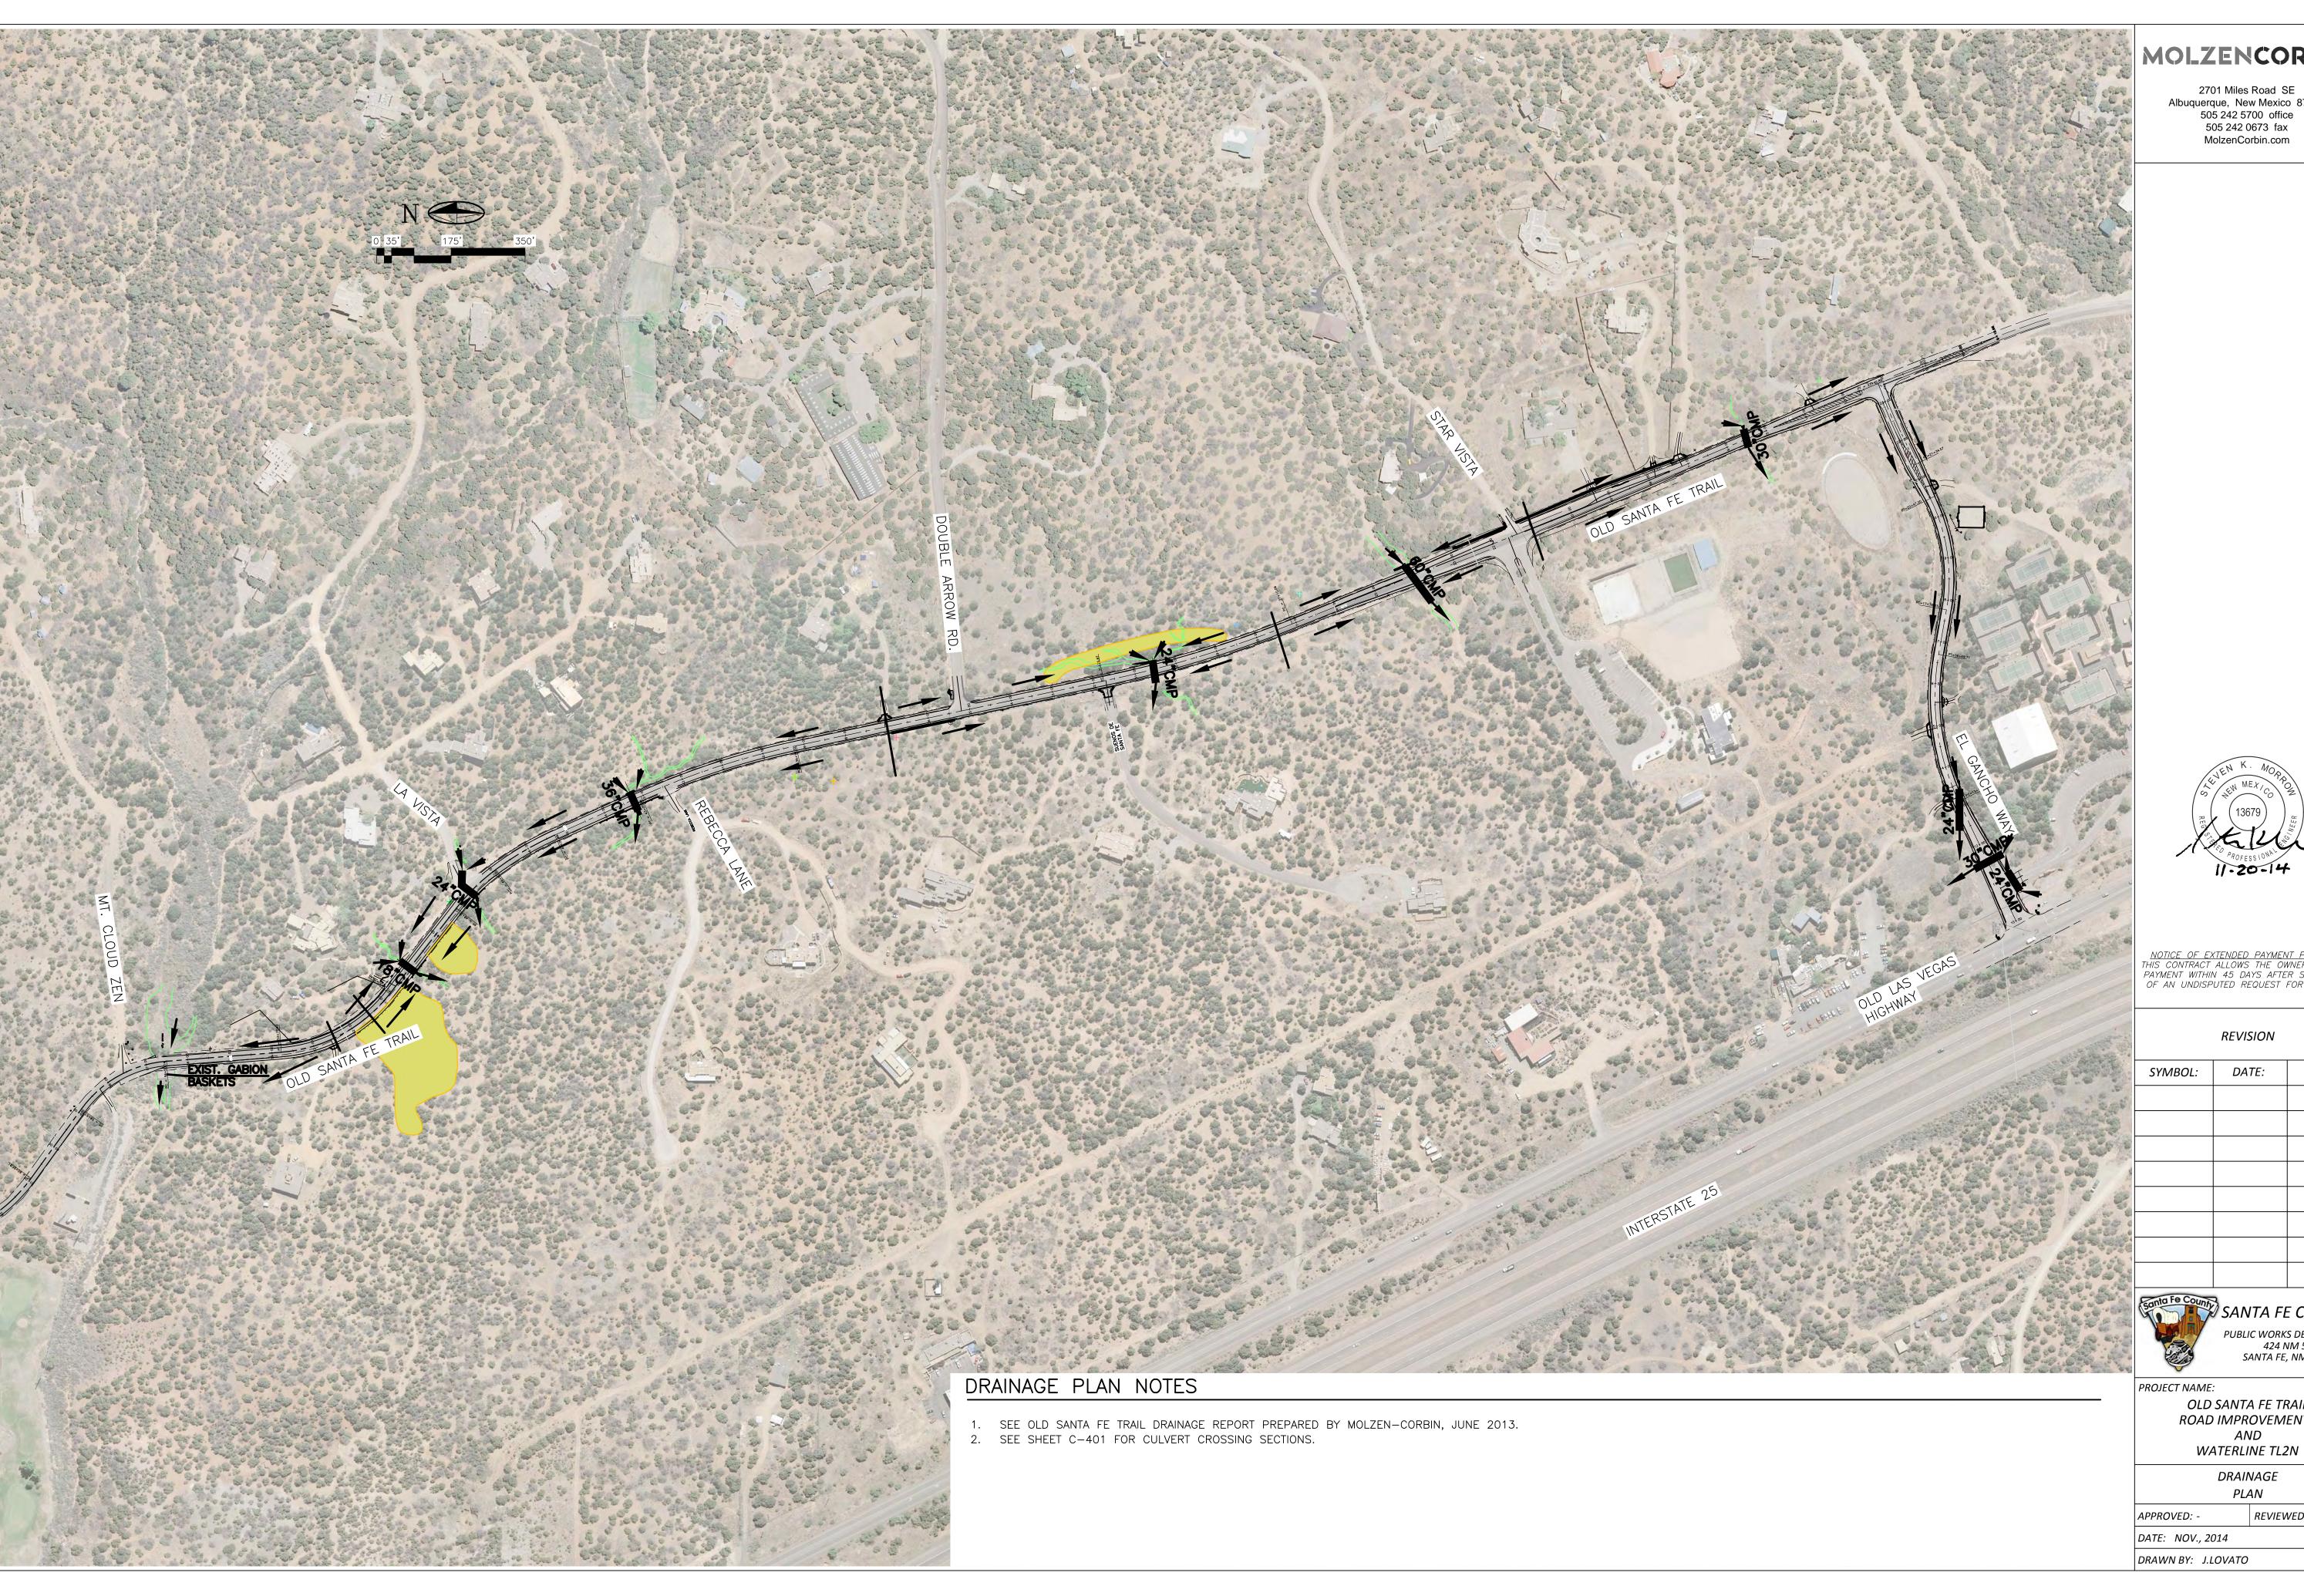

2701 Miles Road SE Albuquerque, New Mexico 87106 505 242 5700 office 505 242 0673 fax MolzenCorbin.com



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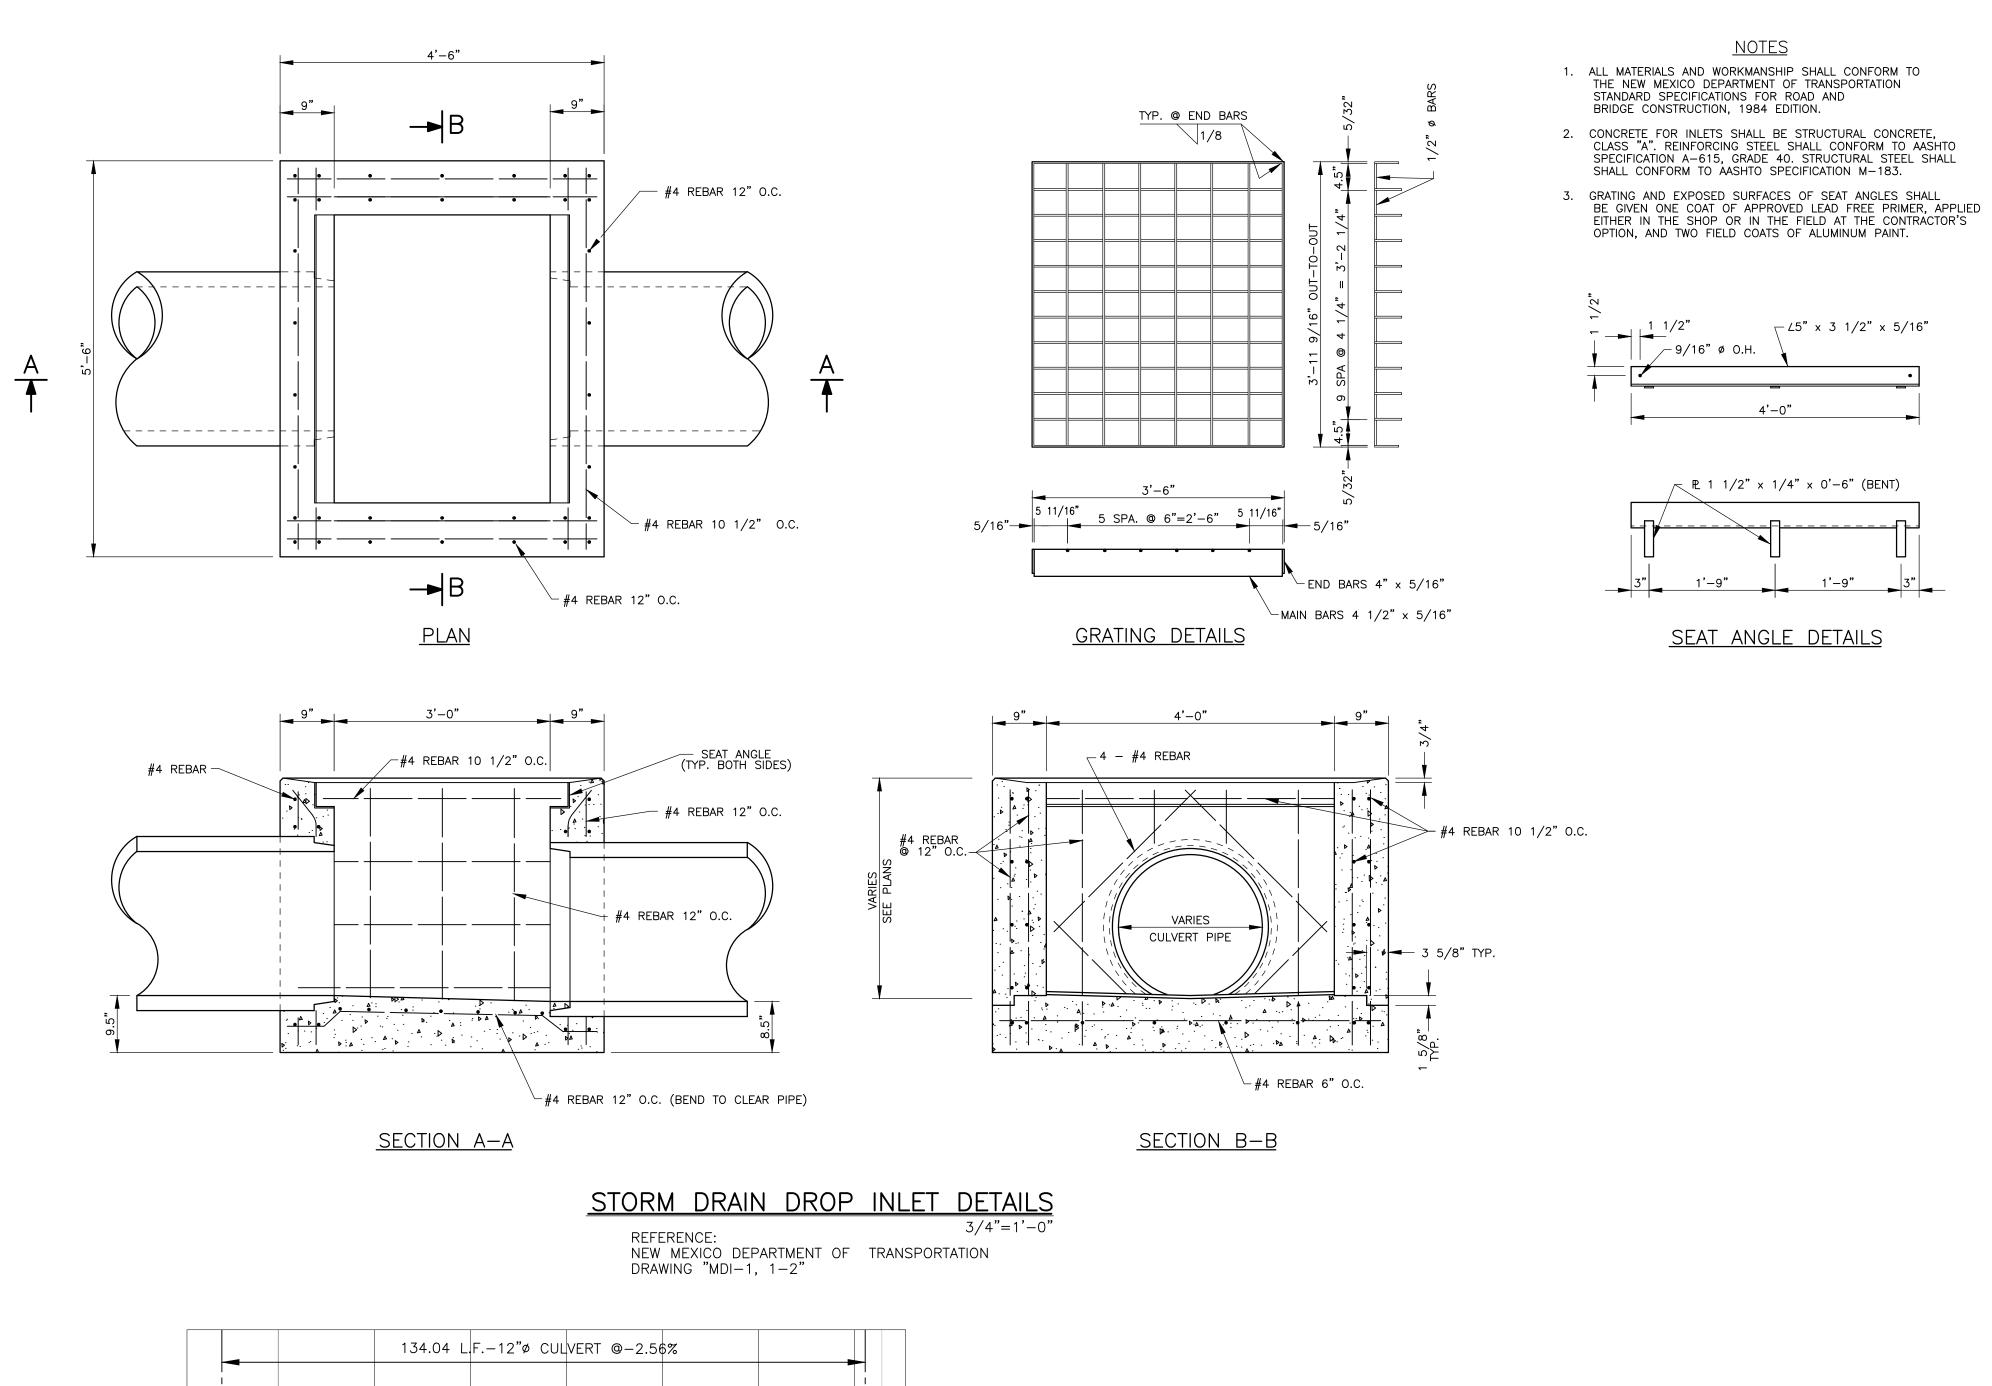



OLD SANTA FE TRAIL ROAD IMPROVEMENTS


DRAINAGE


REVIEWED: -

G-006



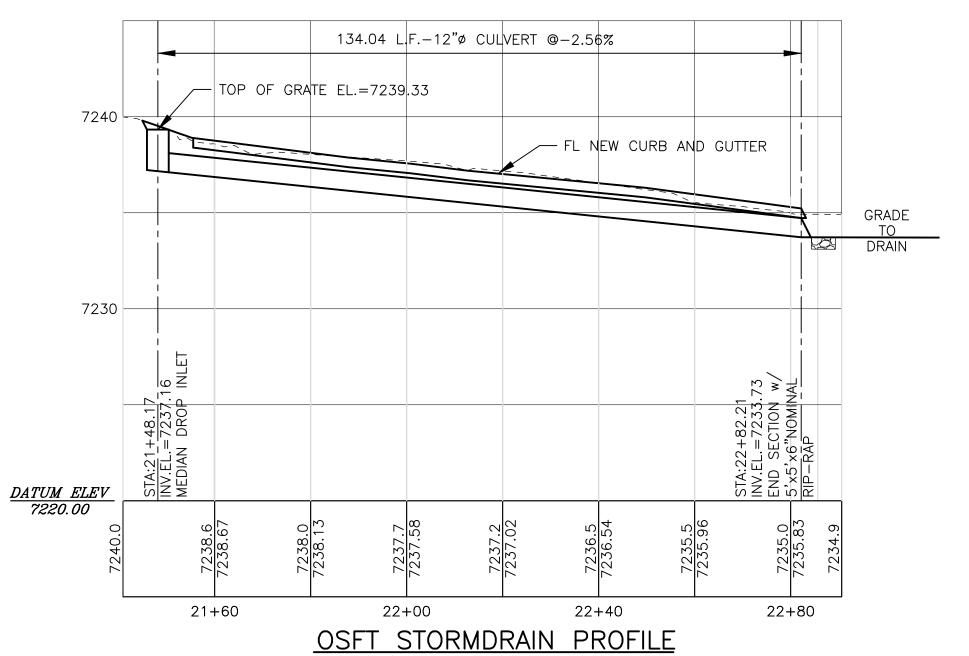

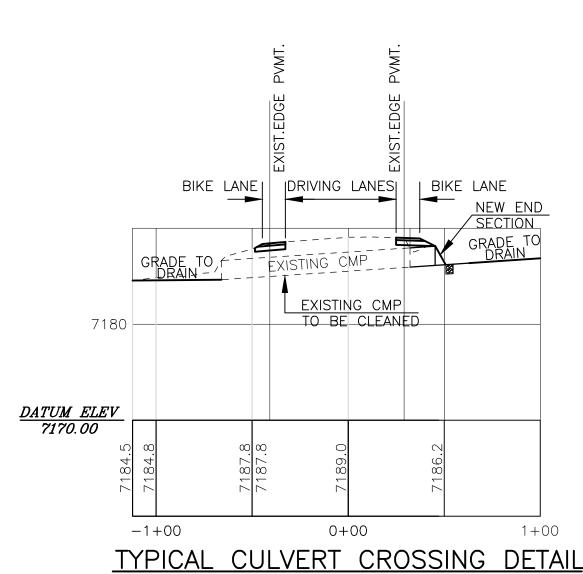

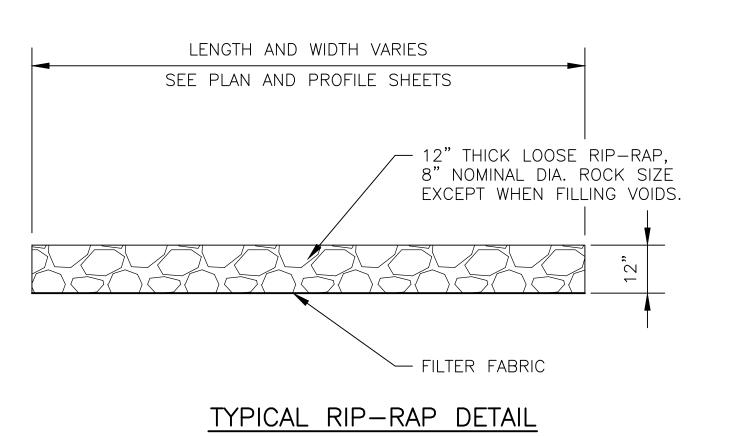

2701 Miles Road SE
Albuquerque, New Mexico 87106
505 242 5700 office
505 242 0673 fax
MolzenCorbin.com



NOTICE OF EXTENDED PAYMENT PROVISION:
THIS CONTRACT ALLOWS THE OWNER TO MAKE
PAYMENT WITHIN 45 DAYS AFTER SUBMISSION
OF AN UNDISPUTED REQUEST FOR PAYMENT

REVISION			
SYMBOL:	DATE:	BY:	

SANTA FE COUNTY

PUBLIC WORKS DEPARTMENT
424 NM 599
SANTA FE, NM 87507

PROJECT NAME:

OLD SANTA FE TRAIL

ROAD IMPROVEMENTS


AND

WATERLINE TL2N

DRAINAGE
DETAILS

APPROVED: - REVIEWED: -

DATE: NOV., 2014 SHEET:
DRAWN BY: J.LOVATO G-007

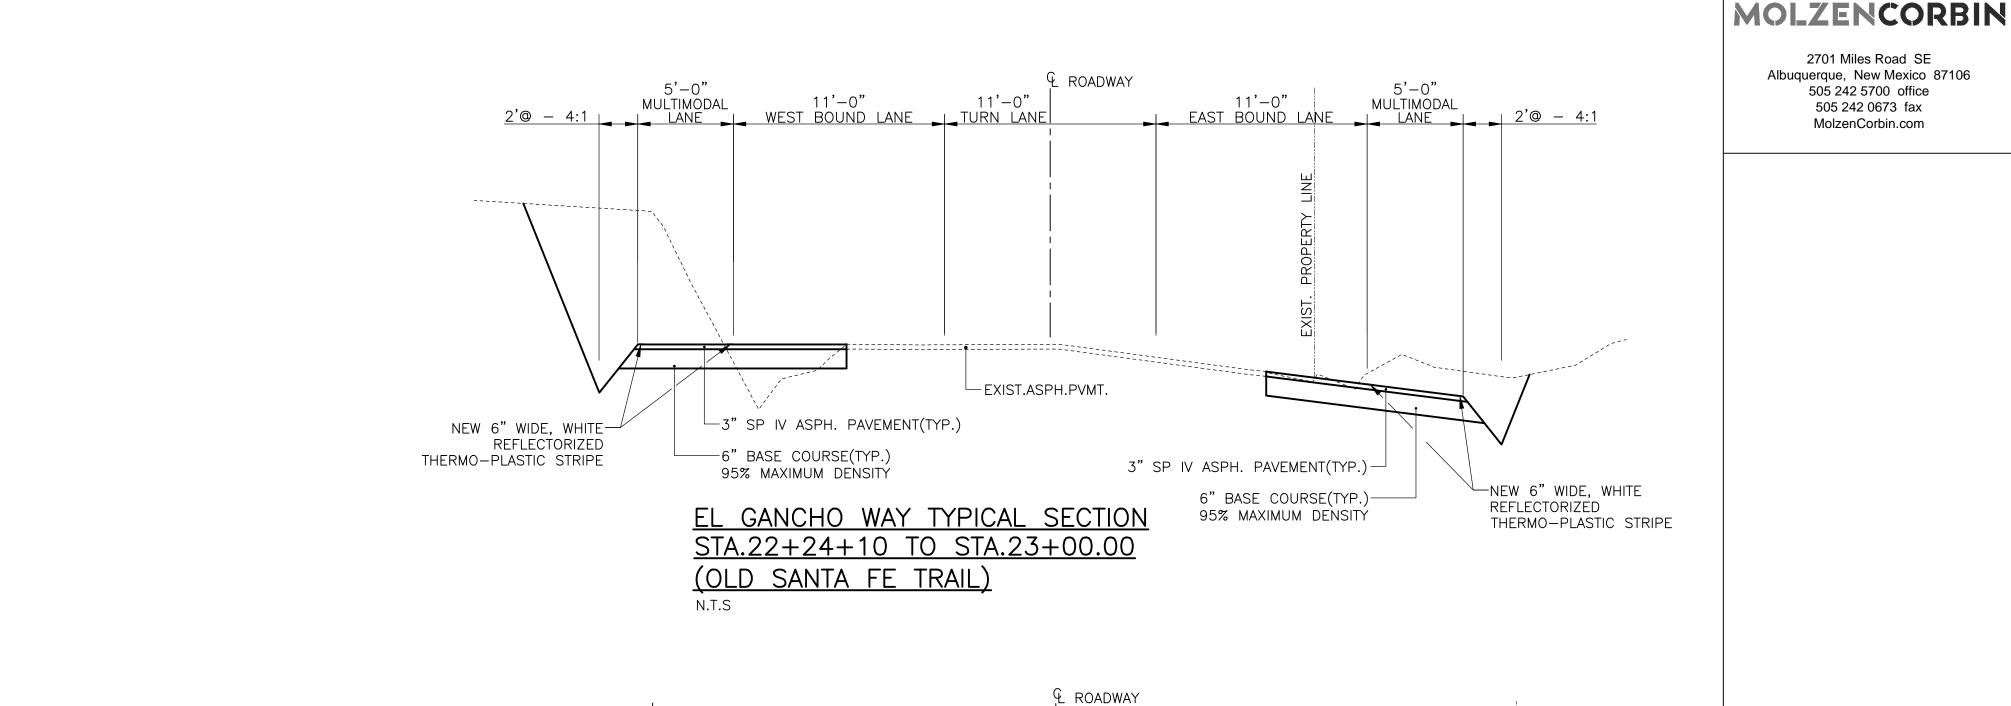

11'-0" DRIVING LANE

-EXIST.EDGE PVMT

-3" SP IV ASPH. PAVEMENT(TYP.)

-6" BASE COURSE(TYP.) 95% MAXIMUM DENSITY

- EXISTING STRIPE

SEE SAWCUT

DETAIL BELOW

MATCH EXIST SLOPE

 \sqsubseteq EXIST.ASPH.PVMT.


MULTIMODAL

LANE


NEW 6" WIDE, WHITE-

THERMO-PLASTIC STRIPE

REFLECTORIZED

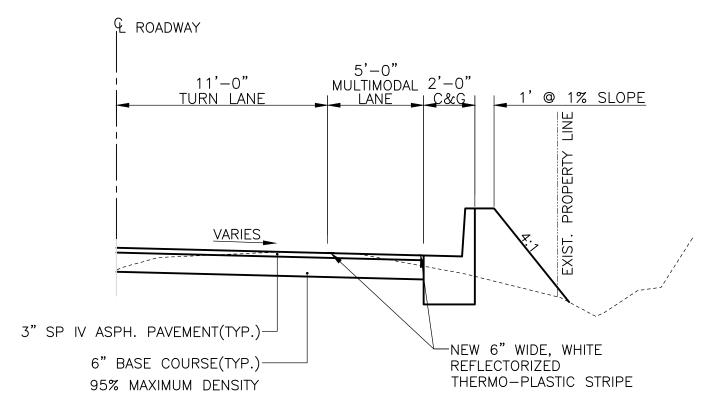

OLD SANTA FE TRAIL TYPICAL SECTION STA.17+36.52 TO STA.21+29.03(CURB ON RIGHT SIDE) STA.21+55.18 TO STA.22+82.19(CURB ON RIGHT SIDE) STA.35+41.00 TO STA.36+91.03(CURB ON LEFT SIDE) STA.50+71.97 TO STA.53+36.61(CURB ON RIGHT SIDE)

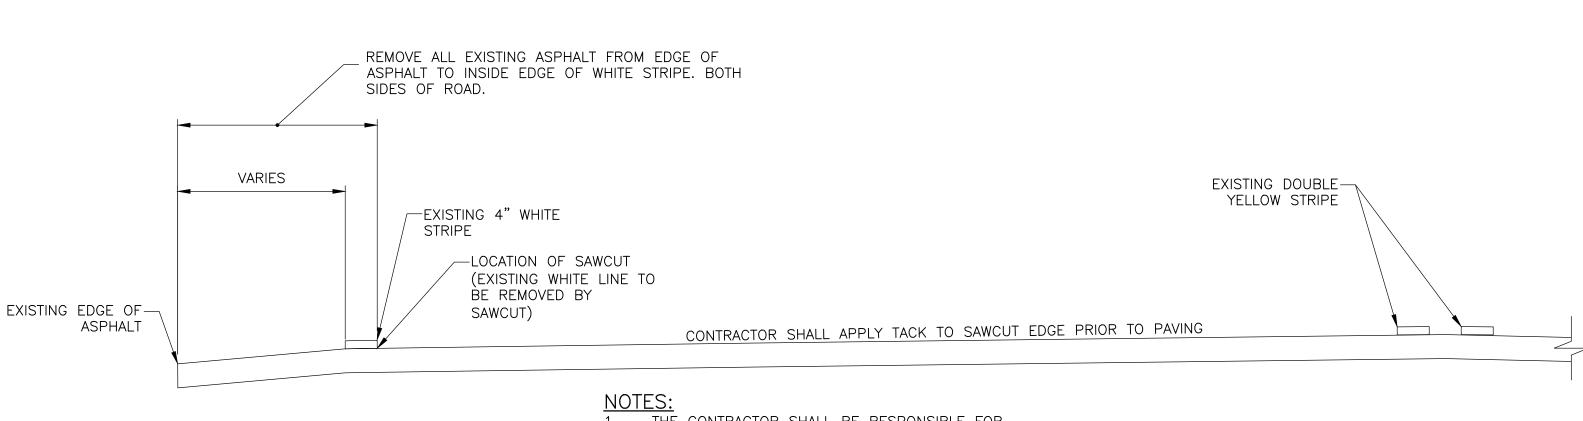

4 ROADWAY 11'-0" 11'-0" 11'-0" TURN LANE TURN LANE TURN LANE EXISTING -EXISTING STRIPE STRIPE — EXIST.ASPH.PVMT. ☐3" SP IV ASPH. PAVEMENT(TYP.) -6" BASE COURSE(TYP.) 95% MAXIMUM DENSITY

> OLD SANTA FE TRAIL TYPICAL SECTION STA.10+91.50 TO STA.11+71.39

- THE CONTRACTOR SHALL BE RESPONSIBLE FOR REPLACING ANY ASPHALT THAT IS DAMAGED DURING CONSTRUCTION.
- CONTRACTOR MAY NOT SAWCUT EXISTING ASPHALT MORE THAN 3 DAYS BEFORE PLACING NEW ASPHALT PAVING.
- ERADICATION OF EXISTING PAVEMENT MARKINGS SHALL MEET THE MUTCD STANDARDS.

SAWCUT DETAIL



2701 Miles Road SE Albuquerque, New Mexico 87106

505 242 5700 office

505 242 0673 fax

MolzenCorbin.com

NOTICE OF EXTENDED PAYMENT PROVISION: HIS CONTRACT ALLOWS THE OWNER TO MAKE PAYMENT WITHIN 45 DAYS AFTER SUBMISSION OF AN UNDISPUTED REQUEST FOR PAYMENT

REVISION			
SYMBOL:	DATE:	BY:	
canta Fe County	3		



PROJECT NAME: OLD SANTA FE TRAIL **ROAD IMPROVEMENTS** AND

> TYPICAL ROADWAY **SECTIONS**

WATERLINE TL2N

APPROVED: -REVIEWED: -DATE: NOV., 2014 SHEET: G-008 DRAWN BY: J.LOVATO

N.T.S

MULTIMODAL

-NEW 6" WIDE, WHITE

REFLECTORIZED
THERMO-PLASTIC STRIPE

EXIST.EDGE PVMT-

MATCH EXISTING-CROSS SLOPE

EXISTING STRIPE -

MATCH EXIST SLOPE

STA.10+00.00 TO STA.20+47.20(EL GANCHO WAY)

STA.15+03.07 TO STA.17+36.52(OLD SANTA FE TRAIL)

STA.26+02.48 TO STA.35+41.00(OLD SANTA FE TRAIL)

STA.36+91.03 TO STA.50+71.97(OLD SANTA FE TRAIL)

STA.53+36.62 TO STA.56+67.67(OLD SANTA FE TRAIL)

SEE SAWCUT

DETAIL BELOW

TYPICAL MULTIMODAL LANE TYPICAL SECTION

ENVIRONMENTAL COMMITMENTS SANTA FE COUNTY C5111204 OLD SANTA FE TRAIL

THE CONTRACTOR SHALL REFER TO SECTION 107 OF 2014 EDITION OF THE NMDOT STANDARD SPECIFICATIONS FOR HIGHWAY DESIGN AND BRIDGE CONSTRUCTION MAKING SPECIAL NOTE OF SUB-SECTION107.14

CONTRACTOR'S RESPONSIBILITIES FOR ENVIRONMENTAL AND CULTURAL RESOURCE APPROVAL.

NO ADDITIONAL PROJECT SPECIFIC ENVIRONMENTAL REQUIREMENTS APPLY

IN ADDITION TO SECTION 107, THE FOLLOWING PROJECT-SPECIFIC ENVIRONMENTAL REQUIREMENTS APPLY

- 1. THE CONTRACTOR SHALL INSTALL TEMPORARY FENCING AS IDENTIFIED IN THE PLANS TO EXCLUDE CONSTRUCTION ACTIVITIES IN AREAS CONTAINING THE HISTORIC ROAD/TRAIL ALIGNMENT, A DESCANSO, THE 1910 SANTA FE NATIONAL HISTORIC TRAIL (SFNHT) ROADSIDE MARKER, AND A SURVEY BENCHMARK. THE NMDOT ENVIRONMENTAL SECTION REQUIRES THE FENCING BE INSTALLED IN CONJUNCTION WITH A QUALIFIED ARCHAEOLOGIST. THE CONTRACTOR AND SANTA FE COUNTY SHALL ENSURE A QUALIFIED ARCHAEOLOGIST IS PRESENT DURING FENCING.
- 2. IN THE EVENT THAT CULTURAL RESOURCE MATERIALS AND/OR HUMAN REMAINS ARE UNCOVERED DURING CONSTRUCTION OR EARTH-DISTURBING ACTIVITIES, THE CONTRACTOR SHALL IMMEDIATELY CEASE WORK IN THE AREA AND SHALL, IN COORDINATION WITH SANTA FE COUNTY, IMMEDIATELY NOTIFY THE NEW MEXICO DEPARTMENT OF TRANSPORTATION (NMDOT) ENVIRONMENTAL SECTION AND THE STATE HISTORIC PRESERVATION OFFICER (SHPO). IF BURIED ARCHEOLOGICAL OR CULTURAL DEPOSITS ARE DISCOVERED DURING CONSTRUCTION, WORK IN THE AREA SHALL CEASE WHILE THE SHPO, THE NMDOT, AND SANTA FE COUNTY ARE CONSULTED.
- 3. THE CONTRACTOR SHALL NOT TAKE MIGRATORY BIRDS, OCCUPIED NESTS, AND EGGS DURING THE PROJECT. IF CLEARING OF SHRUBS OR TREES BEGINS BETWEEN MARCH 1ST AND OCTOBER 15TH, THEN SANTA FE COUNTY SHALL CONDUCT A PRE-CONSTRUCTION NESTING BIRD SURVEY AND SUBMIT A LETTER REPORT TO THE NMDOT ENVIRONMENTAL DIVISION (GWYNETH DUNCAN 505-827-0751) AT LEAST 2 WEEKS PRIOR TO CONSTRUCTION. VACATED NESTS SHALL BE REMOVED DURING THE NON-NESTING SEASON (OCTOBER 16TH FEBRUARY 28TH). IF THE GRAY VIREO IS PRESENT AND NESTING, THEN SANTA FE COUNTY SHALL ALSO COORDINATE WITH THE NEW MEXICO DEPARTMENT OF GAME AND FISH PRIOR TO COMMENCEMENT OF CONSTRUCTION.
- 4. THE ARROYOS WITHIN THE PROJECT AREA QUALIFY AS WATERS OF THE UNITED STATES. THE CONTRACTOR SHALL COMPLY WITH ALL GENERAL AND REGIONAL CONDITIONS FOR THE USE OF THE U.S. ARMY CORPS OF ENGINEERS NATIONWIDE PERMIT 14 (LINEAR TRANSPORTATION PROJECTS) FOR PROJECT AREA IMPACTS TO WATERS OF THE UNITED STATES (CLEAN WATER ACT SECTION 404). THE CONTRACTOR SHALL COMPLY WITH ALL CONDITIONS OF THE NEW MEXICO ENVIRONMENT DEPARTMENT SURFACE WATER QUALITY BUREAU WATER QUALITY CERTIFICATION (CLEAN WATER ACT SECTION 401). THE PROJECT WILL FILL LESS THAN 1/10 ACRE OF WATERS OF THE UNITED STATES, AND NO SPECIAL AQUATIC SITES OR WETLANDS ARE PRESENT AT ANY ARROYO LOCATION. PRECONSTRUCTION NOTIFICATION TO THE U.S. ARMY CORPS OF ENGINEERS AND TO THE NEW MEXICO ENVIRONMENT DEPARTMENT IS NOT REQUIRED.
- 5. THE CONTRACTOR SHALL AVOID REFUELING OR STORING FUELS AND EQUIPMENT WITHIN THE 100-YEAR FLOODPLAIN. THE CONTRACTOR SHALL UTILIZE STANDARD BEST MANAGEMENT PRACTICES DURING CONSTRUCTION TO PREVENT IMPACTS TO SOILS AND SURFACE WATERS THAT COULD RESULT IN INDIRECT WATER QUALITY IMPACTS AS IS FEASIBLE FOR EXPECTED SEASONAL FLOWS.
- 6. THE CONTRACTOR SHALL MINIMIZE VEGETATION AND SOIL DISTURBANCE FOR ALL LOCATIONS WHERE EQUIPMENT WILL BE PARKED DURING CONSTRUCTION, AND THE CONTRACTOR SHALL ACQUIRE ENVIRONMENTAL AND CULTURAL RESOURCES CLEARANCES FOR THESE SITES IN ACCORDANCE WITH SECTION 107.14 OF THE 2007 EDITION OF THE NMOOT STANDARD SPECIFICATIONS FOR HIGHWAY AND BRIDGE CONSTRUCTION.
- 7. THE CONTRACTOR SHALL COMPLY WITH NEW MEXICO DEPARTMENT OF GAME AND FISH TRENCHING GUIDELINES.
- 8. THE PROJECT WILL DISTURB MORE THAN ONE ACRE OF GROUND. THE CONTRACTOR SHALL COMPLY WITH THE U.S. ENVIRONMENTAL PROTECTION AGENCY (EPA) NATIONAL POLLUTANT DISCHARGE ELIMINATION SYSTEM (NPDES) CONSTRUCTION GENERAL PERMIT (CGP) PERMITTING (CLEAN WATER ACT SECTION 402). THE CONTRACTOR SHALL PREPARE AND IMPLEMENT A STORM WATER POLLUTION PREVENTION PLAN (SWPPP) AND A TEMPORARY EROSION AND SEDIMENT CONTROL PLAN (TESCP) IN COMPLIANCE WITH SECTION 402 OF THE CLEAN WATER ACT. BEST MANAGEMENT PRACTICES (BMP'S) SHALL BE INSTALLED AND MAINTAINED BOTH DURING AND AFTER CONSTRUCTION TO PREVENT, TO THE EXTENT PRACTICABLE, POLLUTANTS IN STORM WATER RUNOFF FROM ENTERING WATERS OF THE U.S. TEMPORARILY DISTURBED AREAS SHALL BE RE-VEGETATED AFTER CONSTRUCTION TO LIMIT EROSION POTENTIAL.
- 9. CERTIFIED WEED-FREE NATIVE SEED SHALL BE UTILIZED WHEN RESEEDING THE PROJECT AREA. TO PREVENT THE SPREAD OF NOXIOUS WEEDS, THE CONTRACTOR SHALL THOROUGHLY CLEAN ALL EQUIPMENT WITH A HIGH PRESSURE WASHER PRIOR TO ENTERING AND LEAVING THE PROJECT AREA. MATERIALS TRANSPORTED INTO OR OUT OF THE PROJECT AREA SHALL BE CAREFULLY INSPECTED TO AVOID THE INTRODUCTION OF ADDITIONAL NOXIOUS WEED SPECIES. MATERIAL SOURCES CONTAINING NOXIOUS WEED SEEDS SHALL NOT BE UTILIZED BY THE CONTRACTOR. MULCH AND COMPOST USED ON THE PROJECT MUST BE CERTIFIED NOXIOUS WEED FREE, AS REQUIRED BY SECTION 632 OF THE 2007 EDITION OF THE NMDOT STANDARD SPECIFICATIONS FOR HIGHWAY AND BRIDGE CONSTRUCTION.

MADOT ENVIRONMENTAL PROGRAM MANAGER

9-10-14 DATE MOLZENCORBIN

2701 Miles Road SE Albuquerque, New Mexico 87106 505 242 5700 office 505 242 0673 fax MolzenCorbin.com

13679

ROFESSIONAL

11-20-14

NOTICE OF EXTENDED PAYMENT PROVISION: THIS CONTRACT ALLOWS THE OWNER TO MAKE PAYMENT WITHIN 45 DAYS AFTER SUBMISSION OF AN UNDISPUTED REQUEST FOR PAYMENT

REVISION

SYMBOL:	DATE:	BY:

SANTA FE COUNTY

PUBLIC WORKS DEPARTMENT
424 NM 599
SANTA FE, NM 87507

PROJECT NAME:

OLD SANTA FE TRAIL ROAD IMPROVEMENTS AND WATERLINE TL2N

> ENVIRONMENTAL COMMITMENT

APPROVED: - REVIEWED:
DATE: NOV. 2014

DATE: NOV. 2014 SHEET:

DRAWN BY: J.LOVATO G-009

11/20/11



KEYED NOTES

INSTALL SEDIMENT CONTROL BMP'S.
SEE SWPPP BOOK, FOR ADDITIONAL
SEDIMENT AND EROSION CONTROL DETAILS.

GENERAL SWPPP NOTES:

- 1. RESEED ALL DISTURBED AREAS WITHIN THE GRADING LIMITS PER 31-25-01
- 2. NO WASHING OR FUELING OF EQUIPMENT ALLOWED ON SITE.

OF CONSTRUCTION WORK.

- 3. WATER MAY BE USED TO CONTROL DUST WITHIN THE LIMITS
- 4. CONTRACTOR IS NOT TO GRADE OUTSIDE OF LIMITS SHOWN ON PLANS.
- 5. LOCATION FOR CONTRACTORS YARD HAS NOT BEEN DETERMINED. IF CONTRACTOR ELECTS TO MAKE ARRANGEMENTS FOR A YARD ON PRIVATE PROPERTY, HE SHALL COMPLY WITH ALL REQUIRE-MENTS OF THE SWPPP'S AND THE CONTRACT PLANS AND SHALL CONSTRUCT AND MAINTAIN A STABILIZED CONSTRUCTION ENTRANCE TO THE YARD.
- 7. SEE SWPPP BOOK, PREPARED BY MOLZEN-CORBIN & ASSOC. FOR ADDITIONAL SEDIMENT AND EROSION CONTROL DETAILS.

<u>LEGEND</u>

NEW SILT FENCE/SOCK



COBBLE OR CATTLE GUARD CONSTRUCTION ENTRANCE



10'X10' CONCRETE -WASHOUT SUMP

SOLID WASTE STORAGE

PORT-A-POTTY WITH CONTAINMENT

5'X10' HAZARDOUS-

1. THE CONTRACTOR SHALL COORDINATE WITH THE PROJECT

MANAGER TO DETERMINE THE BEST AREA TO PLACE THE LAYOUT

TYPICAL LAYDOWN AREA LAYOUT

MATERIAL STORAGE AREA

AREA DISCHARGES TO DESIGNATED FLOODPLAIN (NOT TO BE GRADED IN THIS CONTRACT

> -END SILT SOCK\FENCE

> > -STABILIZED CONSTRUCTION

ENTRANCE

SOCK\FENCE

└─30'X30' MATERIAL


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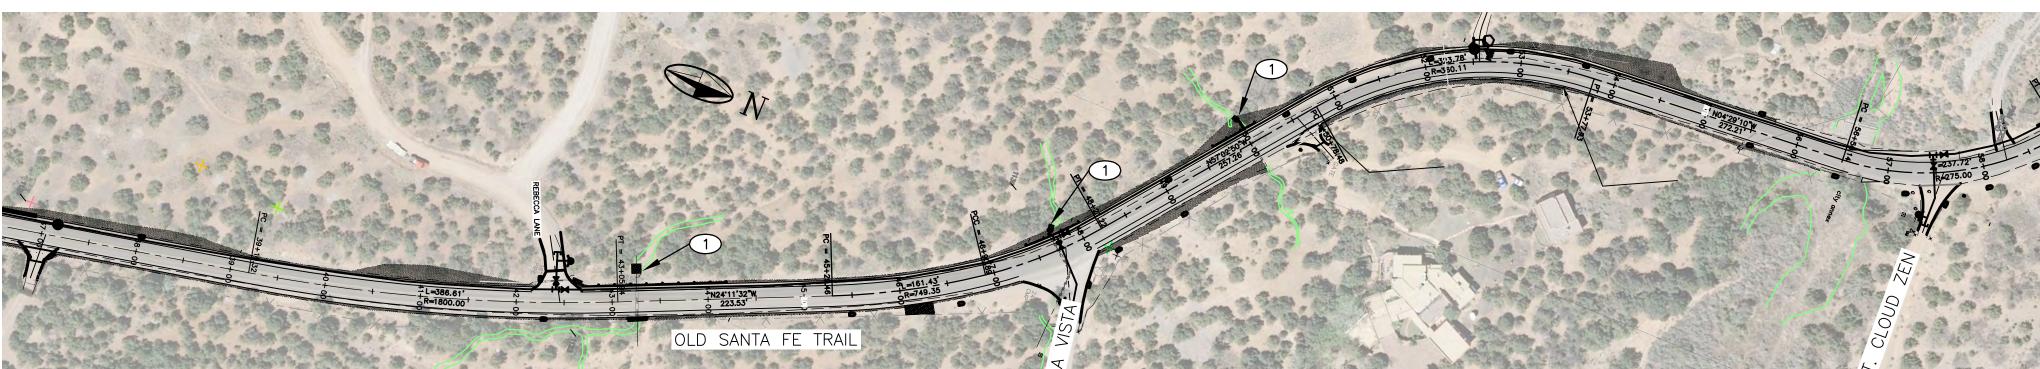
— GRADING LIMITS

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WHERE GRADE EXCEEDS 2%


<u>SECTION A - A</u>

- 1. THE ENTRANCE SHALL BE MAINTAINED IN A CONDITION THAT WILL PREVENT TRACKING OR FLOWING OF SEDIMENT ONTO PUBLIC RIGHTS-OF-WAY. THIS MAY REQUIRE TOP DRESSING, REPAIR AND/OR CLEANOUT OF ANY MEASURES
- USED TO TRAP SEDIMENT. 2. WHEN NECESSARY, WHEELS SHALL BE CLEANED PRIOR TO ENTRANCE ONTO PUBLIC RIGHT-OF-WAY 3. WHEN WASHING IS REQUIRED, IT SHALL BE DONE ON AN AREA STABILIZED WITH CRUSHED STONE
- OR SEDIMENT BASIN. 4. USE SANDBAGS, STRAW BALES OR OTHER APPROVED METHODS TO CHANNELIZE RUNOFF TO BASIN AS REQUIRED.

THAT DRAINS INTO AN APPROVED SEDIMENT TRAP

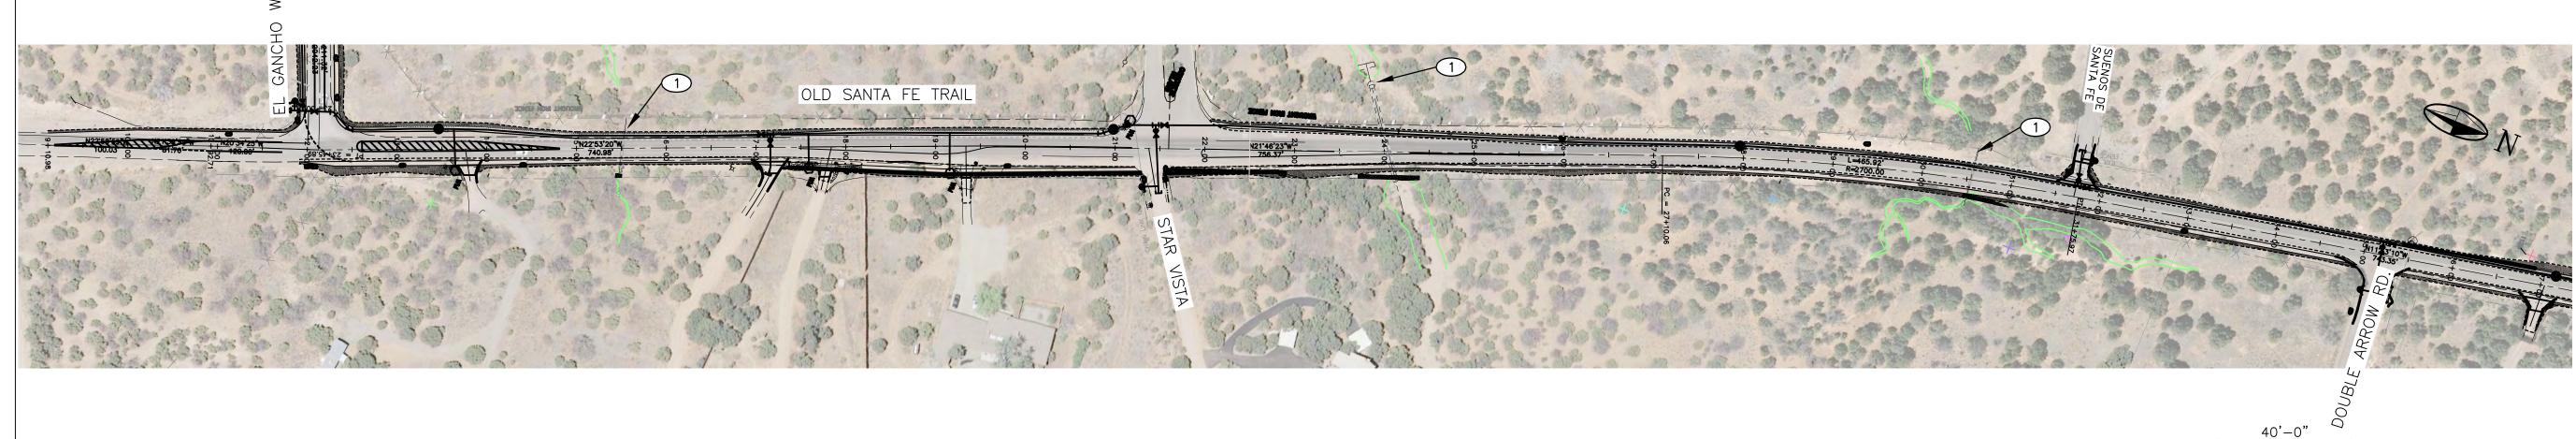- 5. STABILIZE ALL DISTURBED PROJECT AREAS WITH STABILIZATION SEEDING AT END OF PROJECT CONSTRUCTION.
- 6. SWEEP AND REMOVE SEDIMENT TRACK OUT

DIVERSION RIDGE REQUIRED FILTER FABRIC

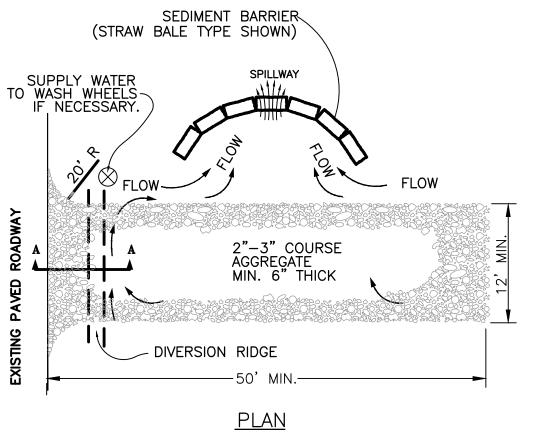

11-20-14

NOTICE OF EXTENDED PAYMENT PROVISION: THIS CONTRACT ALLOWS THE OWNER TO MAKE PAYMENT WITHIN 45 DAYS AFTER SUBMISSION OF AN UNDISPUTED REQUEST FOR PAYMENT

REVISION

SYMBOL: DATE: BY:

SANTA FE COUNTY **PUBLIC WORKS DEPARTMENT** 424 NM 599 SANTA FE, NM 87507

PROJECT NAME:


OLD SANTA FE TRAIL ROAD IMPROVEMENTS AND

SEDIMENT EROSION CONTROL AND RESEEDING PLAN

WATERLINE TL2N

APPROVED: -REVIEWED: -DATE: NOV., 2014 SHEET: G-010 DRAWN BY: J.LOVATO

STABILIZED CONSTRUCTION ENTRANCE

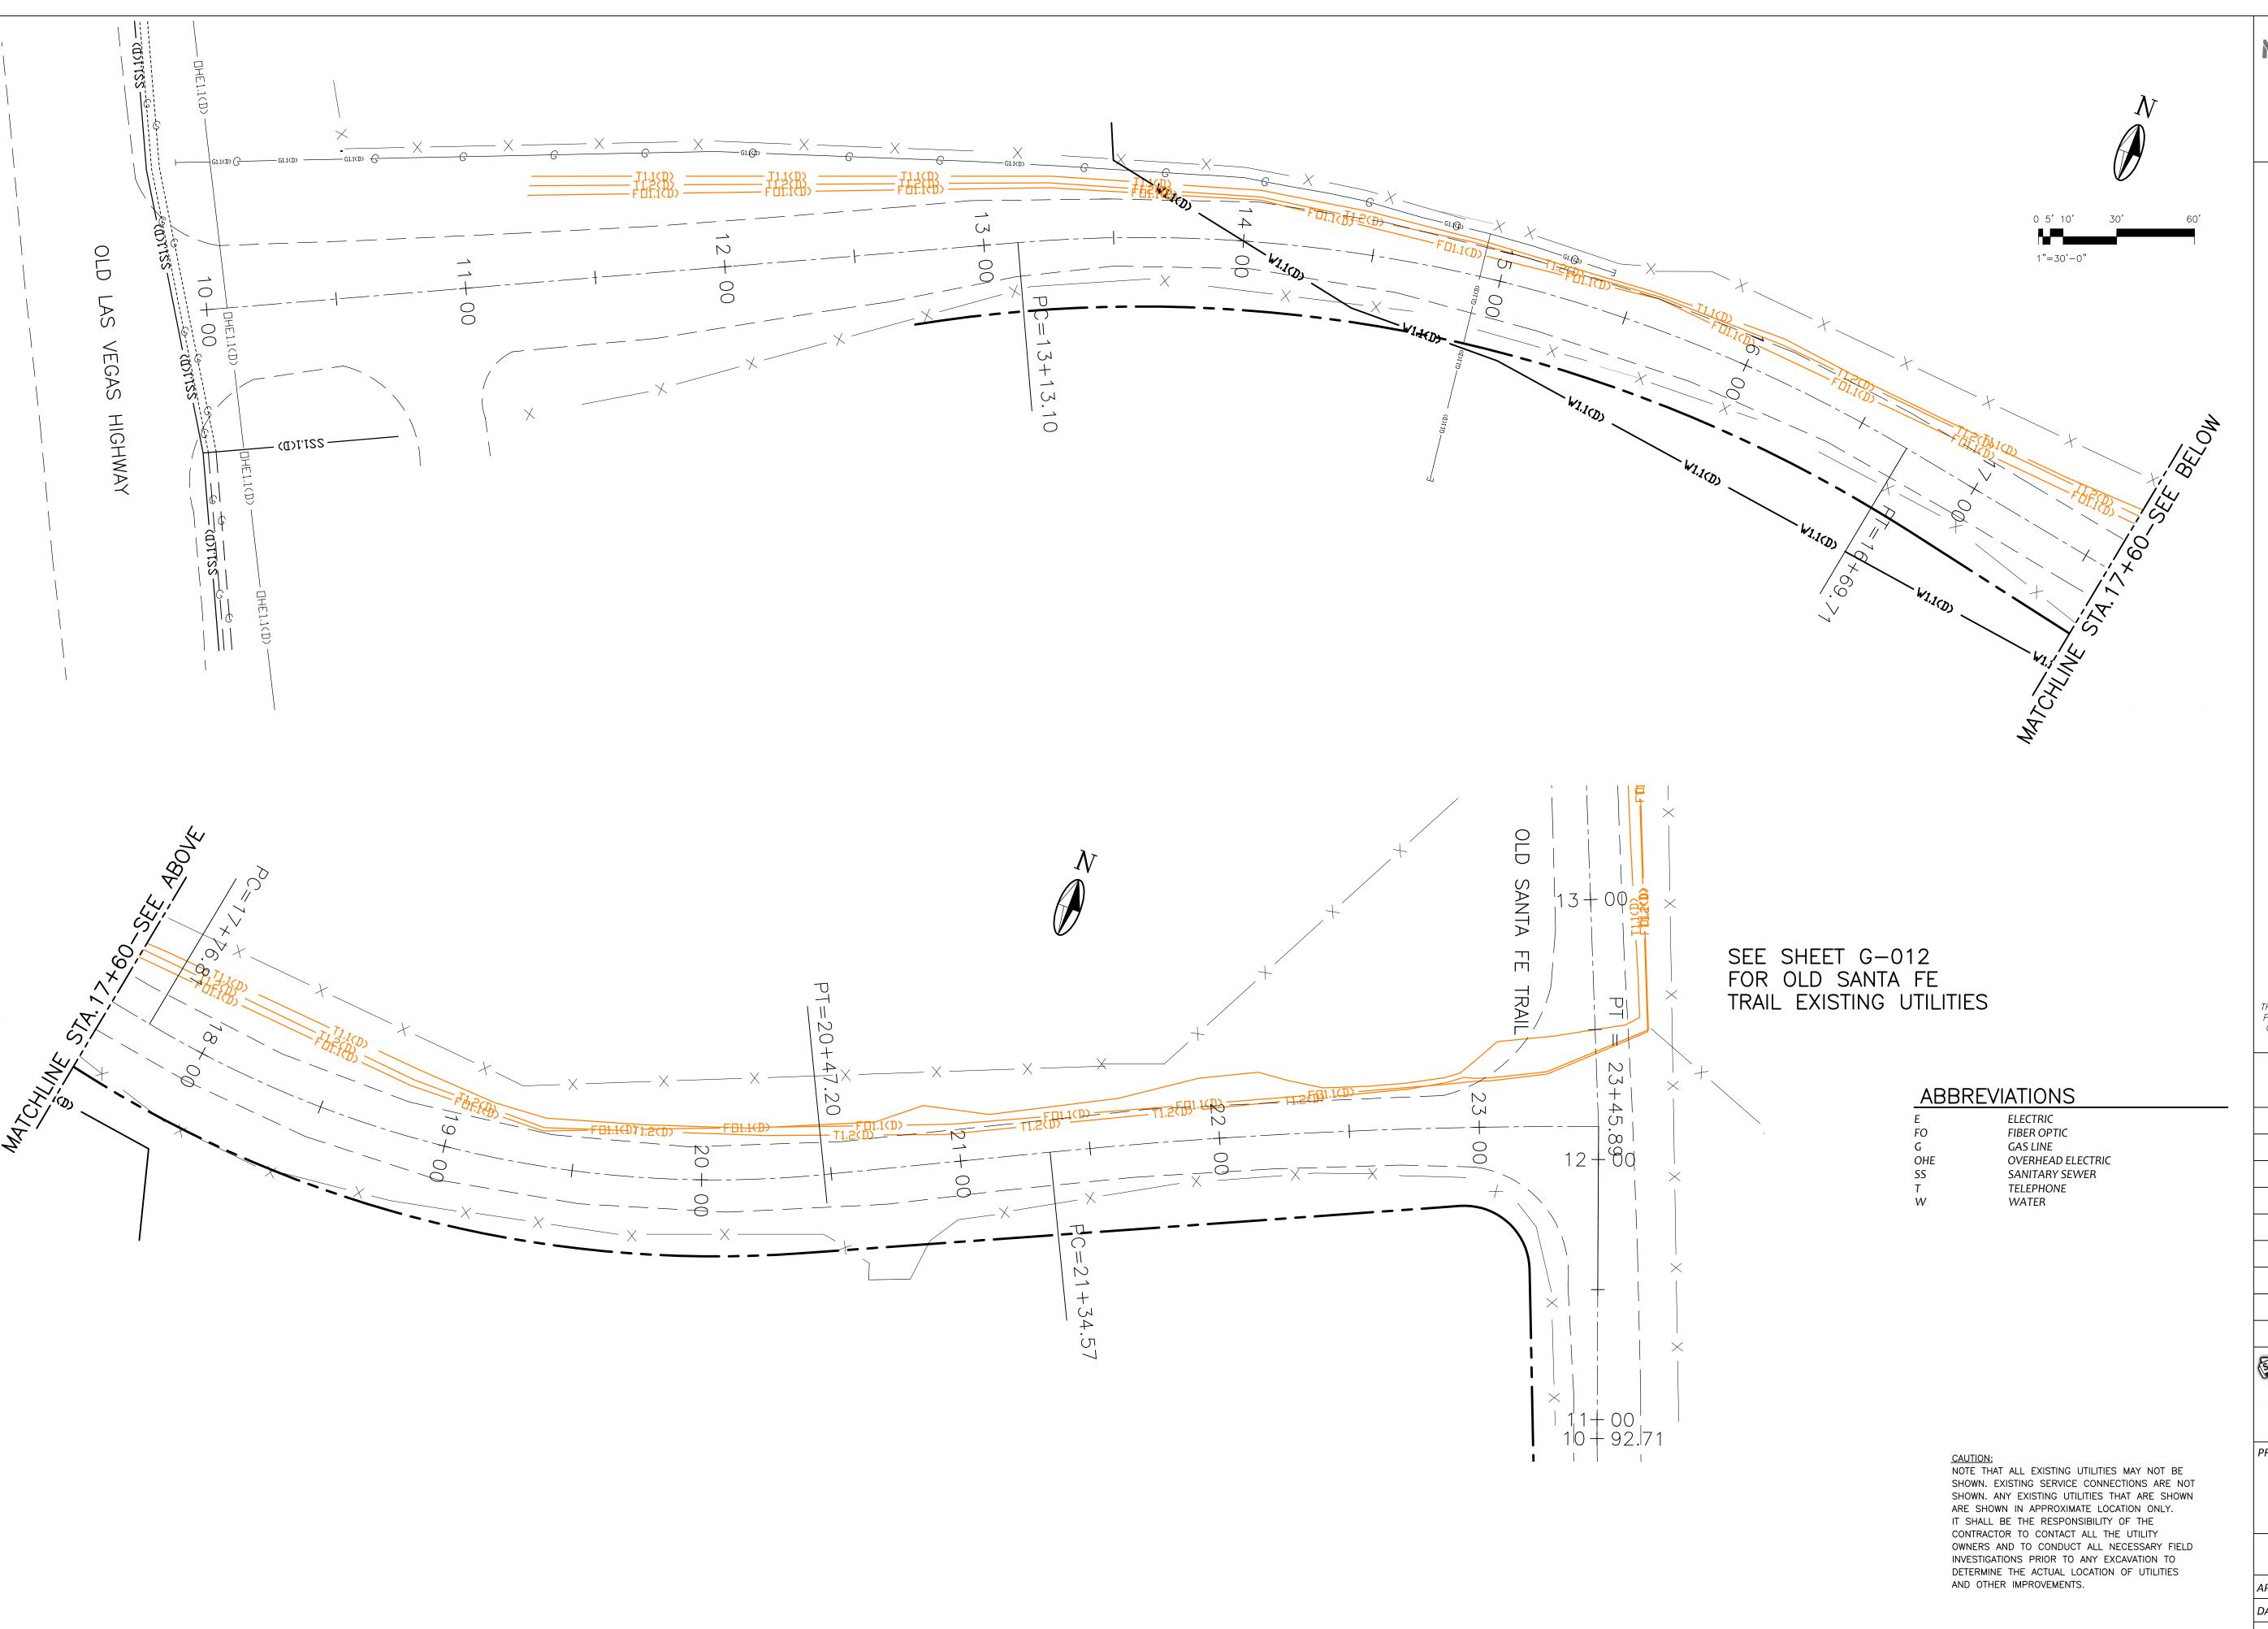

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REVISION

SYMBOL:	DATE:	BY:




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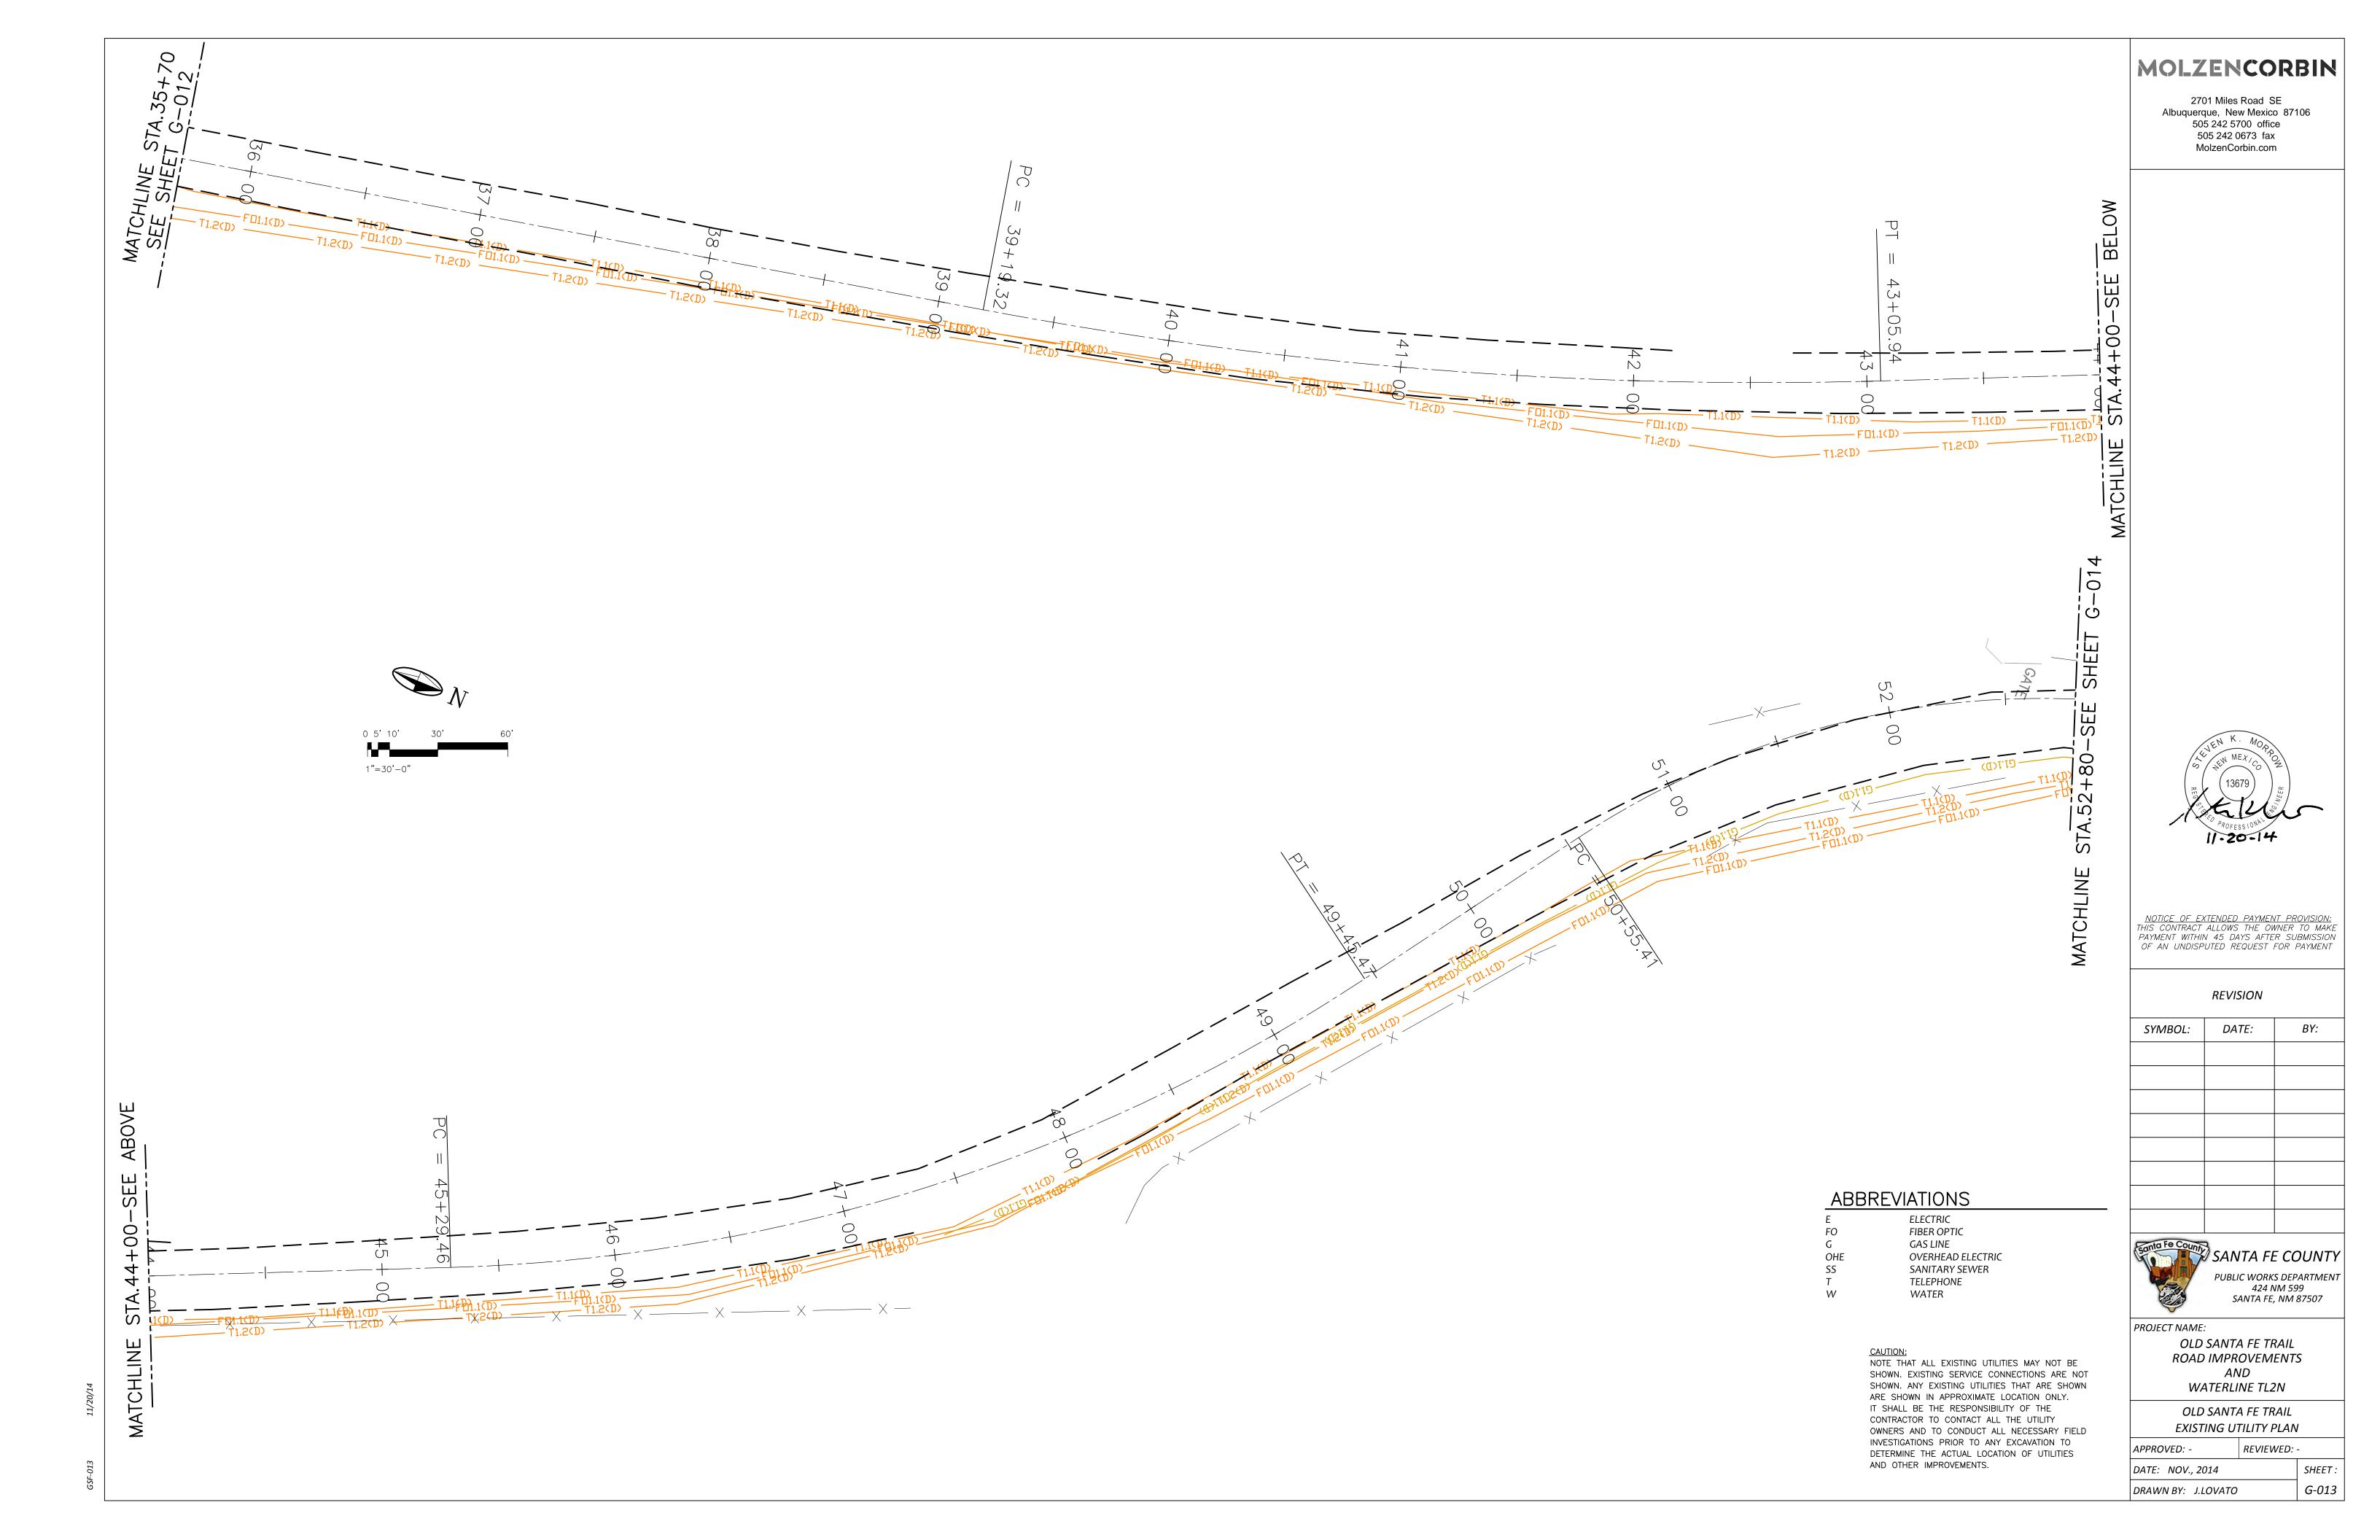
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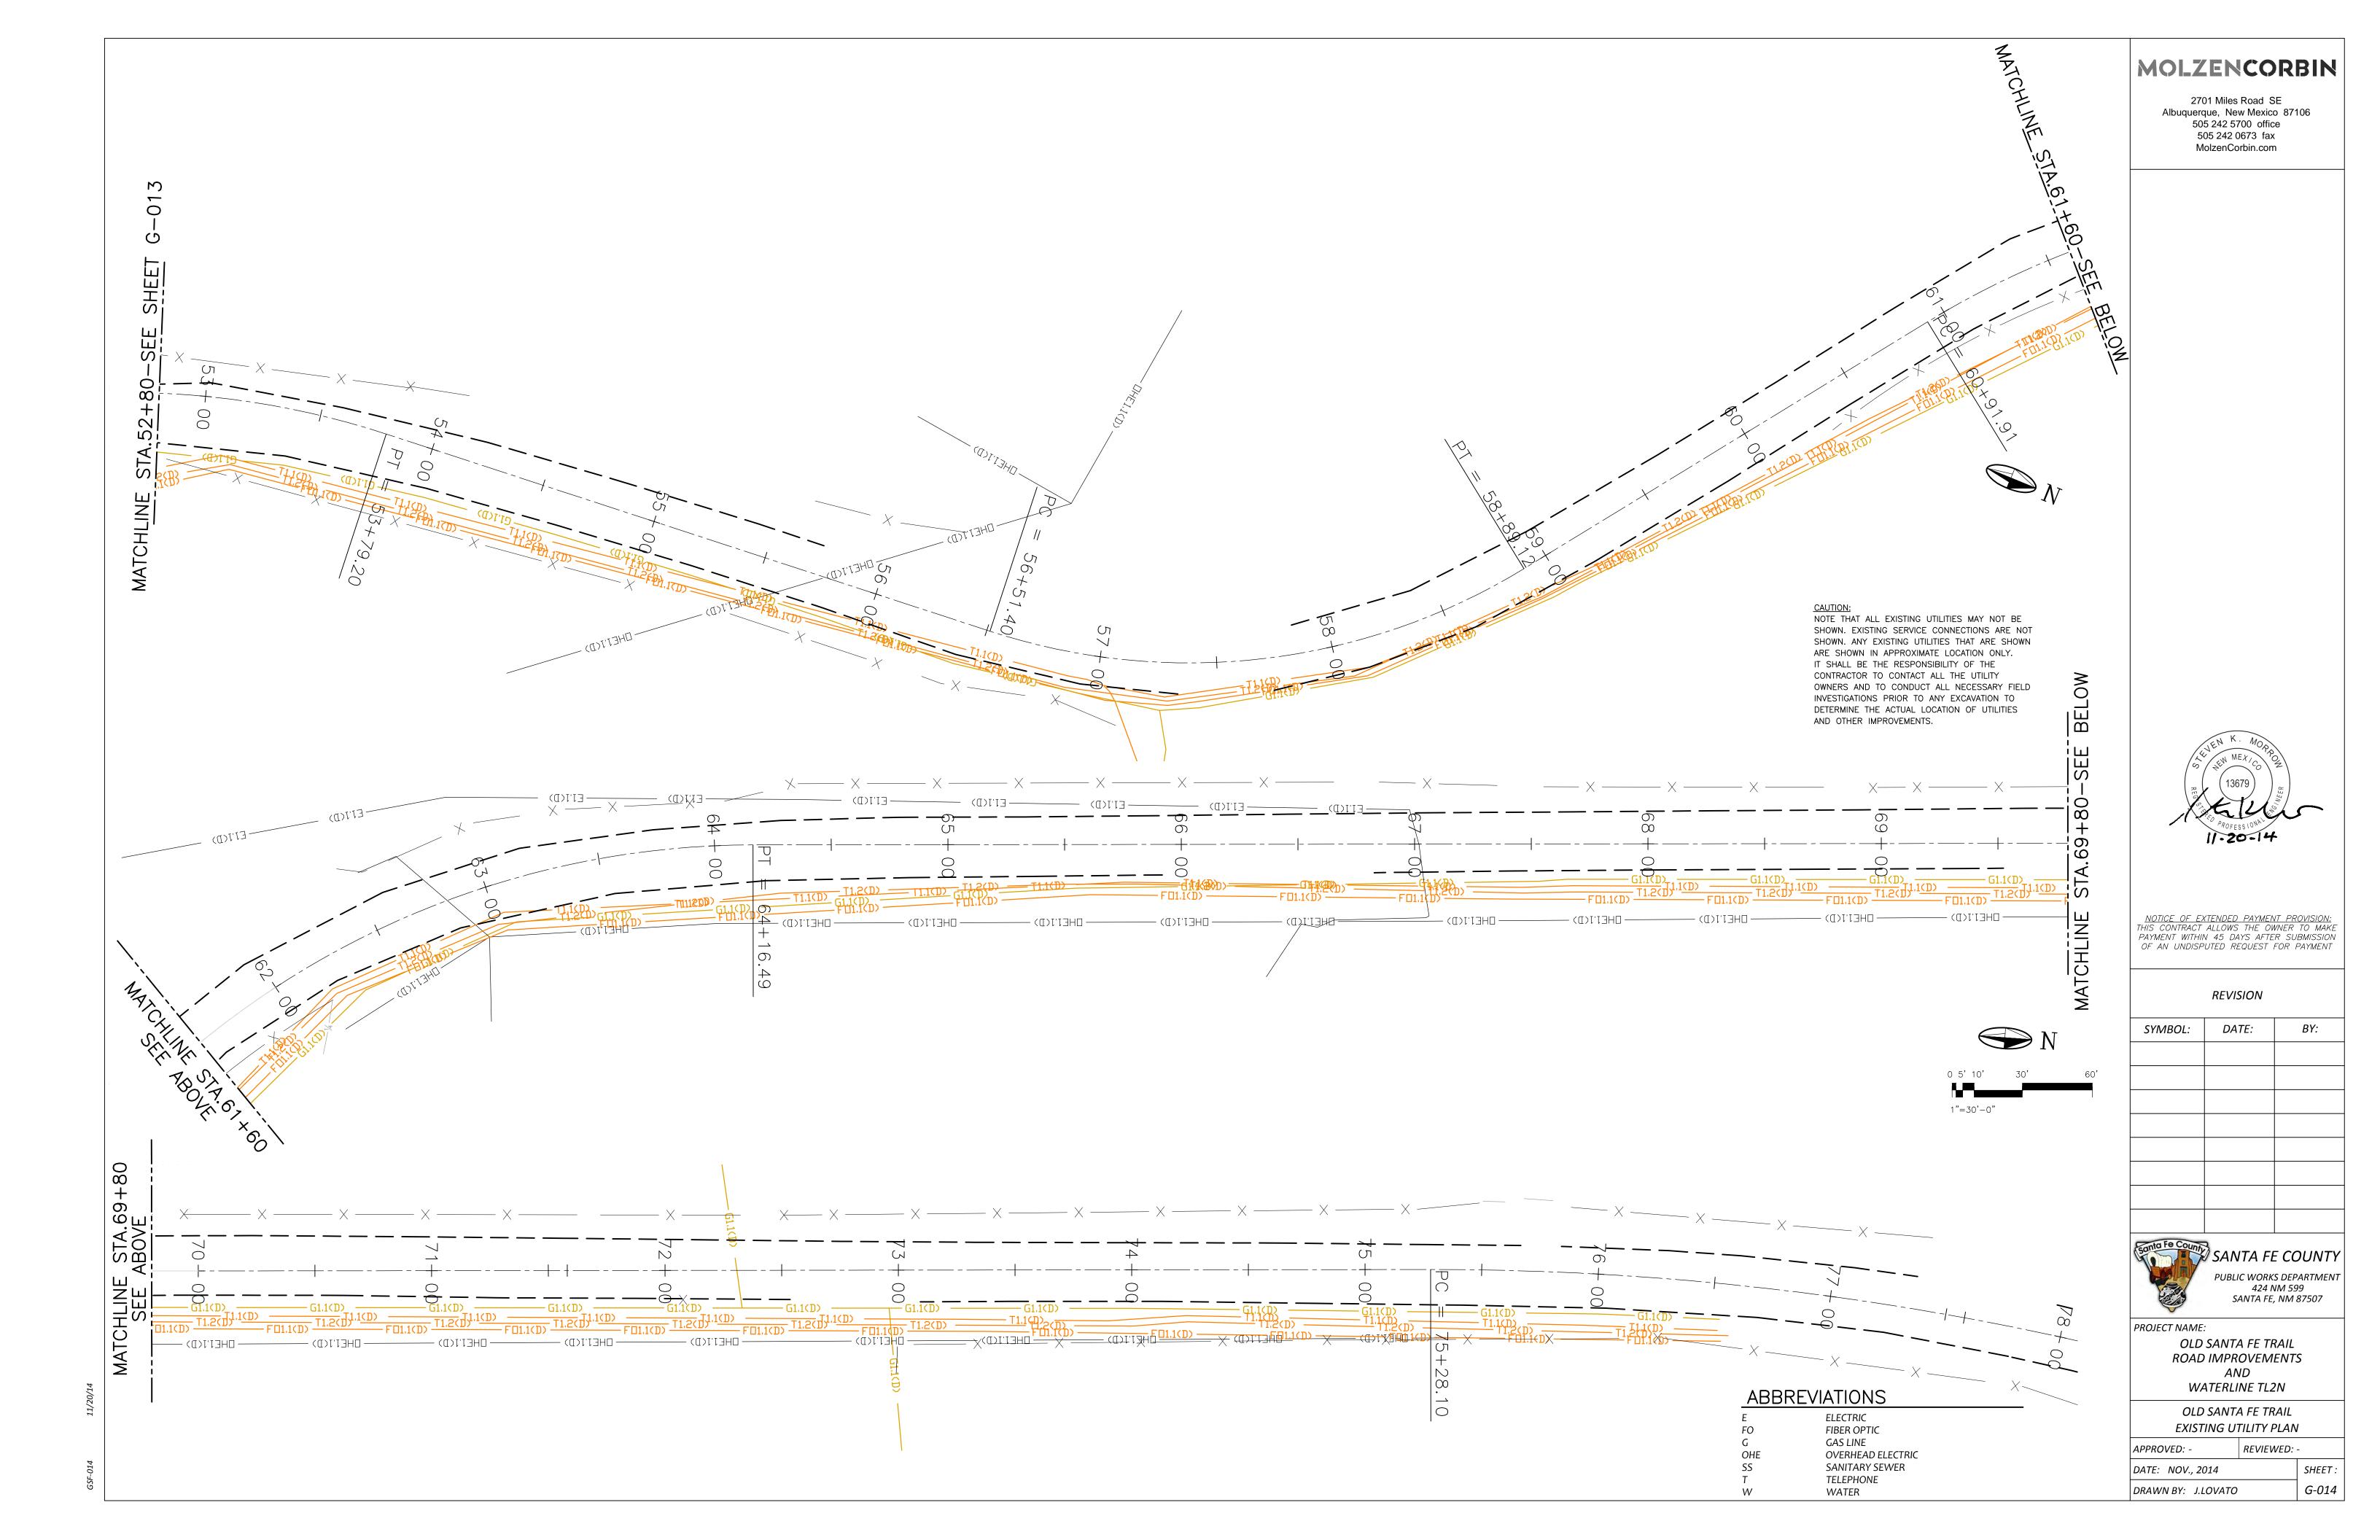
EL GANCHO WAY
EXISTING UTILITY PLAN


WATERLINE TL2N


APPROVED: -	REVIEWED:	-
DATE: NOV., 2014		SHEET:
DRAWN BY: J.LOVATO		G-011






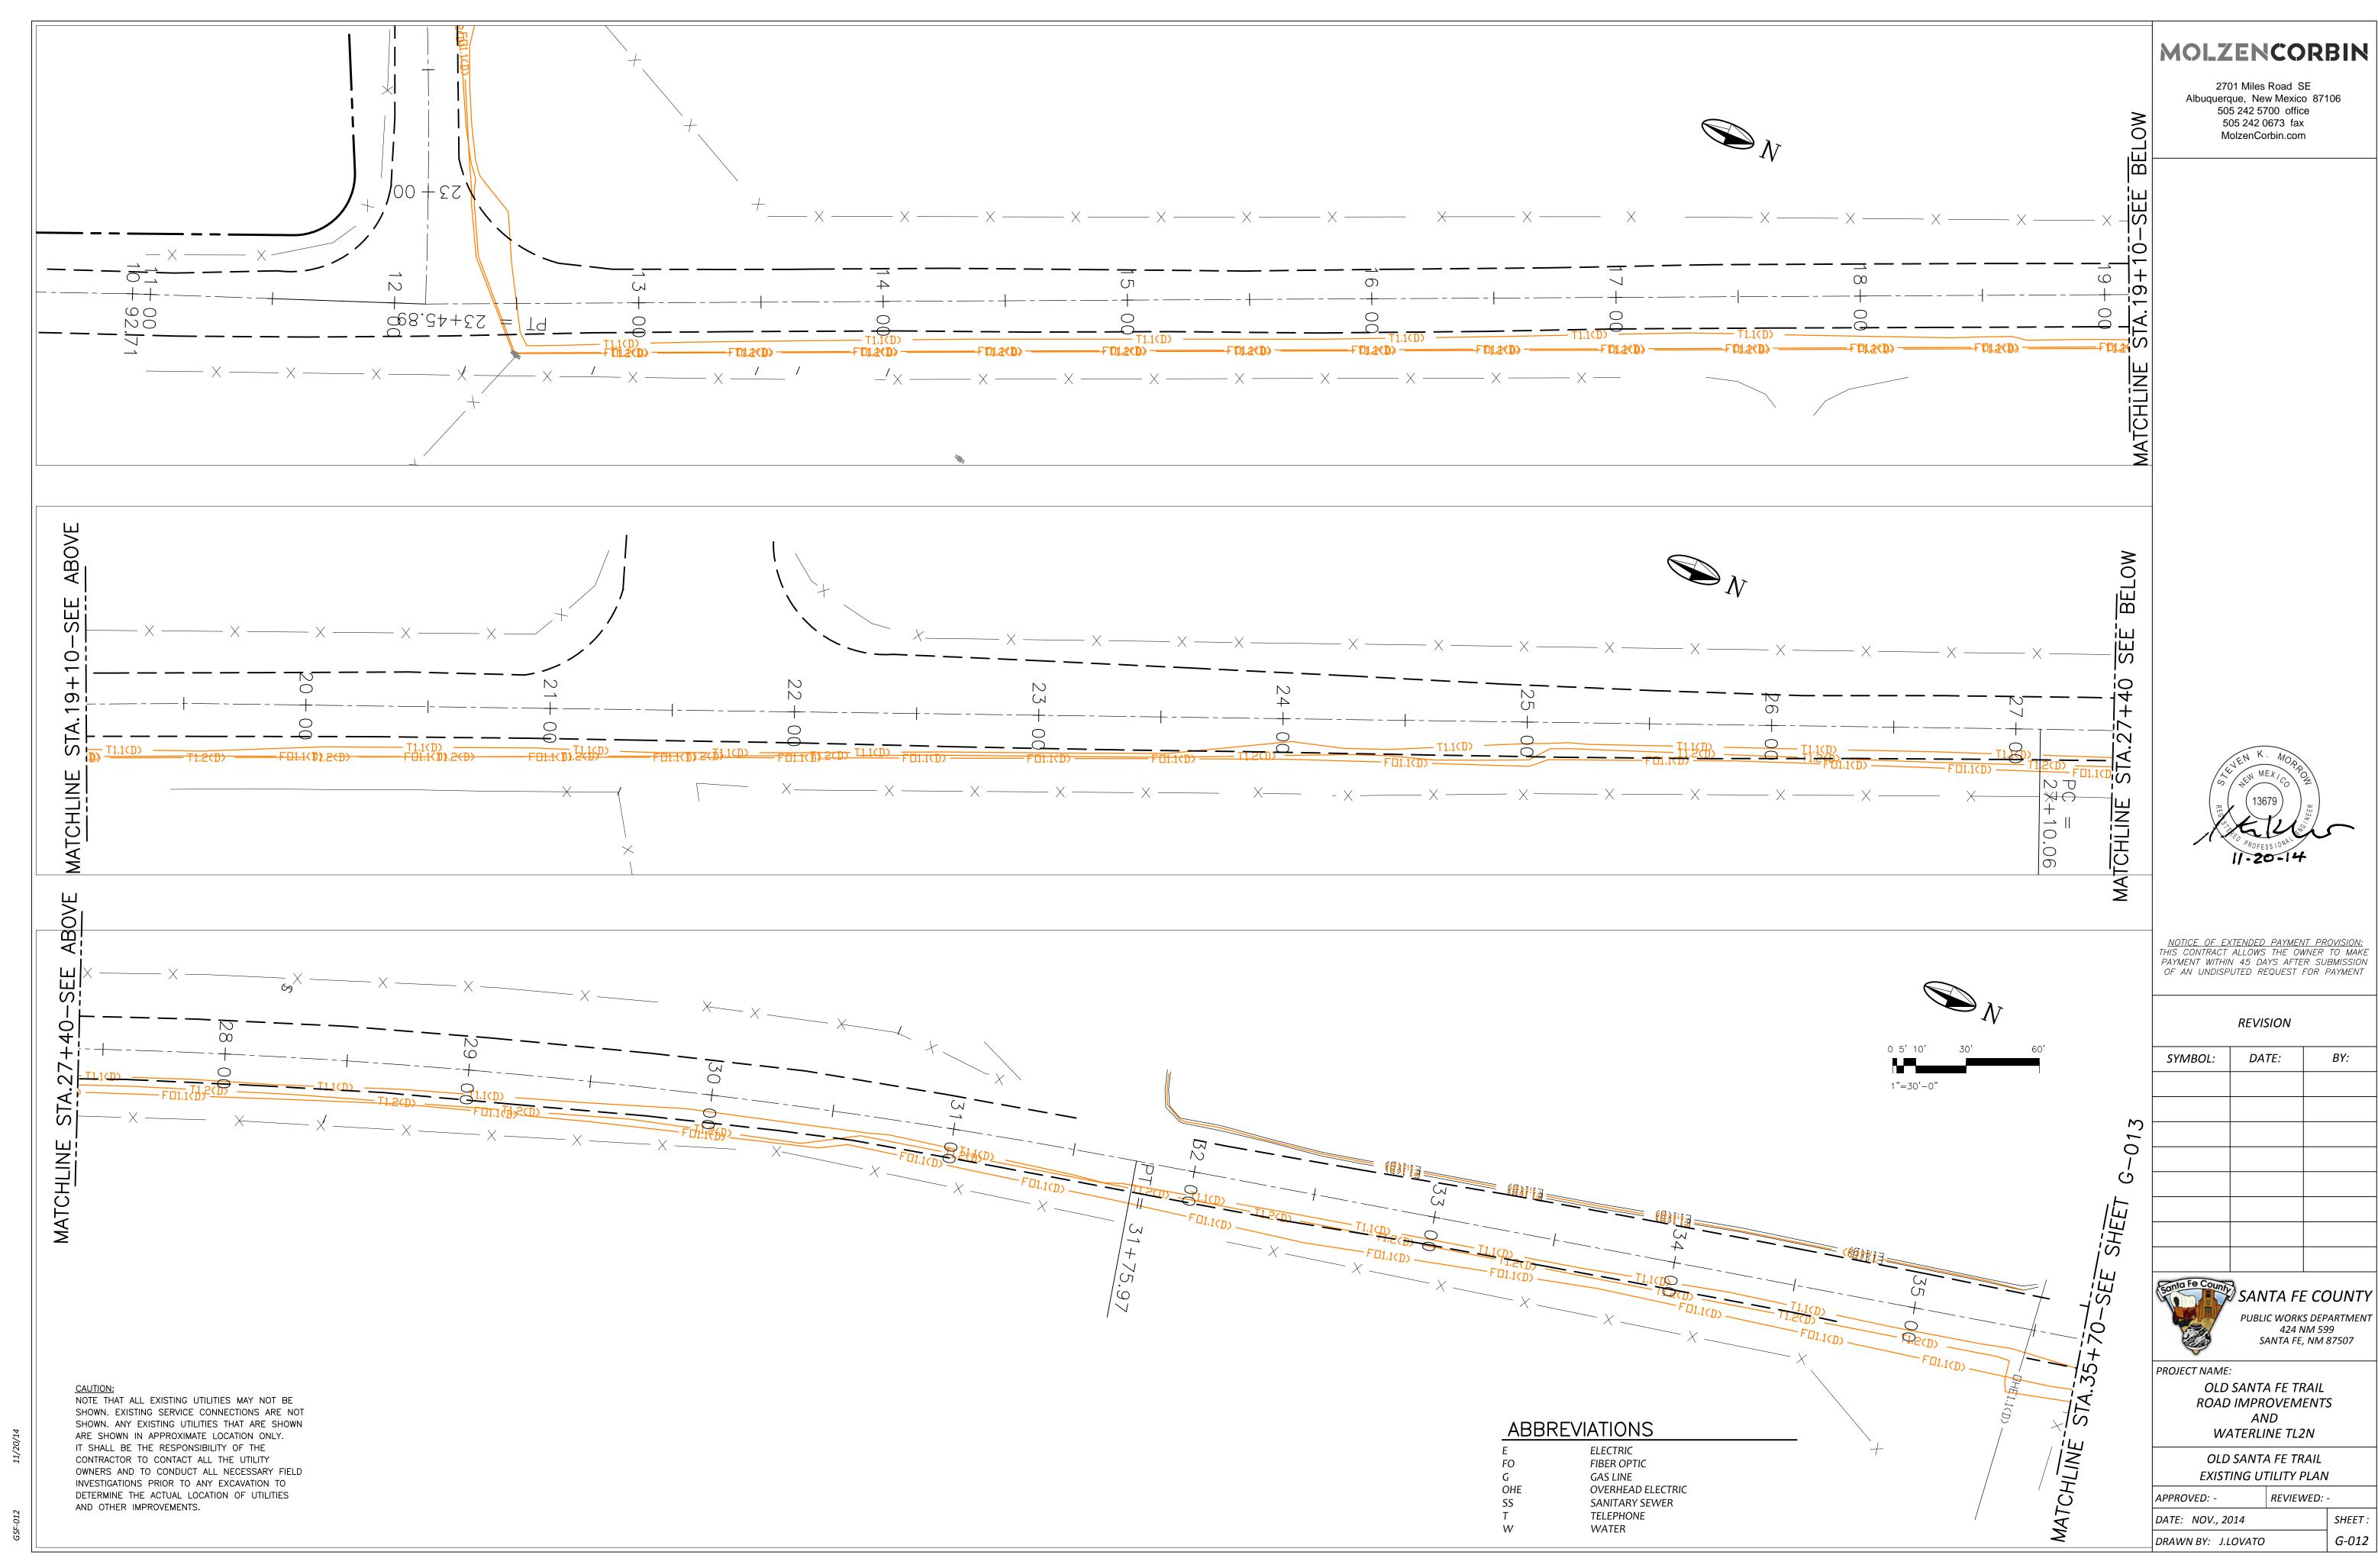


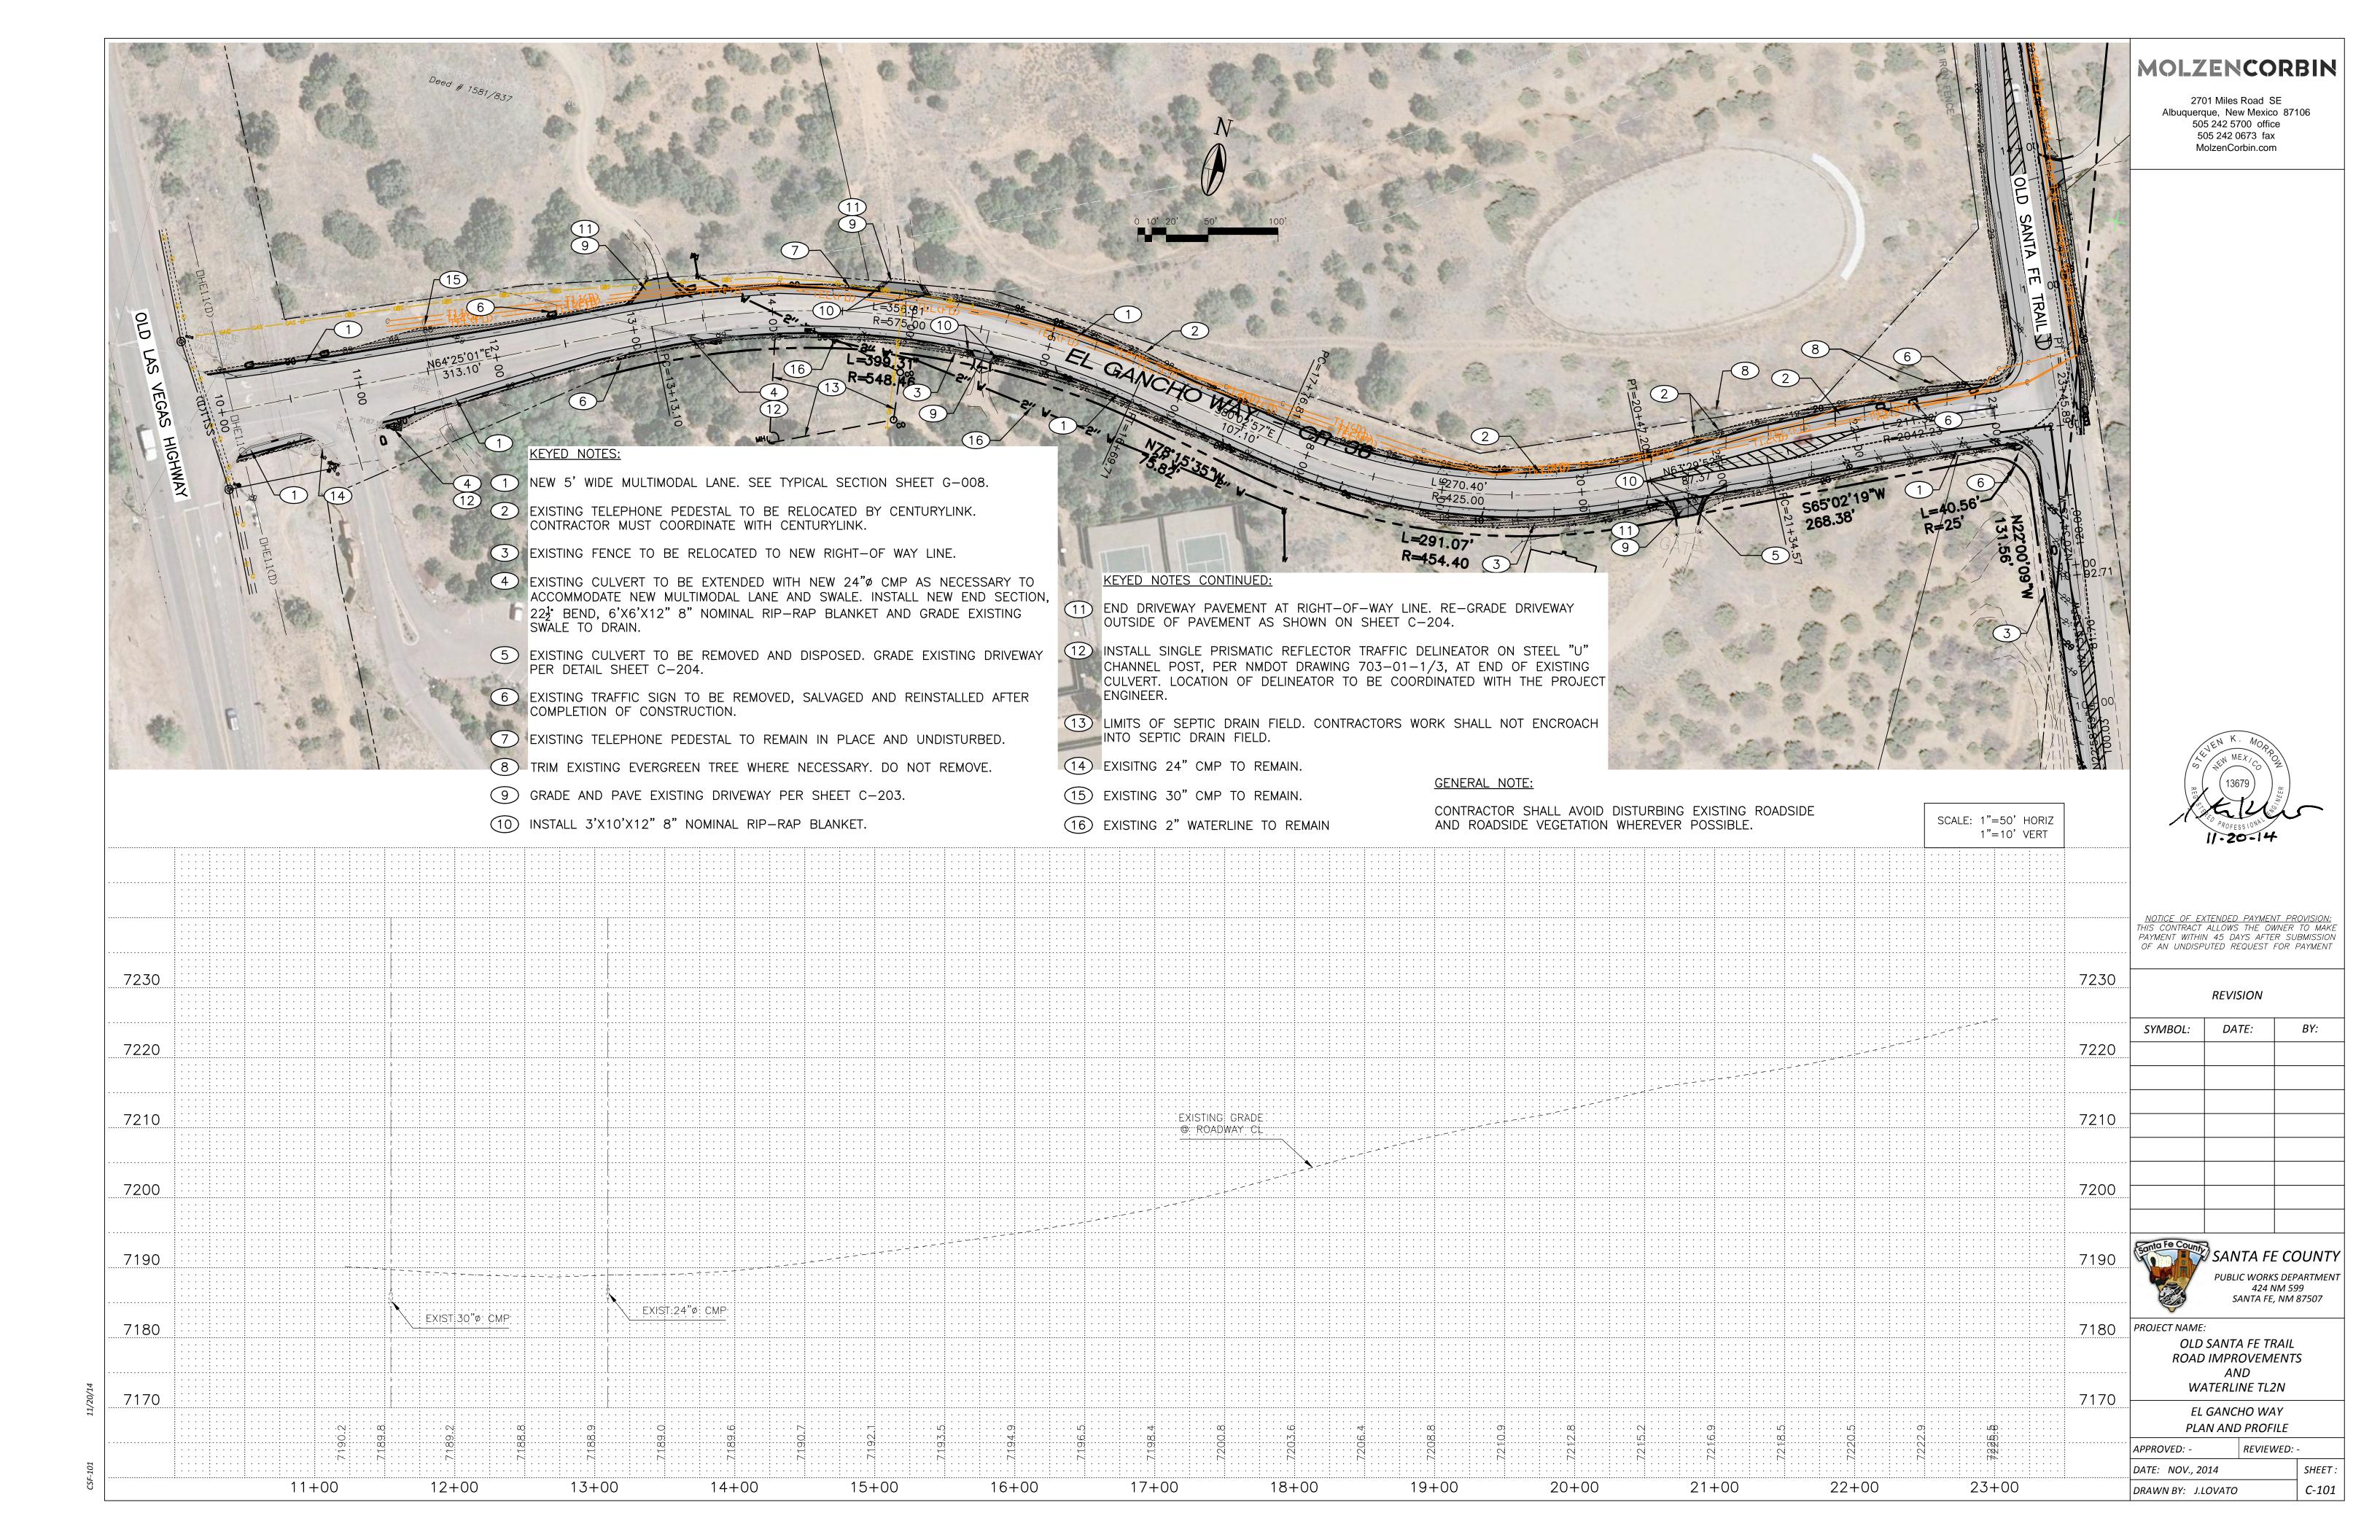


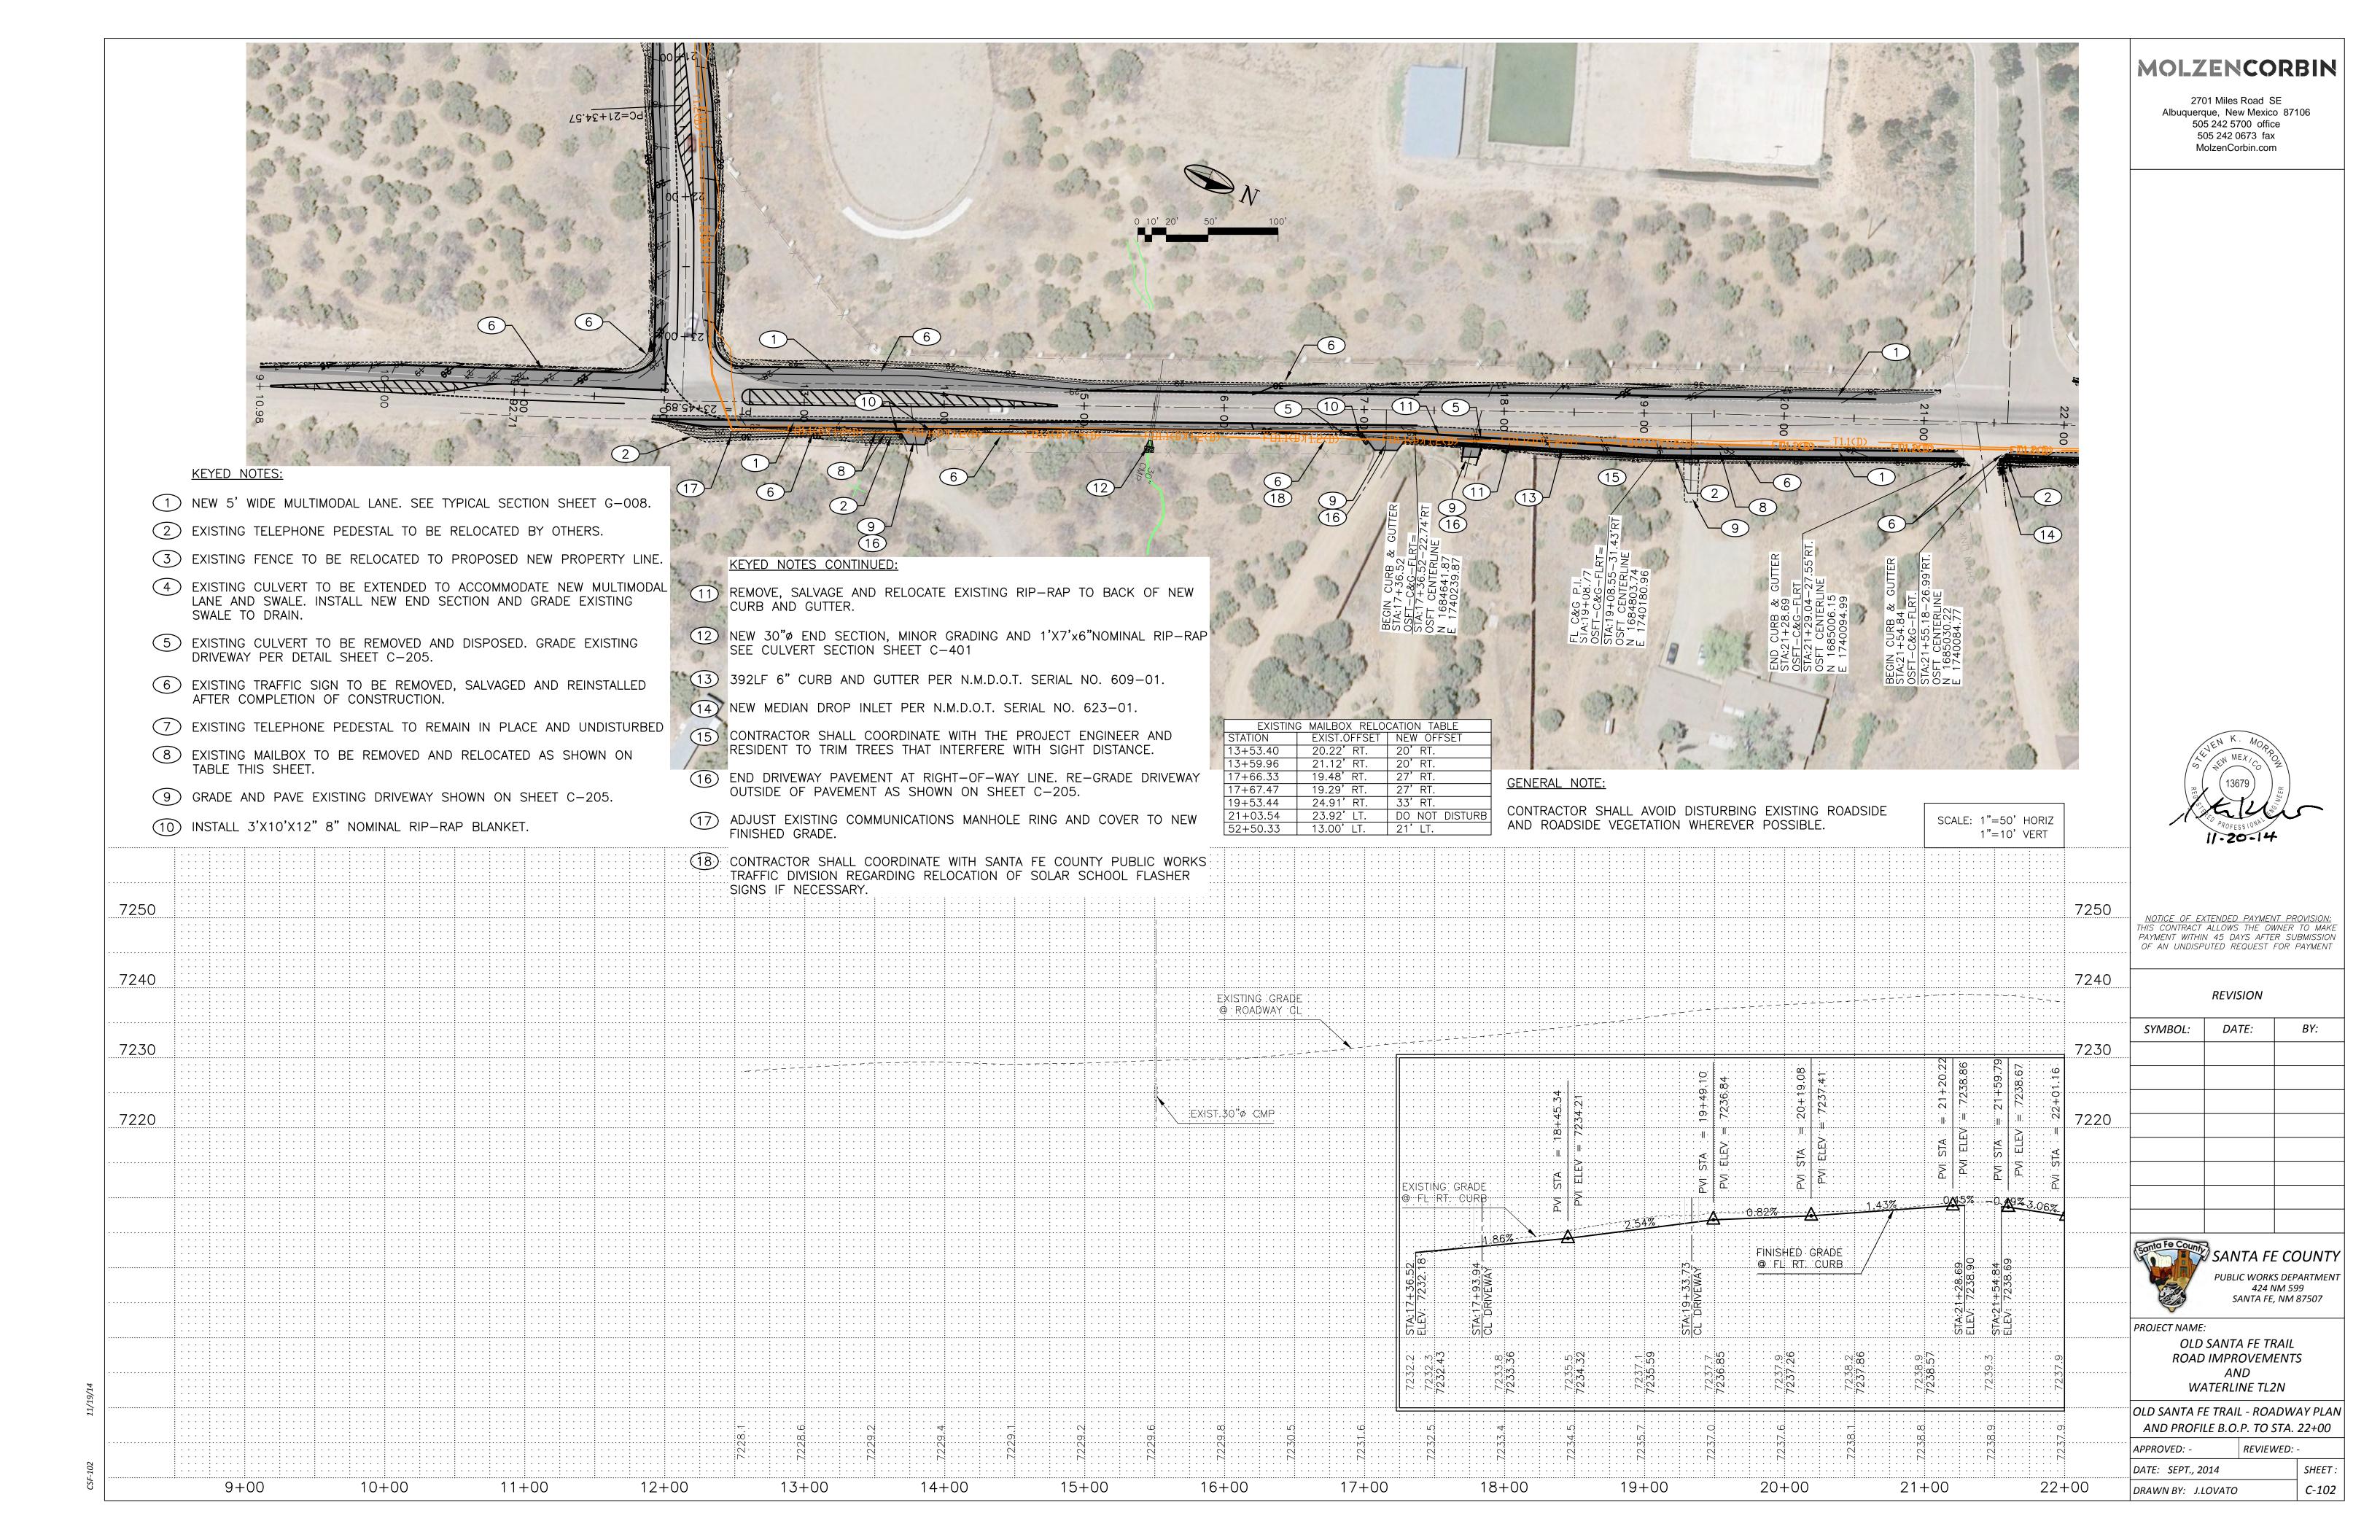


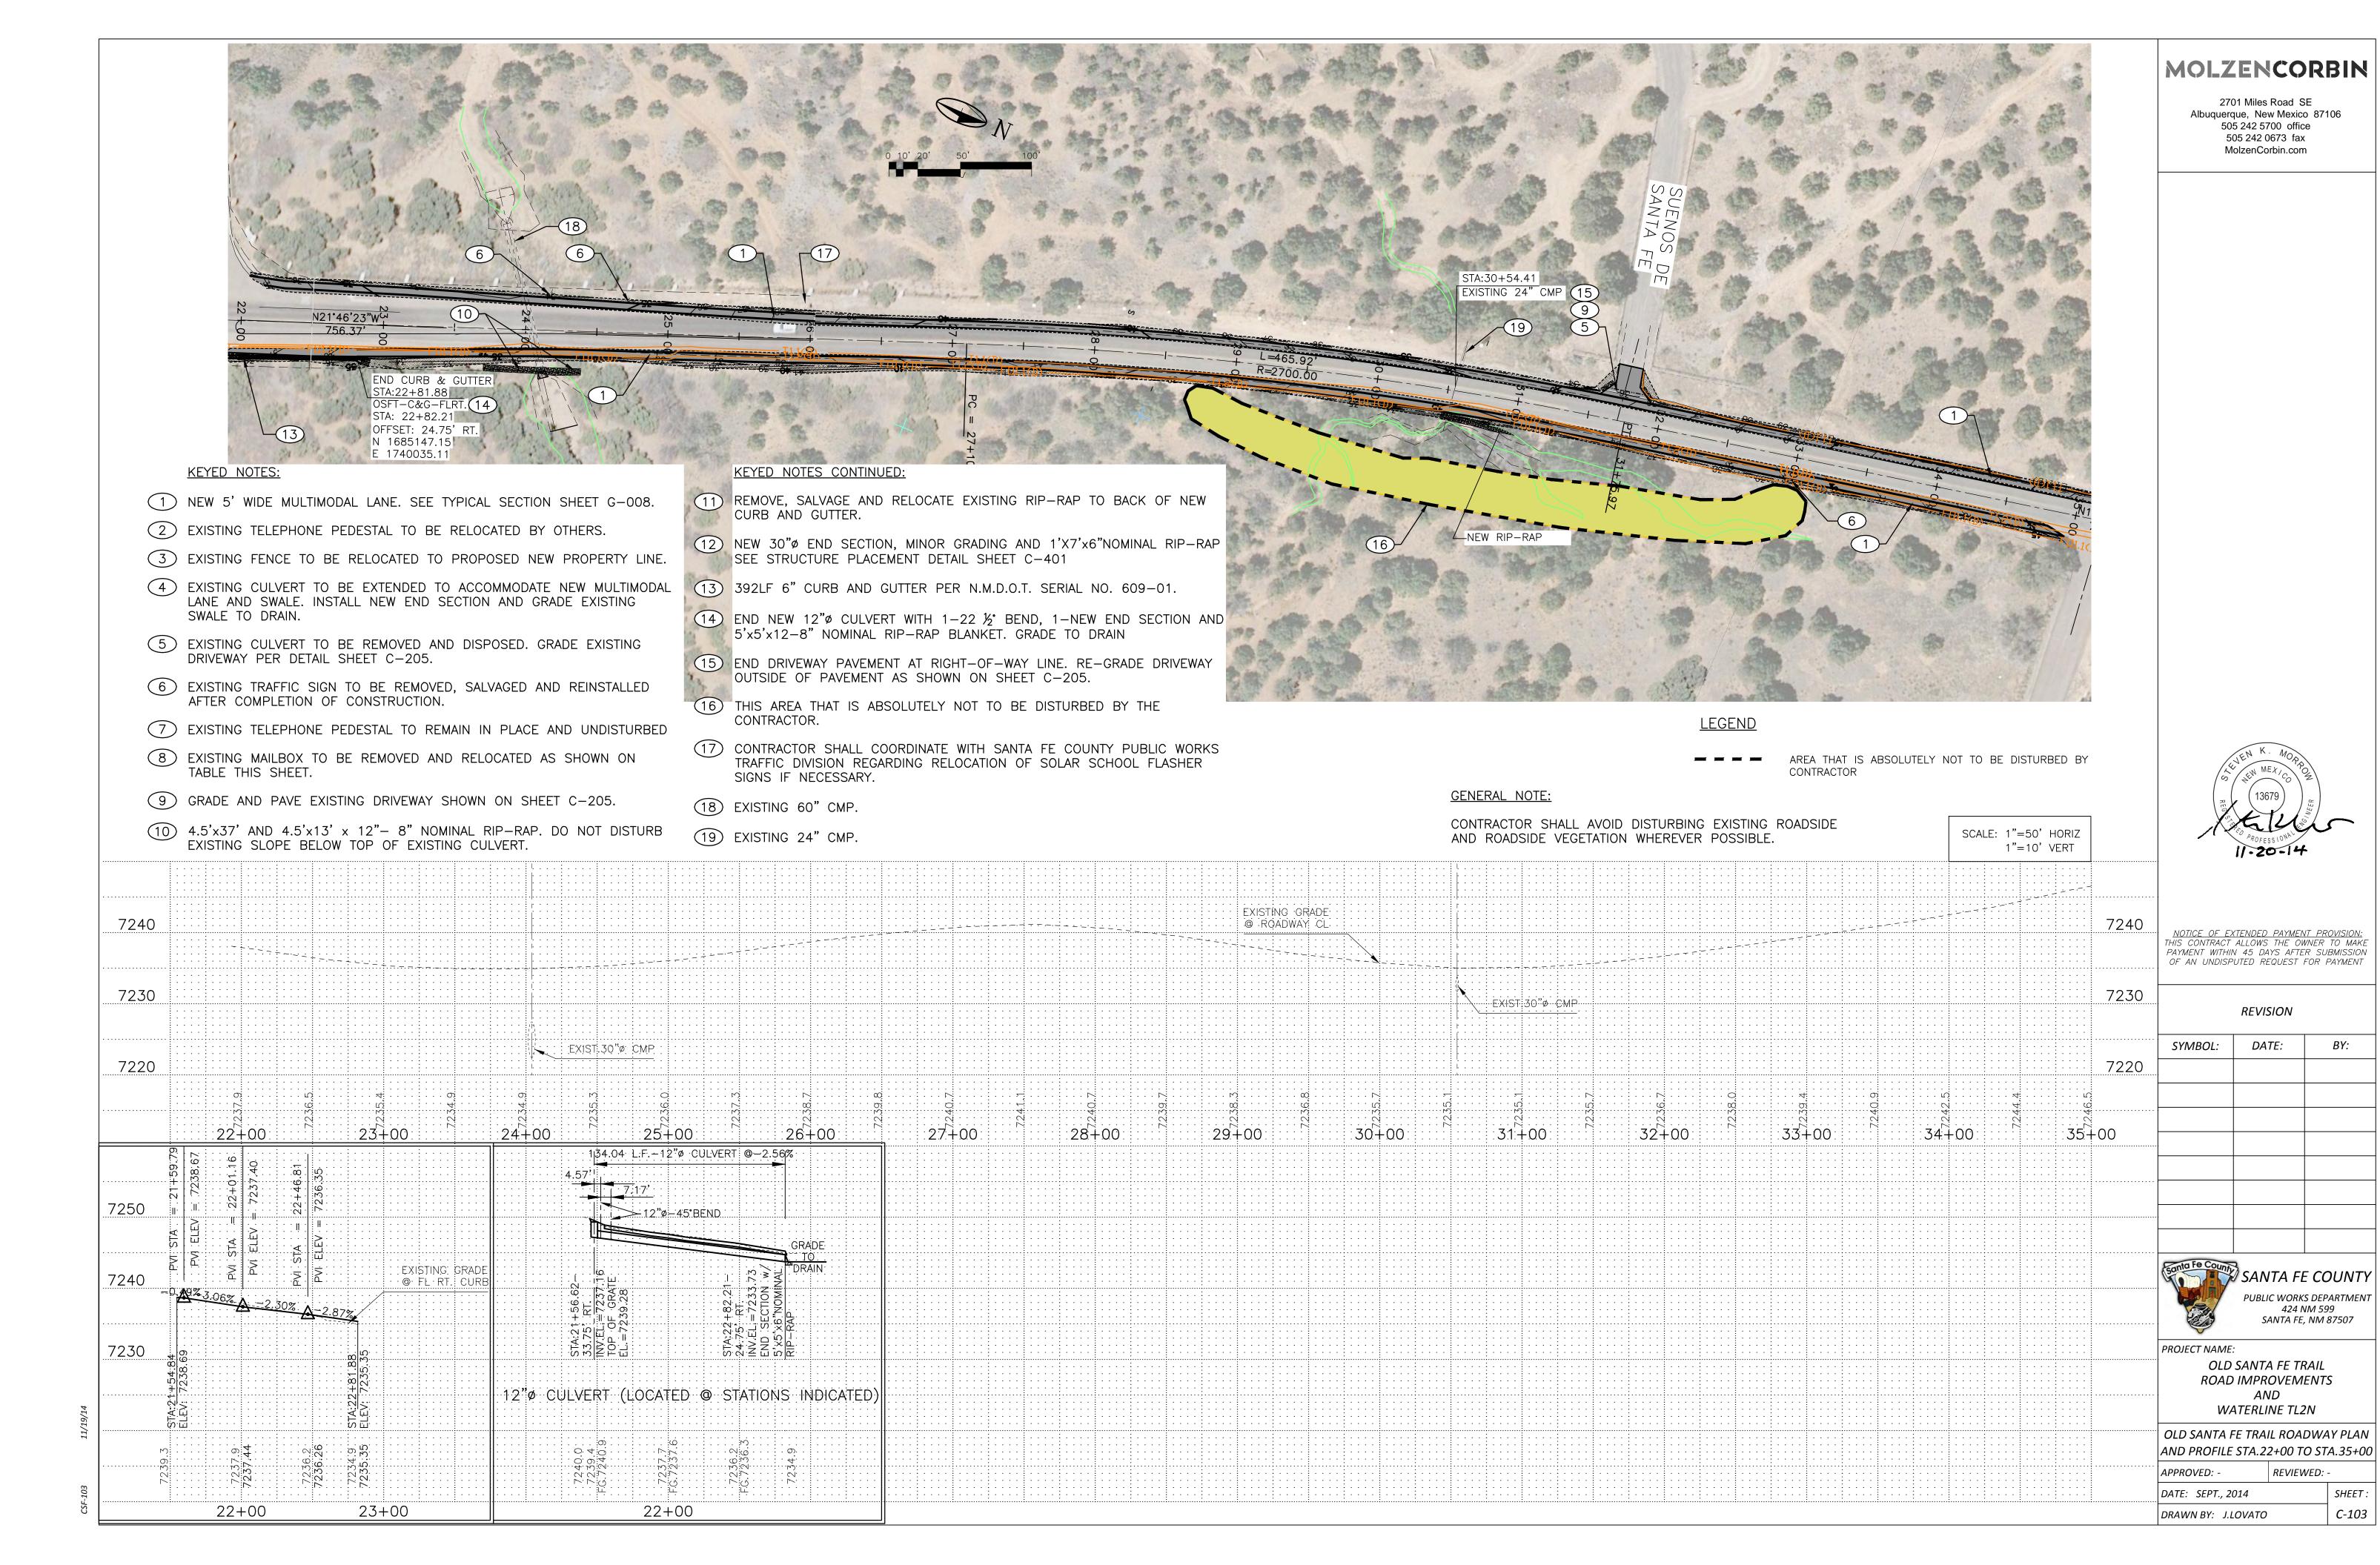


C-103

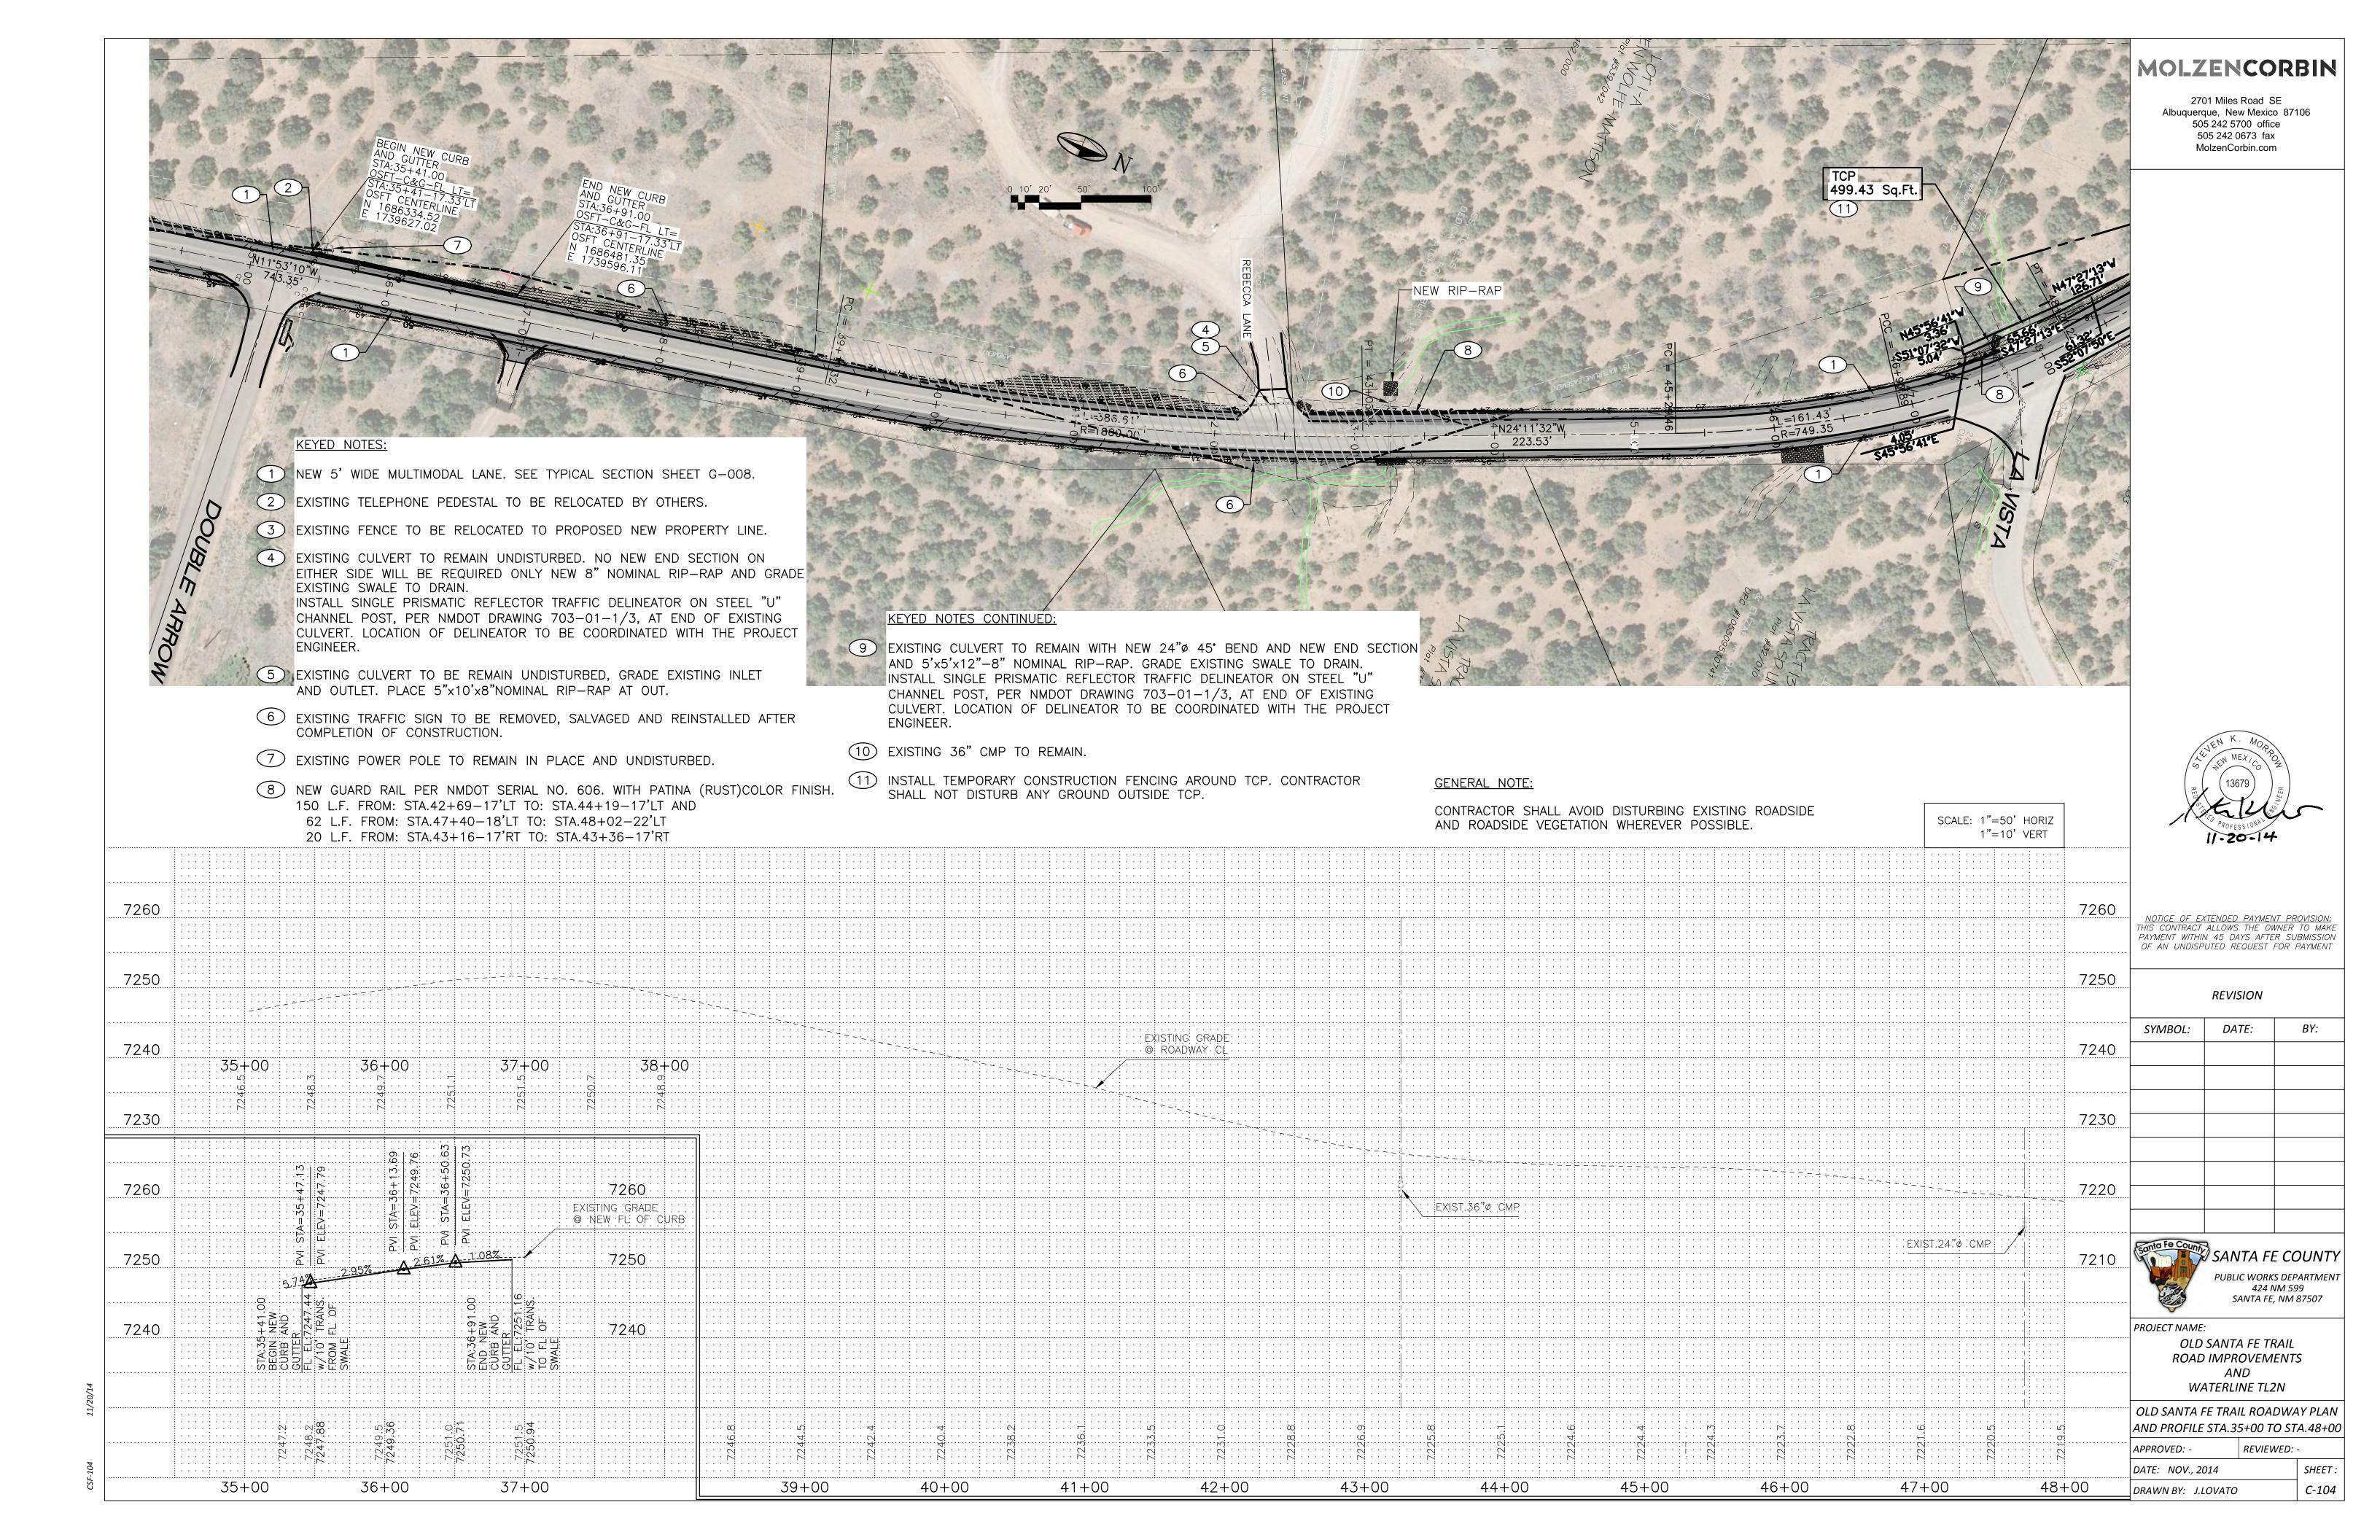

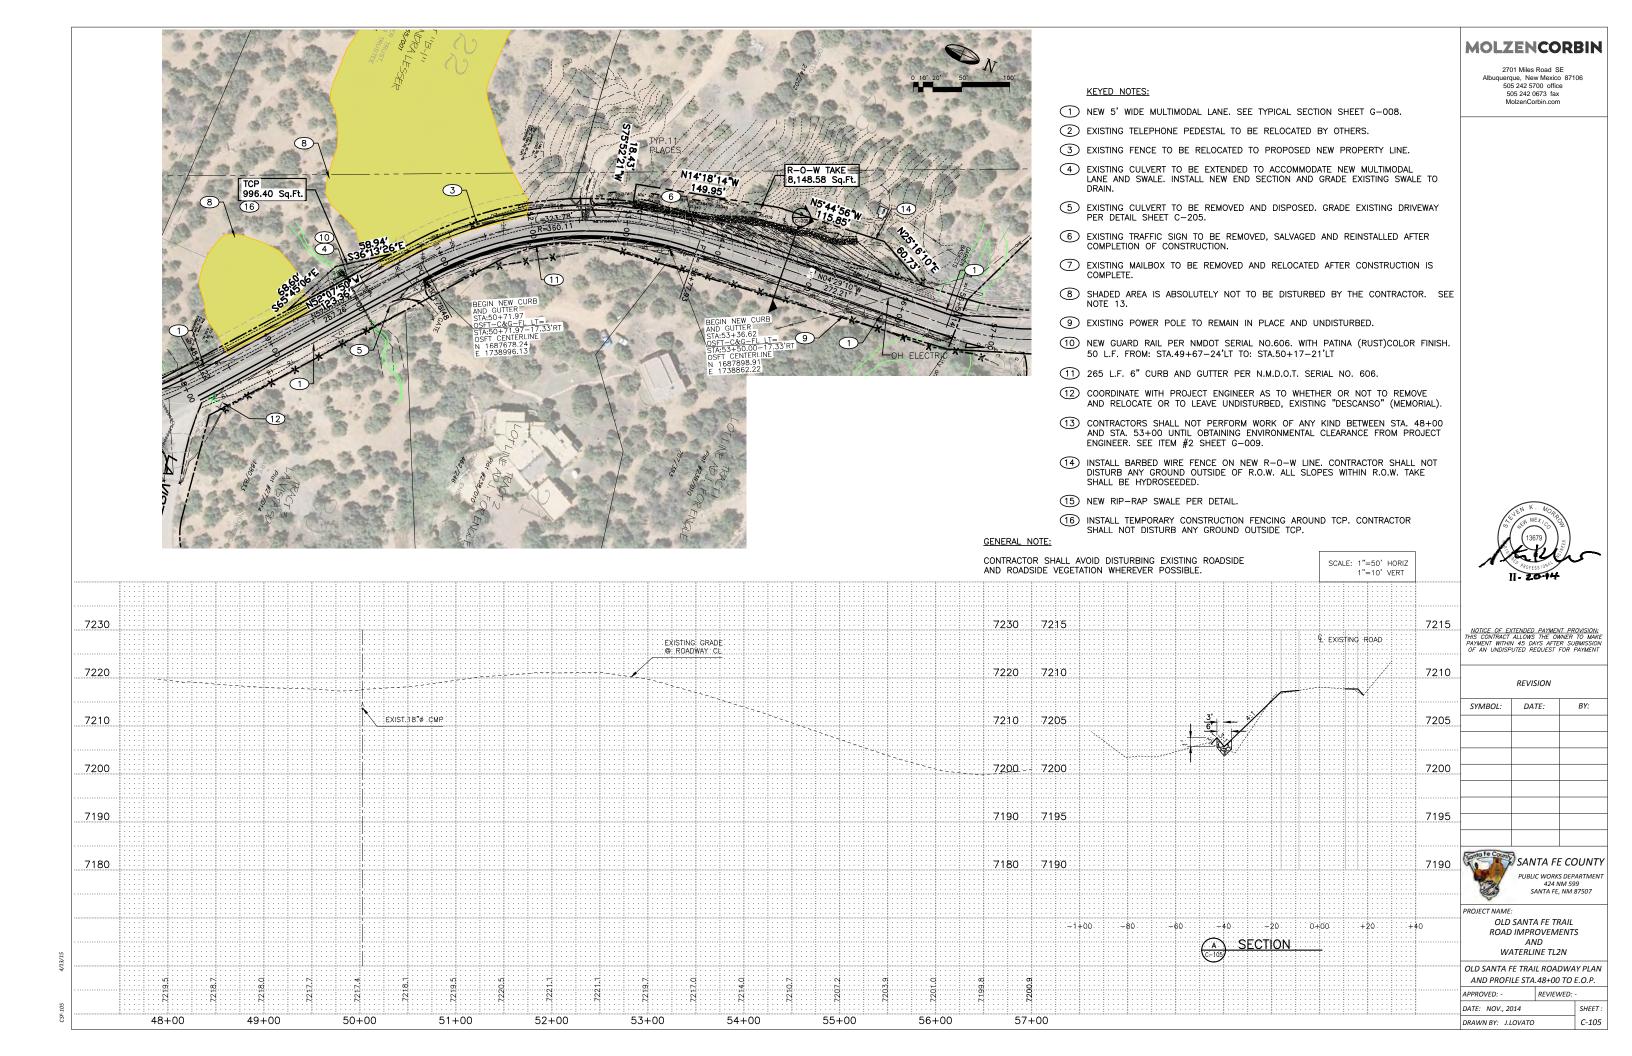

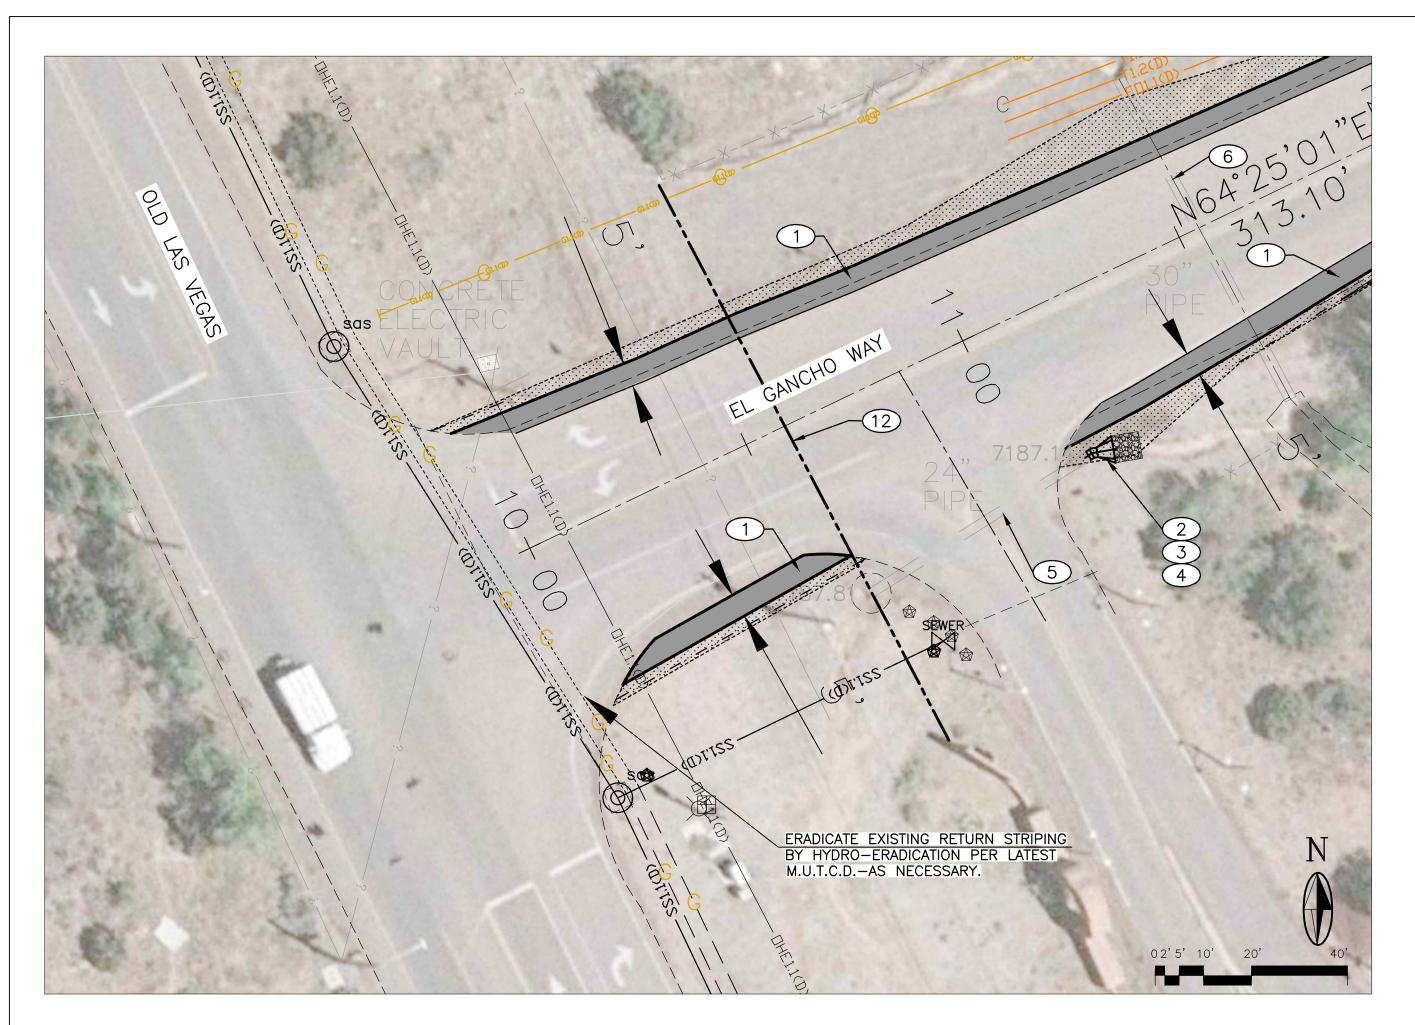

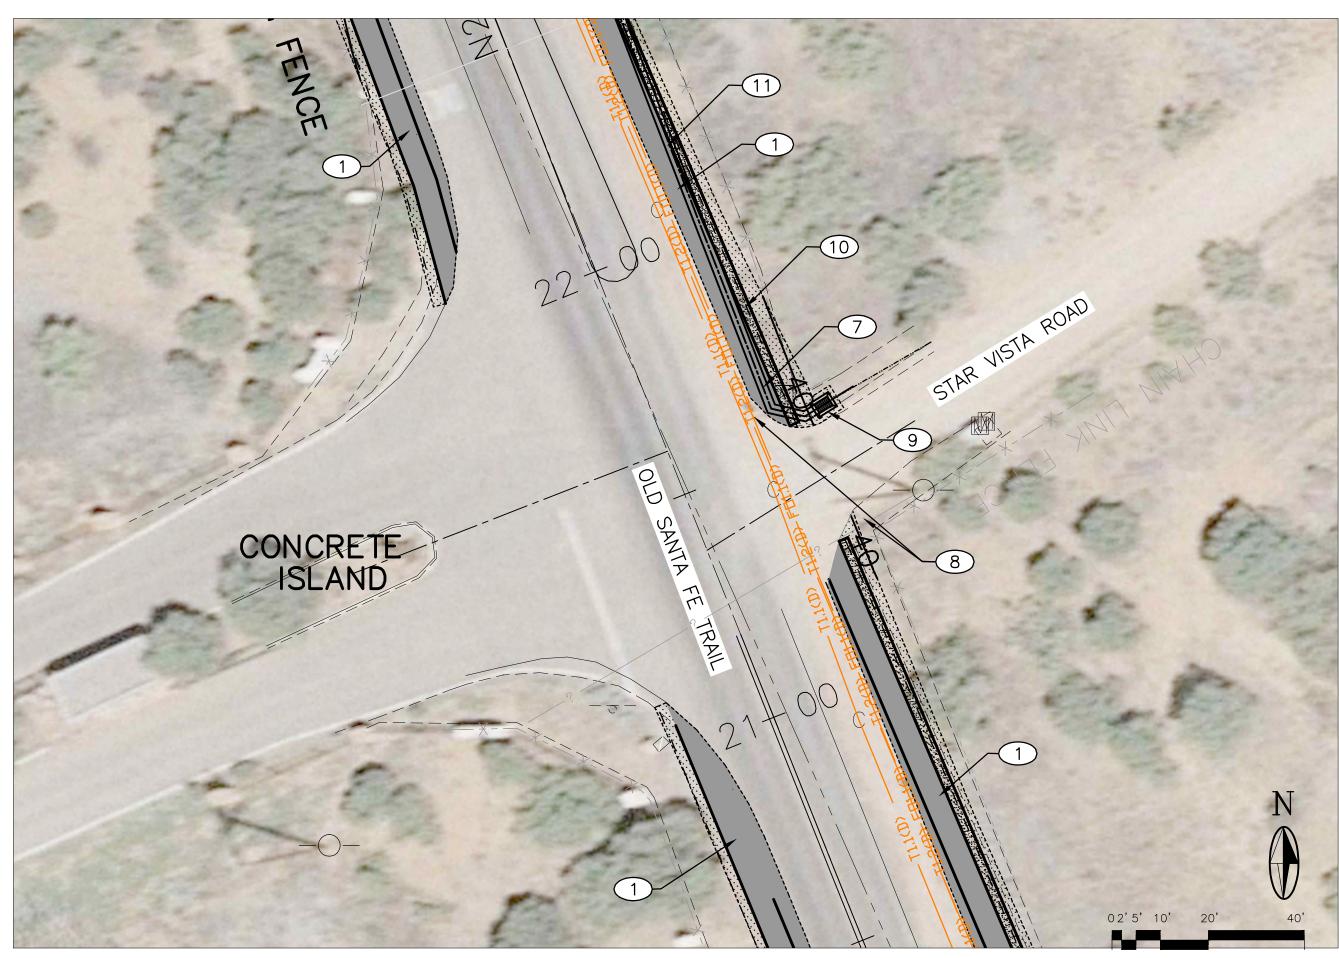

KEYED NOTES:

- 1) NEW 5' WIDE MULTIMODAL LANE. SEE TYPICAL SECTION SHEET G-008.
- 2 EXISTING CULVERT TO BE EXTENDED WITH NEW 24"Ø CMP AS NECESSARY TO ACCOMMODATE NEW MULTIMODAL LANE AND SWALE. INSTALL NEW END SECTION, 22½ BEND, 6'X6'X12" 8" NOMINAL RIP-RAP BLANKET AND GRADE EXISTING SWALE TO DRAIN.
- 3 INSTALL 3'X10'X12" 8" NOMINAL RIP-RAP BLANKET.
- 4 INSTALL SINGLE PRISMATIC REFLECTOR TRAFFIC DELINEATOR ON STEEL "U" CHANNEL POST, PER NMDOT DRAWING 703-01-1/3, AT END OF EXISTING CULVERT. LOCATION OF DELINEATOR TO BE COORDINATED WITH THE PROJECT ENGINEER.
- 5 EXISTING 24" CMP TO REMAIN.
- 6 EXISTING 30" CMP TO REMAIN.
- 7 EXISTING TELEPHONE PEDESTAL TO BE RELOCATED BY OTHERS
- 8 EXISTING TRAFFIC SIGN TO BE REMOVED, SALVAGED AND REINSTALLED AFTER COMPLETION OF NEW CONSTRUCTION.
- 9 NEW MEDIAN DROP INLET PER N.M.D.O.T. SERIAL NO.623-01.
- (10) 6" CURB AND GUTTER PER N.M.D.O.T. SERIAL NO. 609-01. SEE SHEET C-103
- 11) NEW 12" CULVERT. SEE SHEET C-103,
- 12) LIMITS OF NMDOT RIGHT-OF-WAY. CONTRACTOR SHALL OBTAIN ALL NECESSARY PERMITS TO WORK INSIDE NMDOT RIGHT-OF-WAY.



2701 Miles Road SE
Albuquerque, New Mexico 87106
505 242 5700 office
505 242 0673 fax
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NOTICE OF EXTENDED PAYMENT PROVISION: THIS CONTRACT ALLOWS THE OWNER TO MAKE PAYMENT WITHIN 45 DAYS AFTER SUBMISSION OF AN UNDISPUTED REQUEST FOR PAYMENT

SYMBOL: DATE: BY:



PROJECT NAME:

OLD SANTA FE TRAIL

ROAD IMPROVEMENTS


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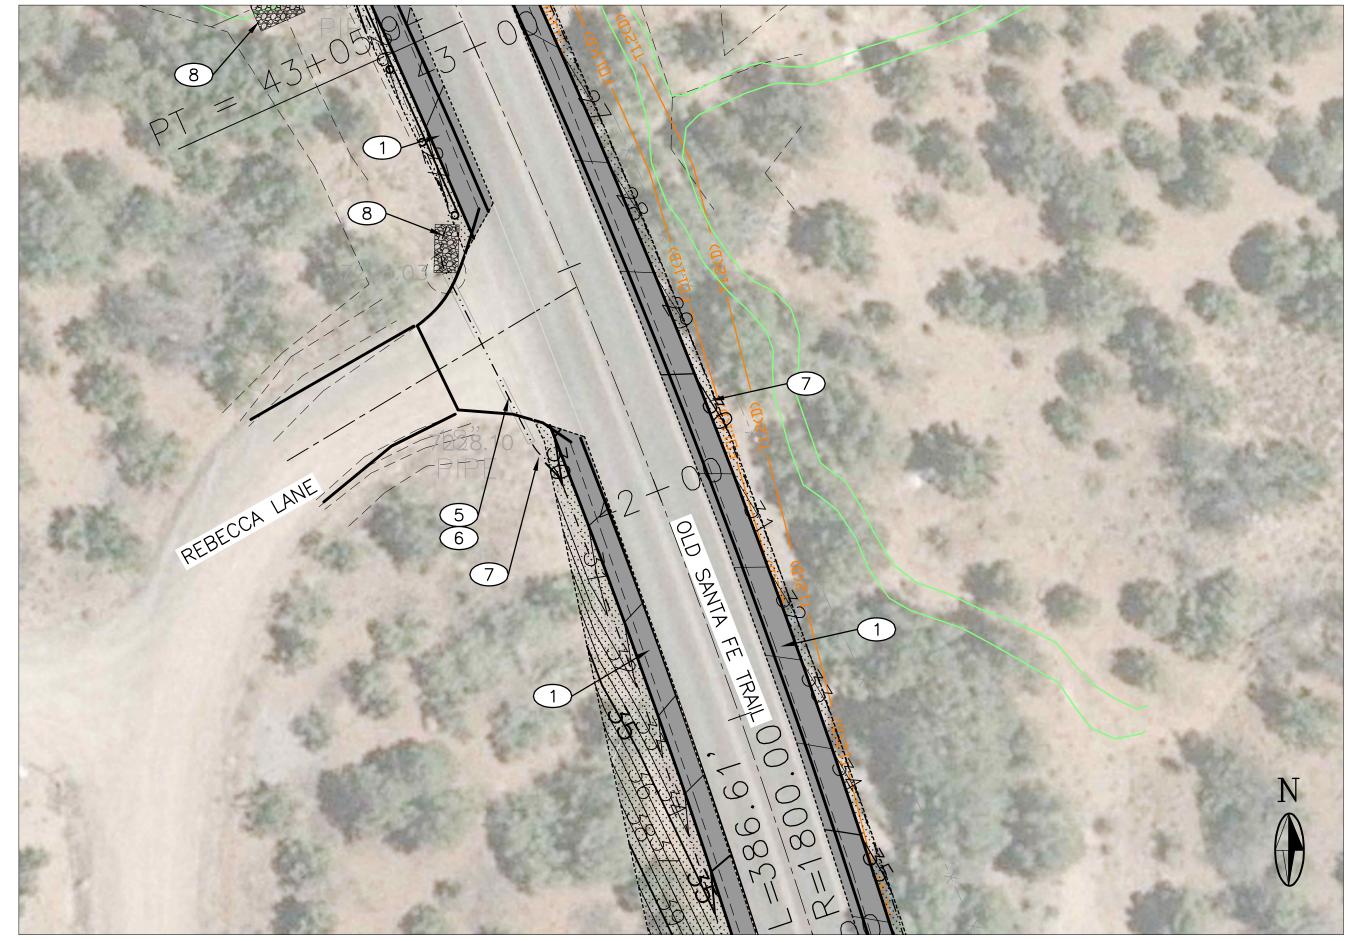
WATERLINE TL2N


INTERSECTION DETAILS

APPROVED: - REVIEWED:
DATE: NOV., 2014 SHEET:

DRAWN BY: J.LOVATO C-201



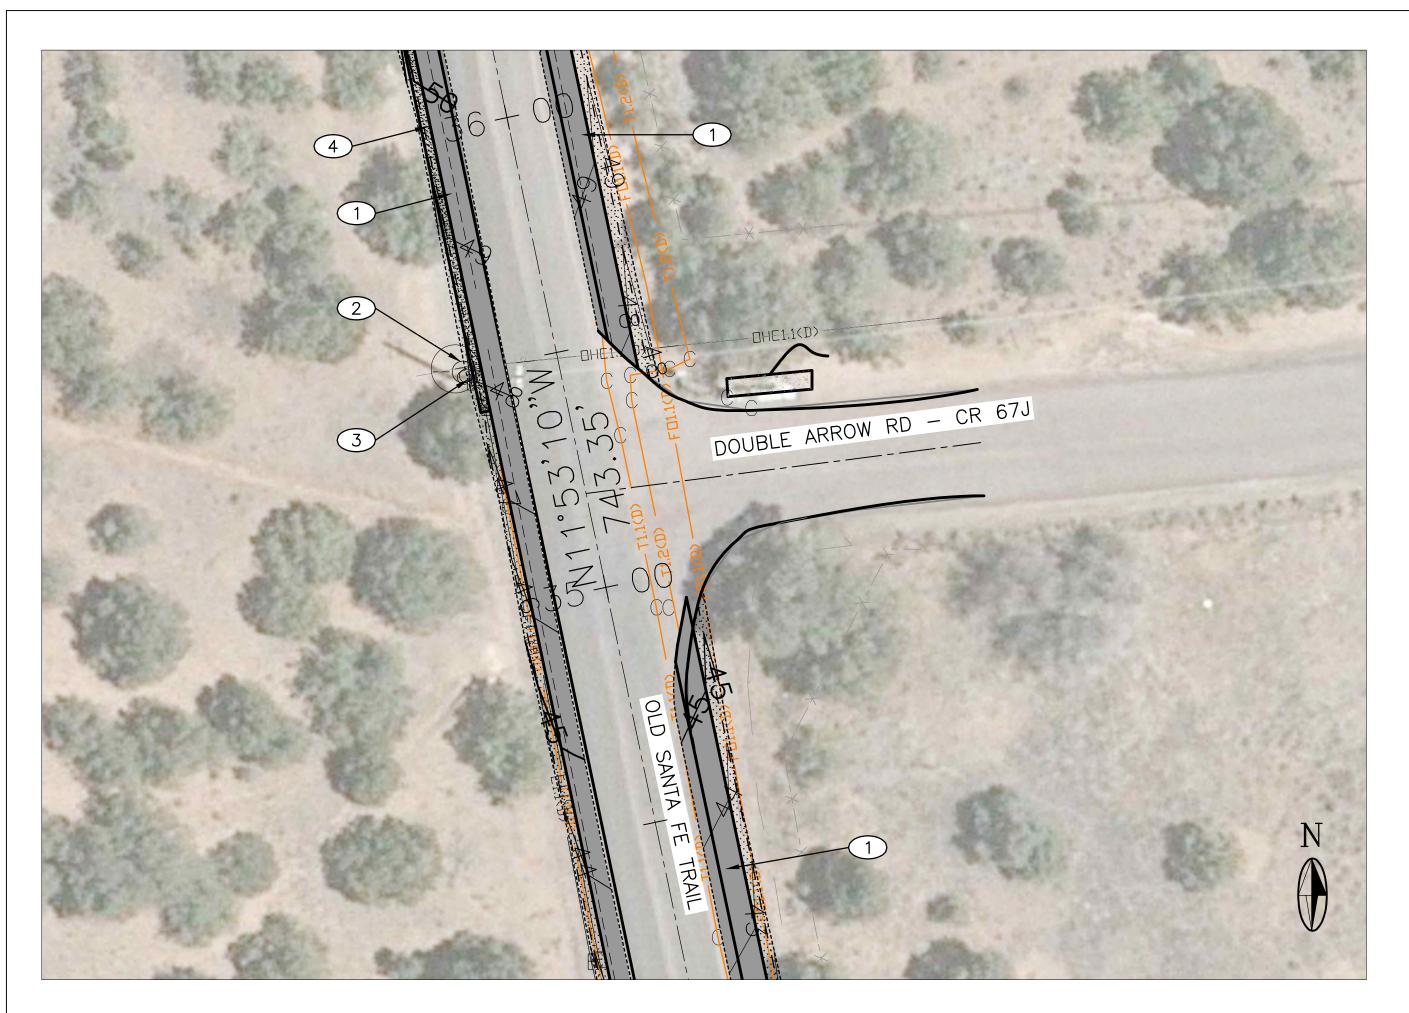

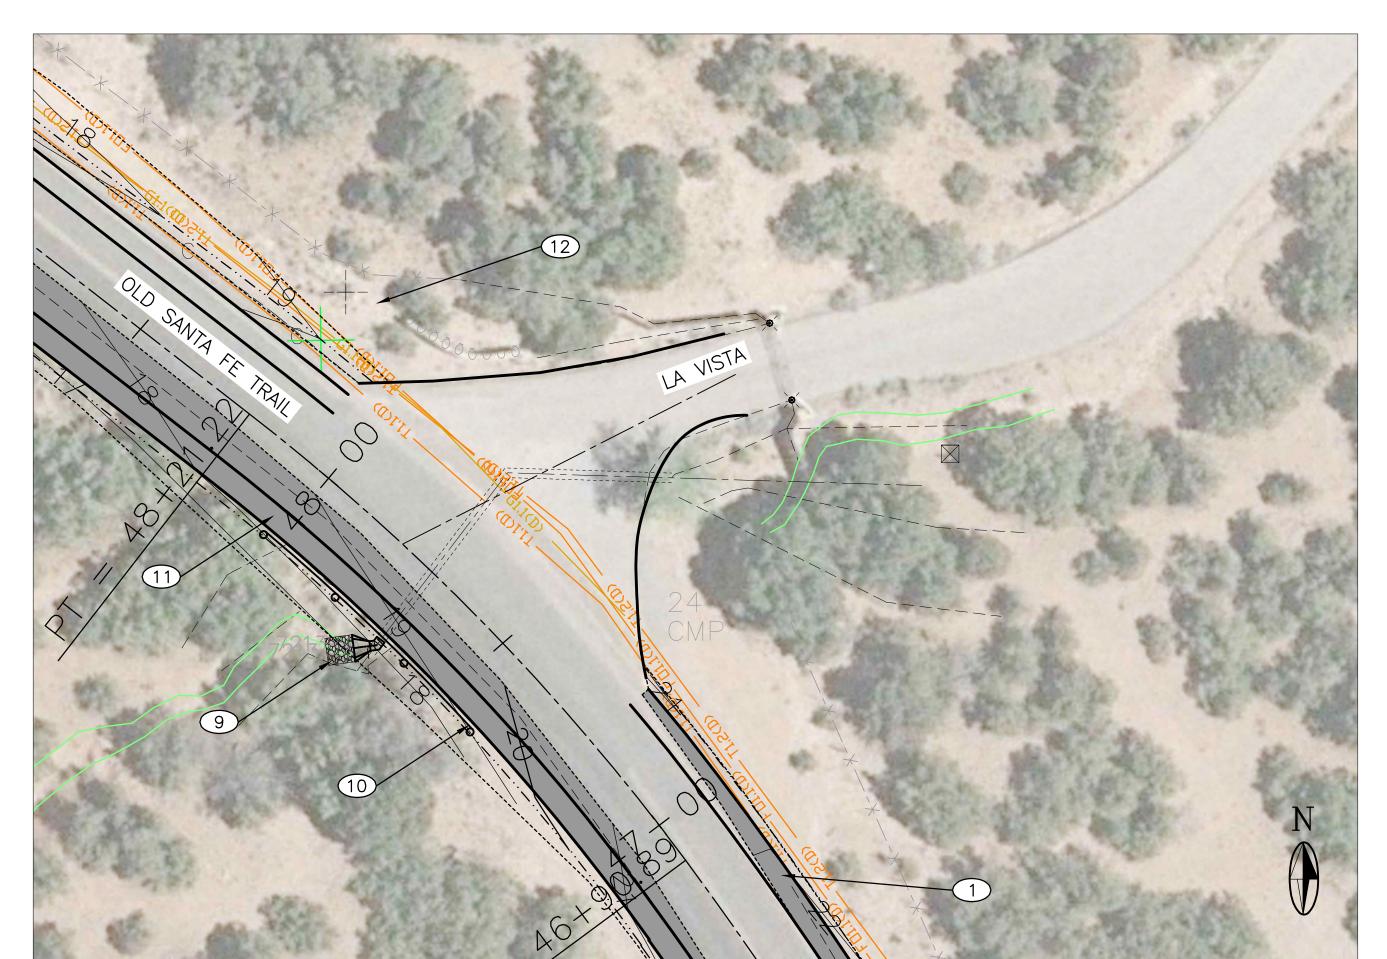

KEYED NOTES:

- (1) NEW 5' WIDE MULTIMODAL LANE. SEE TYPICAL SECTION SHEET G-008.
- (2) EXISTING TELEPHONE PEDESTAL TO BE RELOCATED BY OTHERS.
- 3 EXISTING POWER POLE TO REMAIN IN PLACE AND UNDISTURBED.
- 4) 6" CURB AND GUTTER PER N.M.D.O.T. SERIAL NO. 609-01. SEE SHEET C-104
- 5 EXISTING CULVERT TO REMAIN UNDISTURBED. NO NEW END SECTION ON EITHER SIDE WILL BE REQUIRED ONLY NEW 8" NOMINAL RIP-RAP AND GRADE EXISTING SWALE TO DRAIN. INSTALL SINGLE PRISMATIC REFLECTOR TRAFFIC DELINEATOR ON STEEL "U" CHANNEL POST, PER NMDOT DRAWING 703-01-1/3, AT END OF EXISTING CULVERT. LOCATION OF DELINEATOR TO BE COORDINATED WITH THE PROJECT ENGINEER.
- (6) EXISTING CULVERT TO BE REMAIN UNDISTURBED, GRADE EXISTING INLET AND OUTLET. PLACE 5"X10'X8"NOMINAL RIP-RAP AT OUT.
- 7) EXISTING TRAFFIC SIGN TO BE REMOVED, SALVAGED AND REINSTALLED AFTER COMPLETION OF CONSTRUCTION.
- 8 NSTALL 3'X10'X12" 8" NOMINAL RIP-RAP BLANKET.
- 9 EXISTING CULVERT TO REMAIN WITH NEW 24"Ø 45° BEND AND NEW END SECTION AND 5'X5'X12"-8" NOMINAL RIP-RAP. GRADE EXISTING SWALE TO DRAIN. INSTALL SINGLE PRISMATIC REFLECTOR TRAFFIC DELINEATOR ON STEEL "U" CHANNEL POST, PER NMDOT DRAWING 703-01-1/3, AT END OF EXISTING CULVERT. LOCATION OF DELINEATOR TO BE COORDINATED WITH THE PROJECT ENGINEER.
- 10) NEW GUARD RAIL PER NMDOT SERIAL NO. 606. WITH PATINA (RUST)COLOR FINISH. 62 L.F. FROM: STA.47+40-18'LT TO: STA.48+02-22'LT
- (11) NEW ASPHALT REALIGNED PAVEMENT. SEE SHEET C-105.
- (12) COORDINATE WITH PROJECT ENGINEER AS TO WHETHER OR NOT TO REMOVE AND RELOCATE OR TO LEAVE UNDISTURBED, EXISTING "DESCANSO" (MEMORIAL).



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NOTICE OF EXTENDED PAYMENT PROVISION: THIS CONTRACT ALLOWS THE OWNER TO MAKE PAYMENT WITHIN 45 DAYS AFTER SUBMISSION OF AN UNDISPUTED REQUEST FOR PAYMENT

REVISION

SYMBOL:	DATE:	BY:





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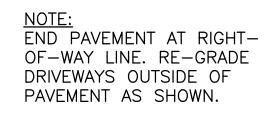
OLD SANTA FE TRAIL ROAD IMPROVEMENTS AND**WATERLINE TL2N**


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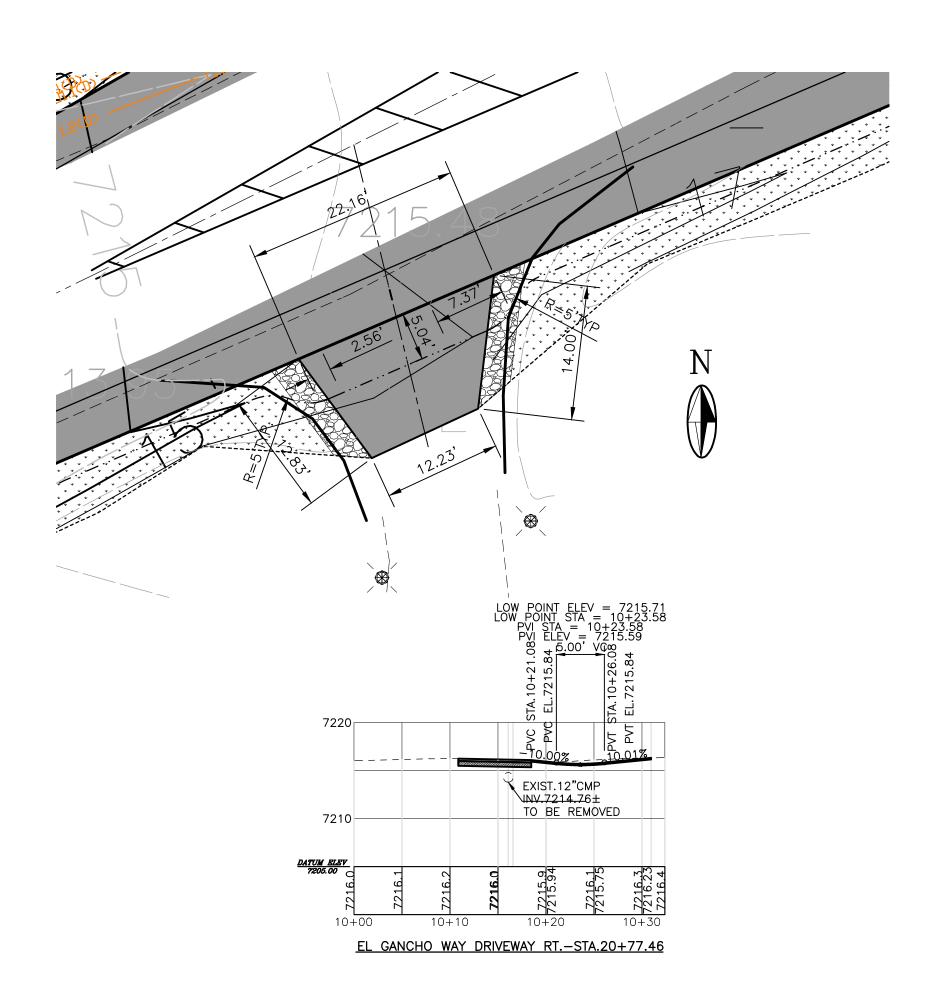
APPROVED: -REVIEWED: -DATE: NOV., 2014 C-202 DRAWN BY: J.LOVATO





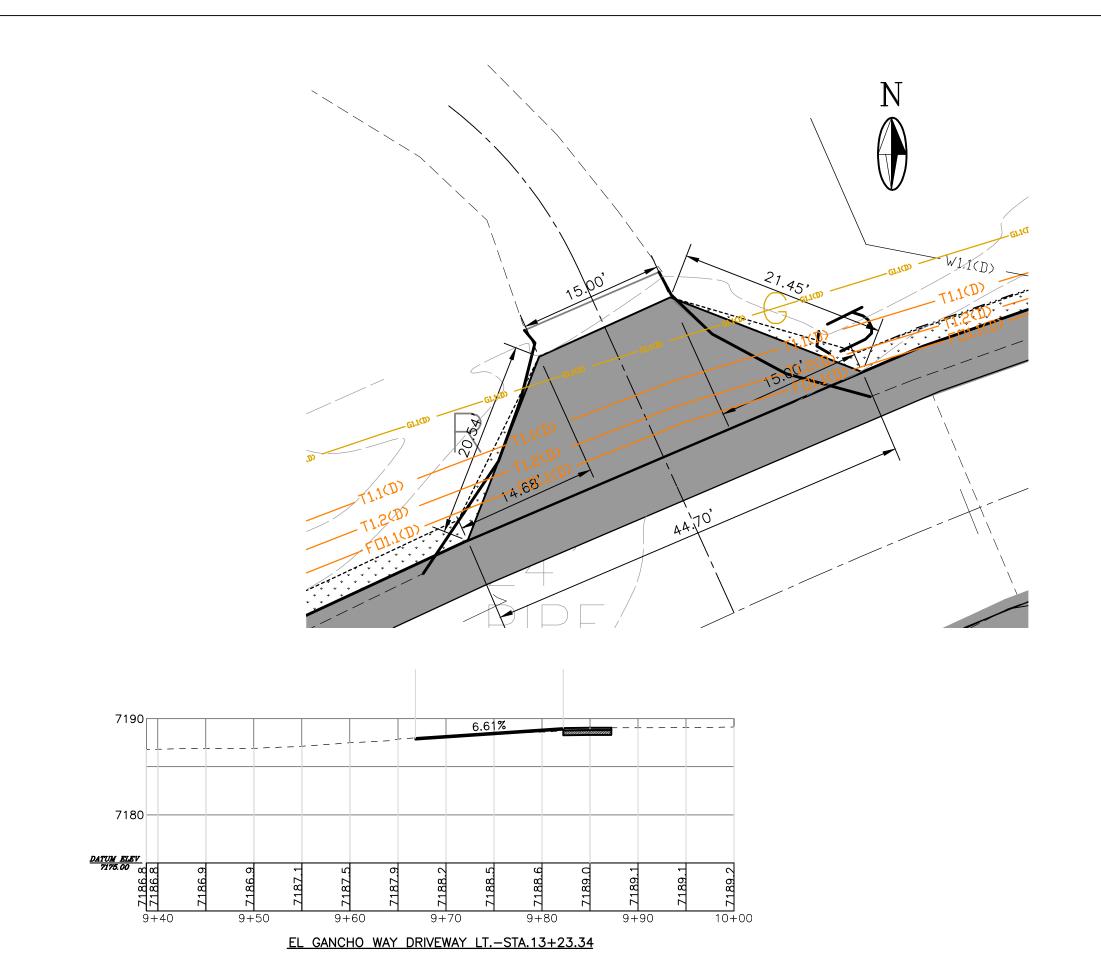

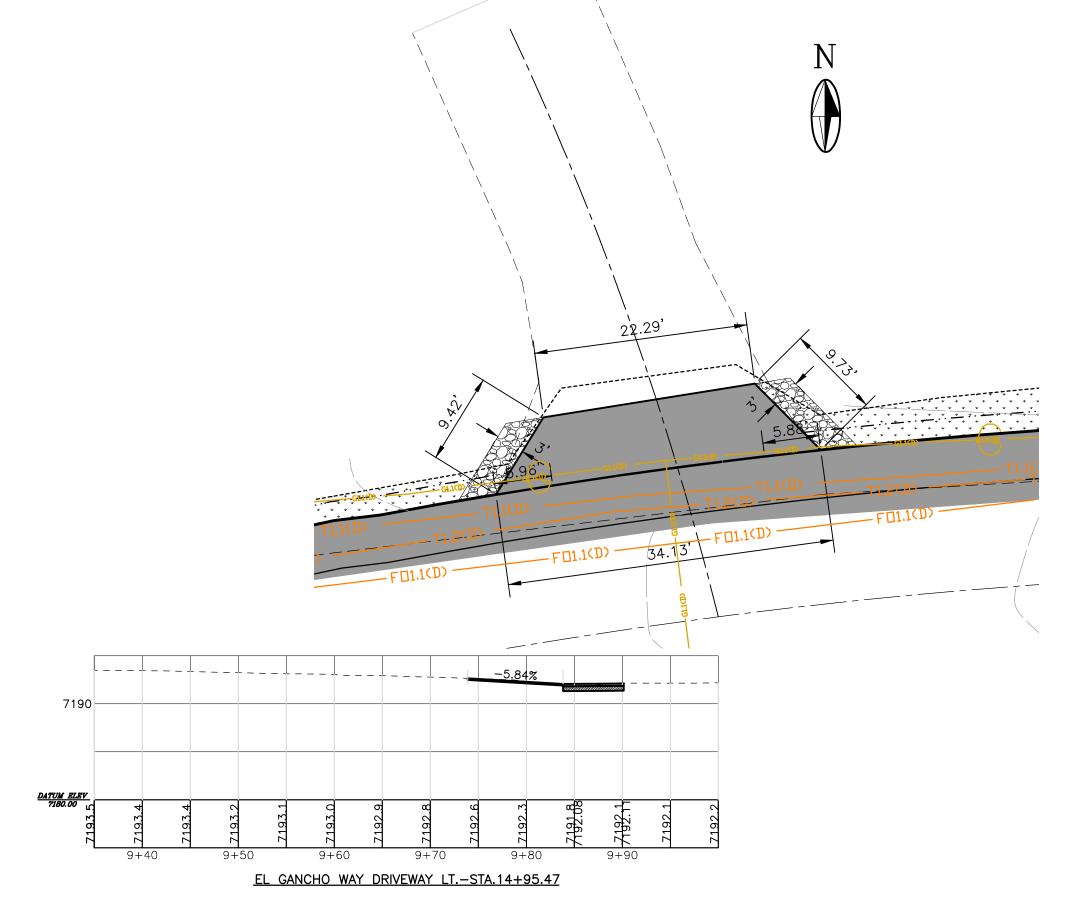

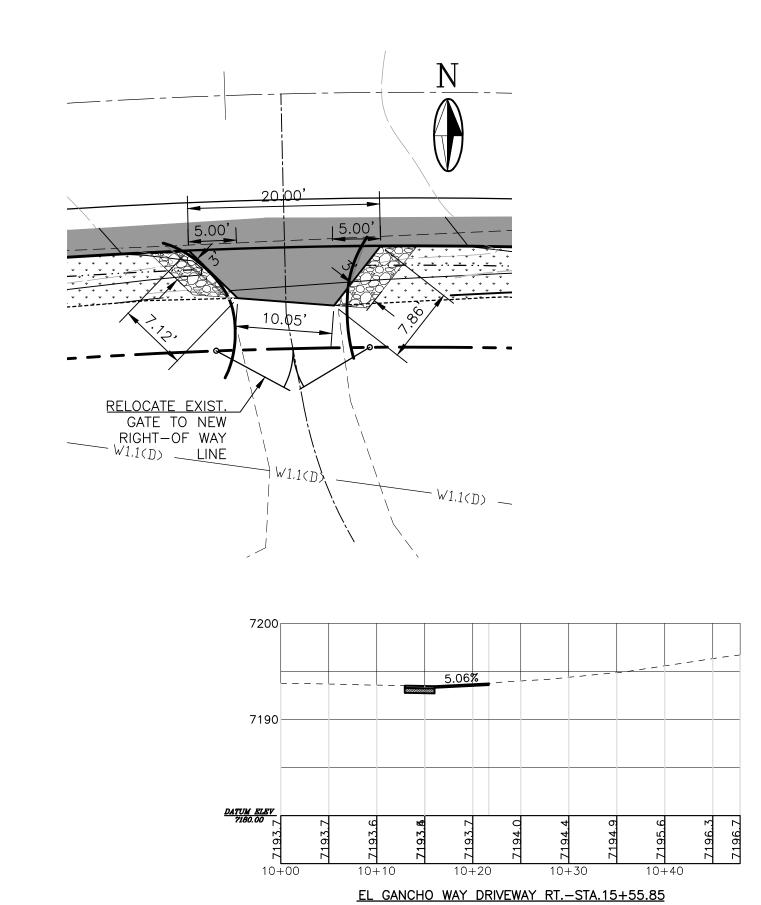



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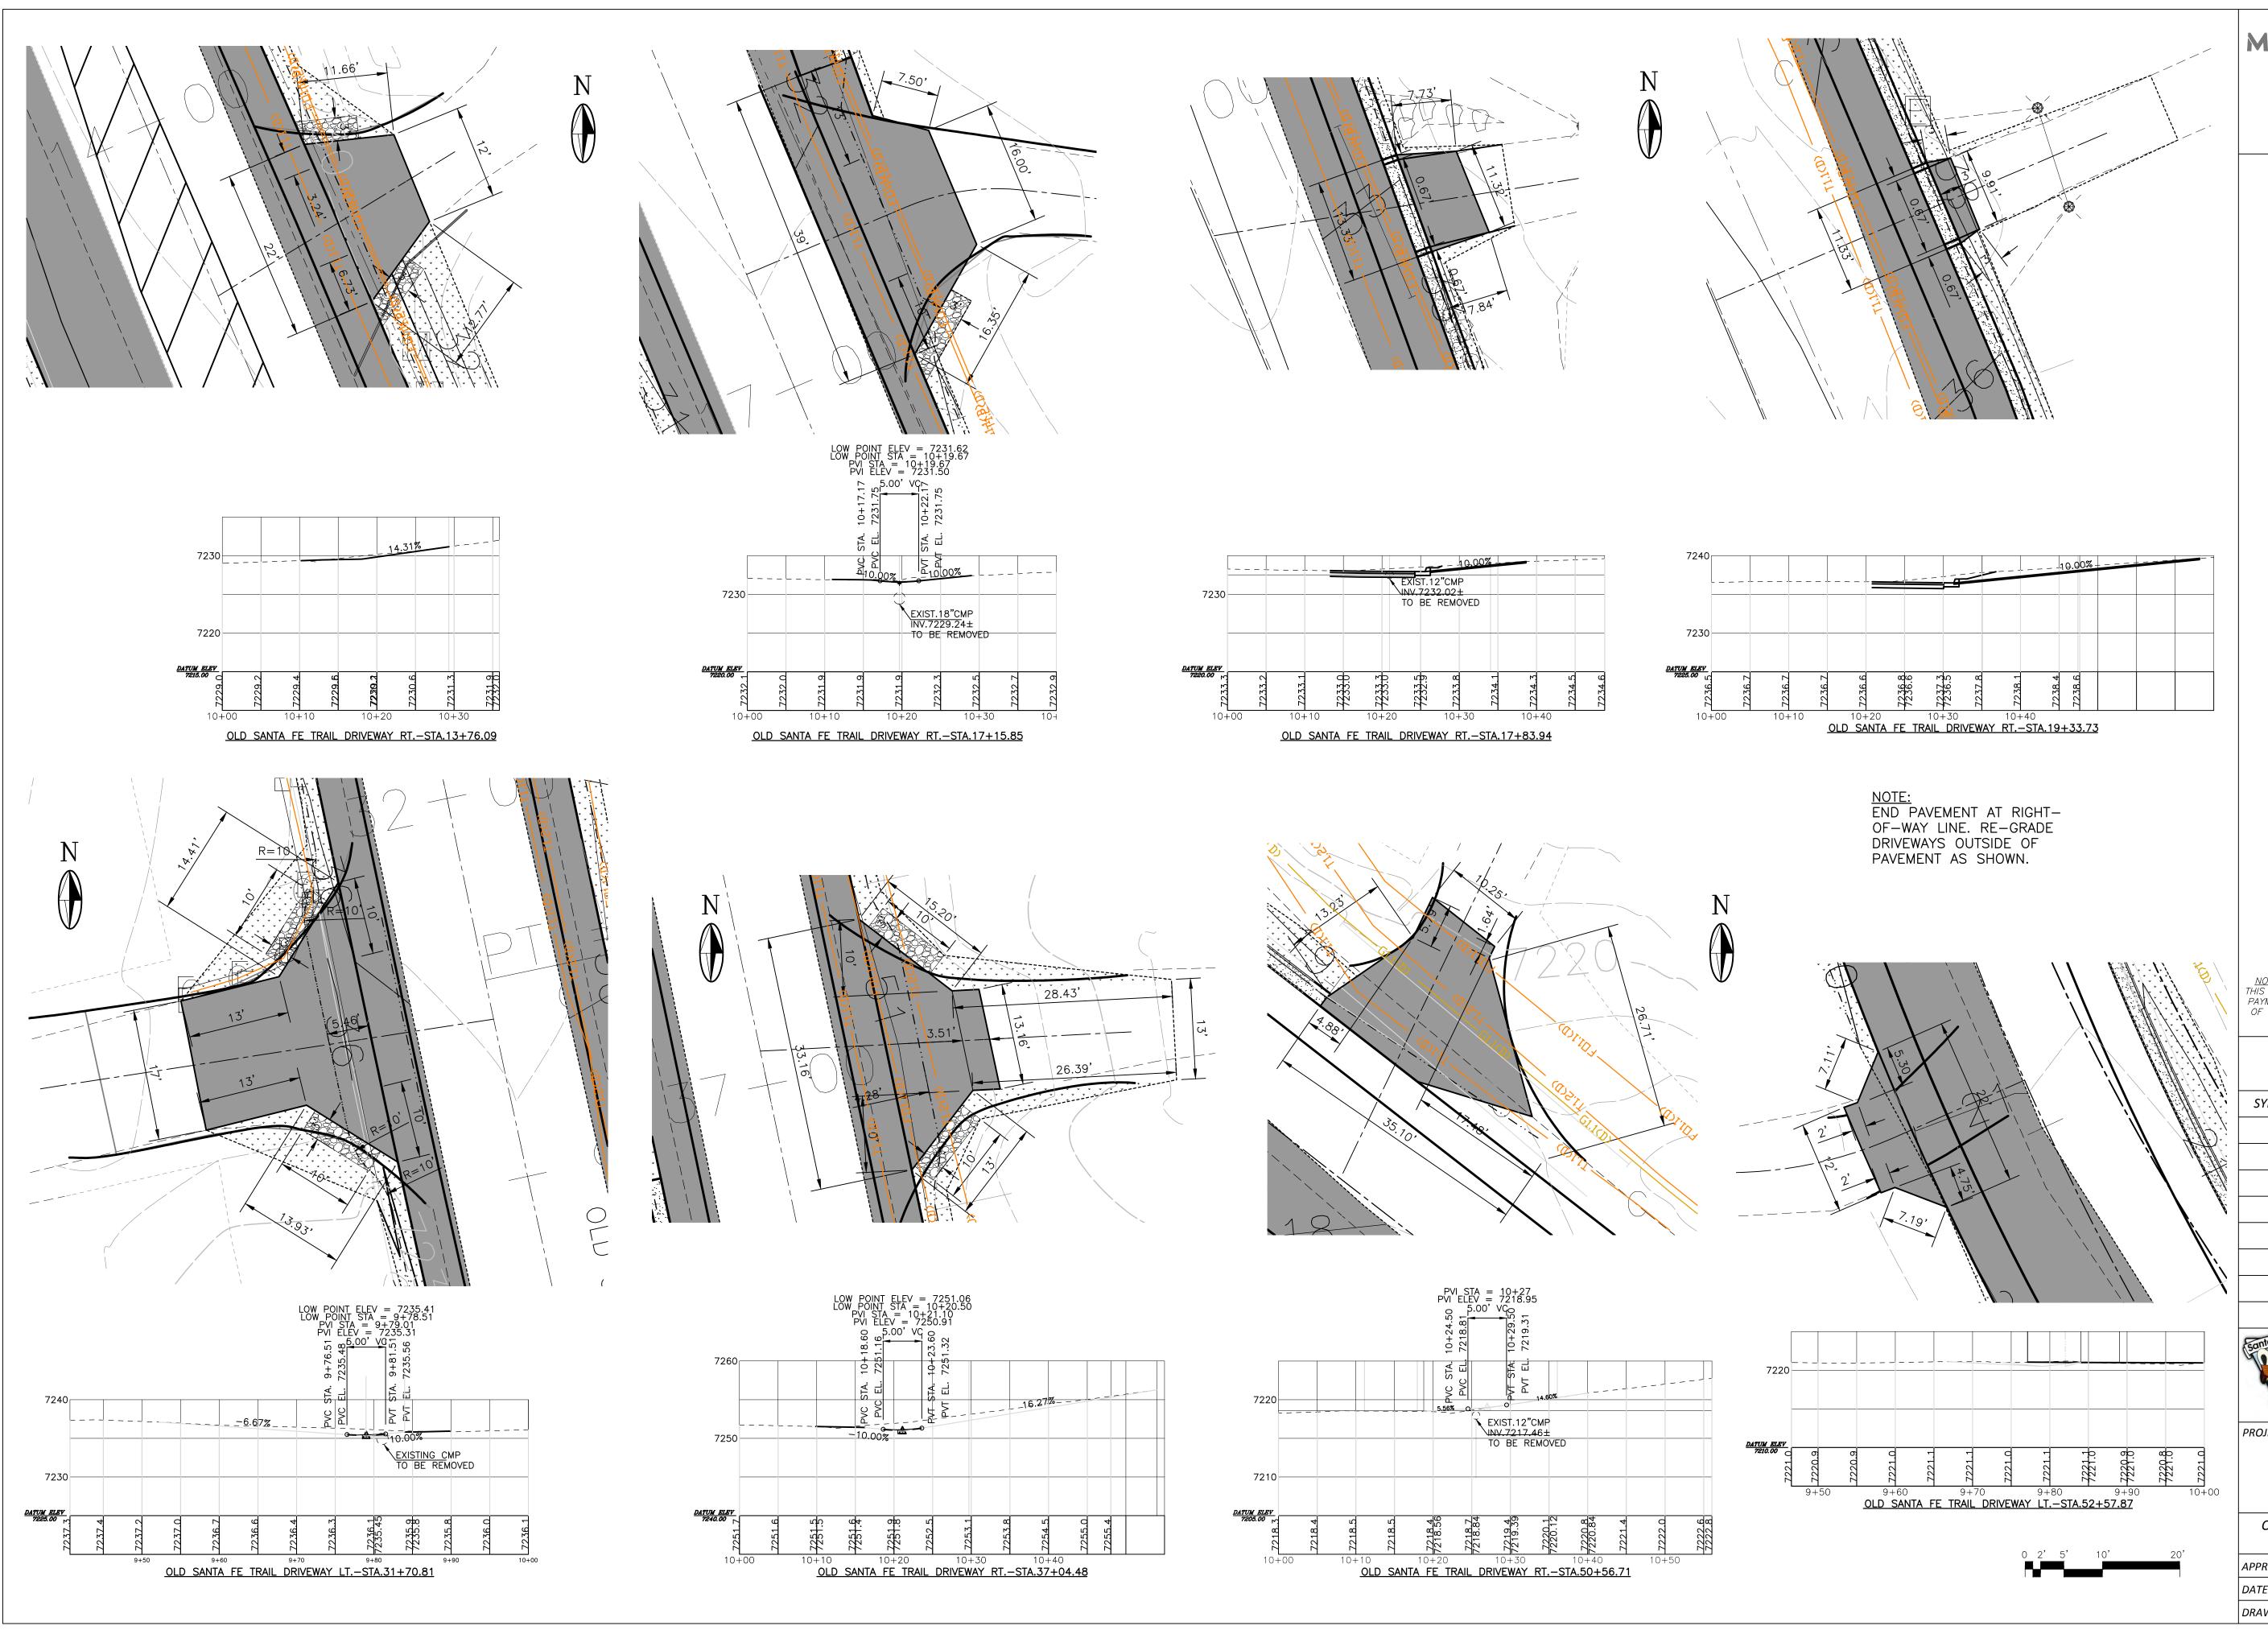


PROJECT NAME:

OLD SANTA FE TRAIL ROAD IMPROVEMENTS AND WATERLINE TL2N

EL GANCHO WAY DRIVEWAY
PLAN AND PROFILES

PROVED: -	REVIEWED:	-	
TE: NOV., 2014		SHEET:	
AWN BY: J.LOVATO		C-203	



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NOTICE OF EXTENDED PAYMENT PROVISION: THIS CONTRACT ALLOWS THE OWNER TO MAKE PAYMENT WITHIN 45 DAYS AFTER SUBMISSION OF AN UNDISPUTED REQUEST FOR PAYMENT

REVISION	

SYMBOL:	DATE:	BY:



PROJECT NAME:

OLD SANTA FE TRAIL ROAD IMPROVEMENTS AND

OLD SANTA FE TRAIL DRIVEWAY
PLAN AND PROFILES

WATERLINE TL2N

APPROVED: -	REVIEWED:	-
DATE: NOV., 2014		SHEET:
DRAWN BY: J.LOVATO		C-204

300 | TO | 300 | TO |

NOTE:

- EXISTING TRAFFIC SIGNS TO BE REMOVED, SALVAGED AND REINSTALLED AFTER COMPLETION OF CONSTRUCTION.
- 2. ALL TRAFFIC SIGNS MST BE SALVAGED IN A MANNER AS TO PROTECT ALL SIGN FACES FROM DAMAGE.
- 3. SIGNS MUST BE REINSTALLED USING APPROPRIATE SIGN ANCHOR HARDWARE IN THE SAME LOCATION WHERE REMOVED \pm (PLUS OR MINUS WITHIN CONSTRUCTION LIMITS).
- 4. SIGN ANCHOR SHALL NOT EXCEED MORE THAN 6" ABOVE GROUND.
- 5. ALL REGULATORY SIGNS SHALL BE PLACE ON TEMPORARY STANDS IF NEEDED TO BE REMOVED FOR CONSTRUCTION PURPOSES.
- 6. CONTRACTOR SHALL COORDINATE WITH SANTA FE COUNTY PUBLIC WORKS TRAFFIC DIVISION REGARDING RELOCATION OF SOLAR SCHOOL FLASHER SIGNS IF NECESSARY.

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Albuquerque, New Mexico 87106
505 242 5700 office
505 242 0673 fax
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	REVISION				
SYMBOL	: DATE:	BY:			
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PROJECT NAME:


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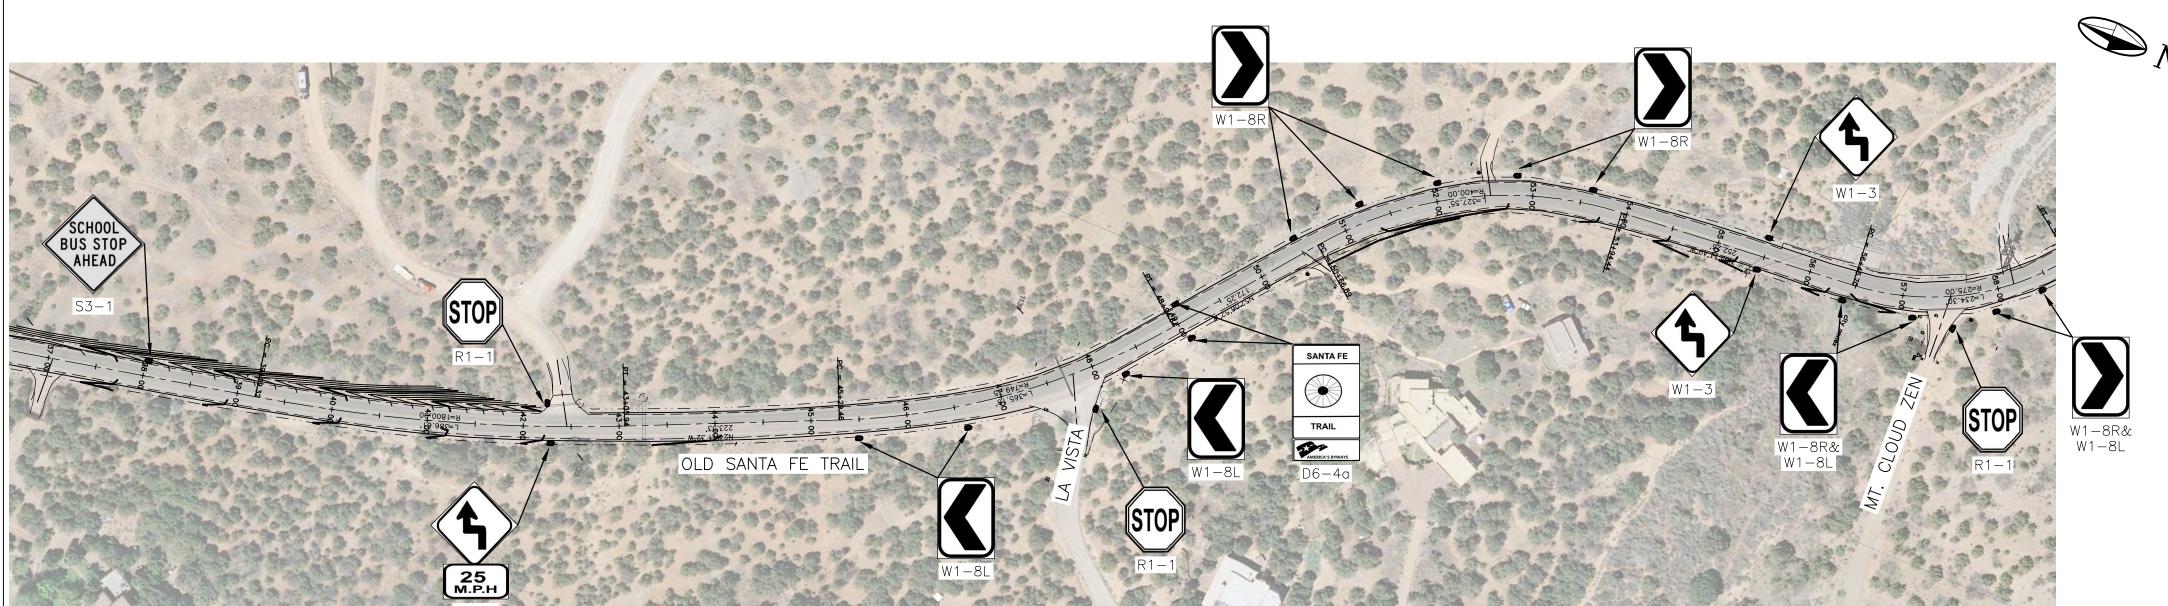
EXISTING SIGNAGE PLAN


WATERLINE TL2N

APPROVED: - REVIEWED:
DATE: NOV., 2014 SHEET:

DRAWN BY: J.LOVATO C-301



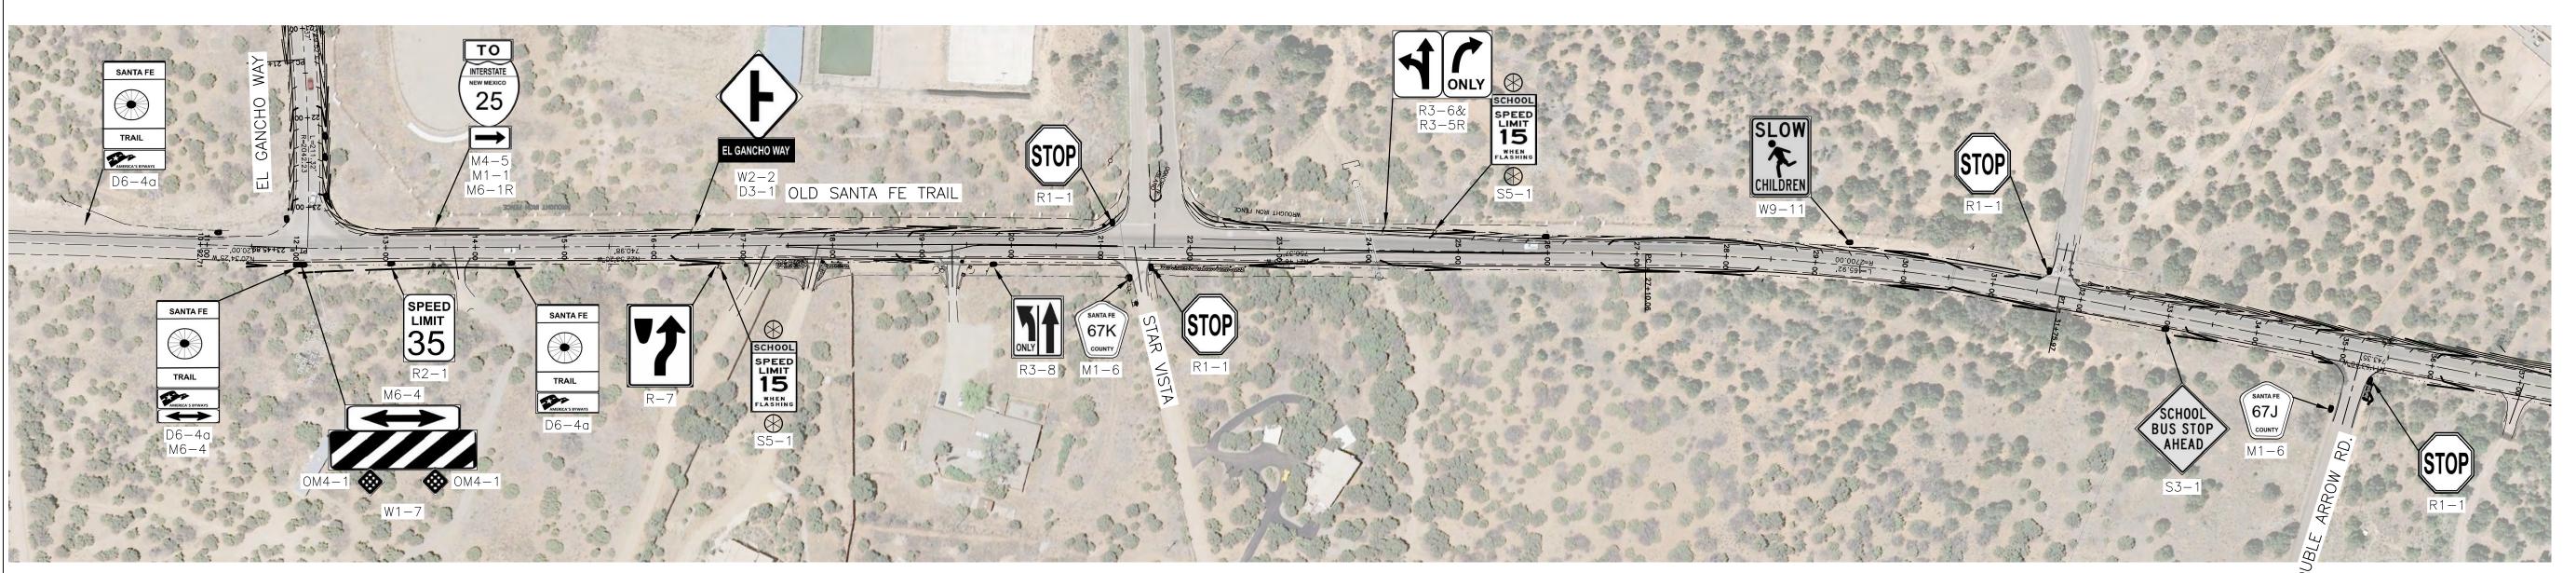

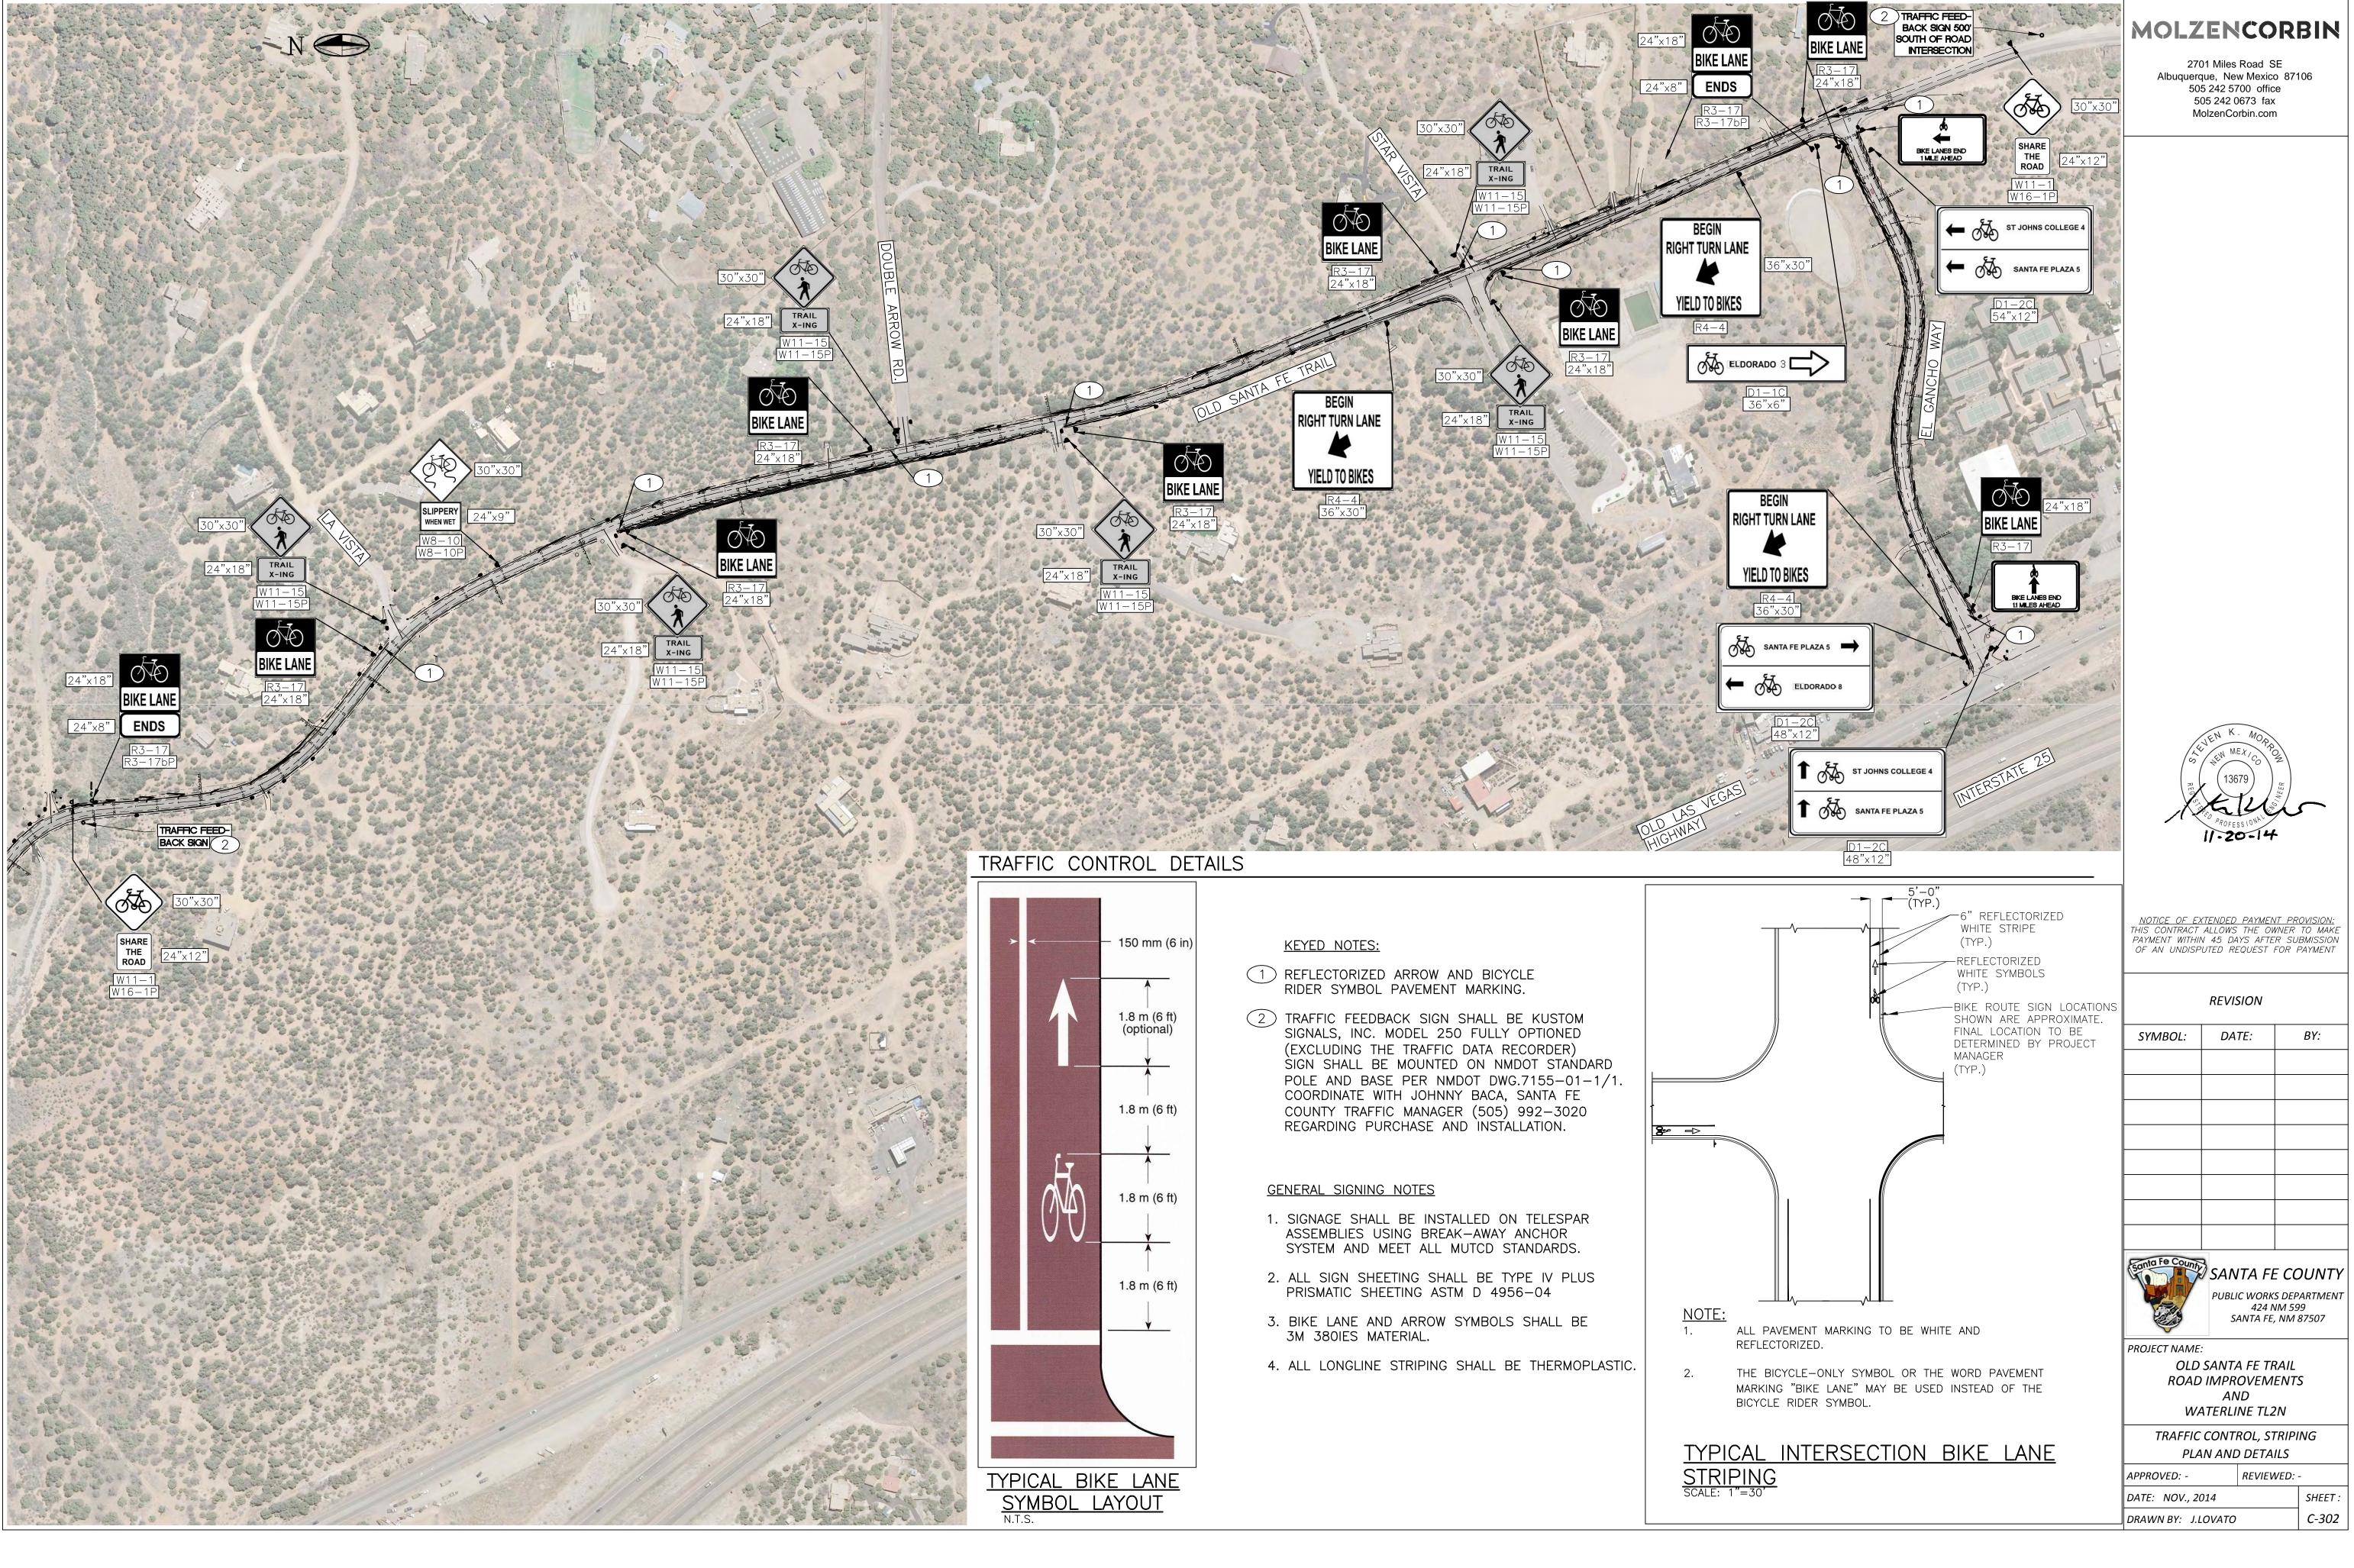




NOTICE OF EXTENDED PAYMENT PROVISION: THIS CONTRACT ALLOWS THE OWNER TO MAKE PAYMENT WITHIN 45 DAYS AFTER SUBMISSION OF AN UNDISPUTED REQUEST FOR PAYMENT

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PROJECT NAME:

ARE SHOWN IN APPROXIMATE LOCATION ONLY.

OWNERS AND TO CONDUCT ALL NECESSARY FIELD

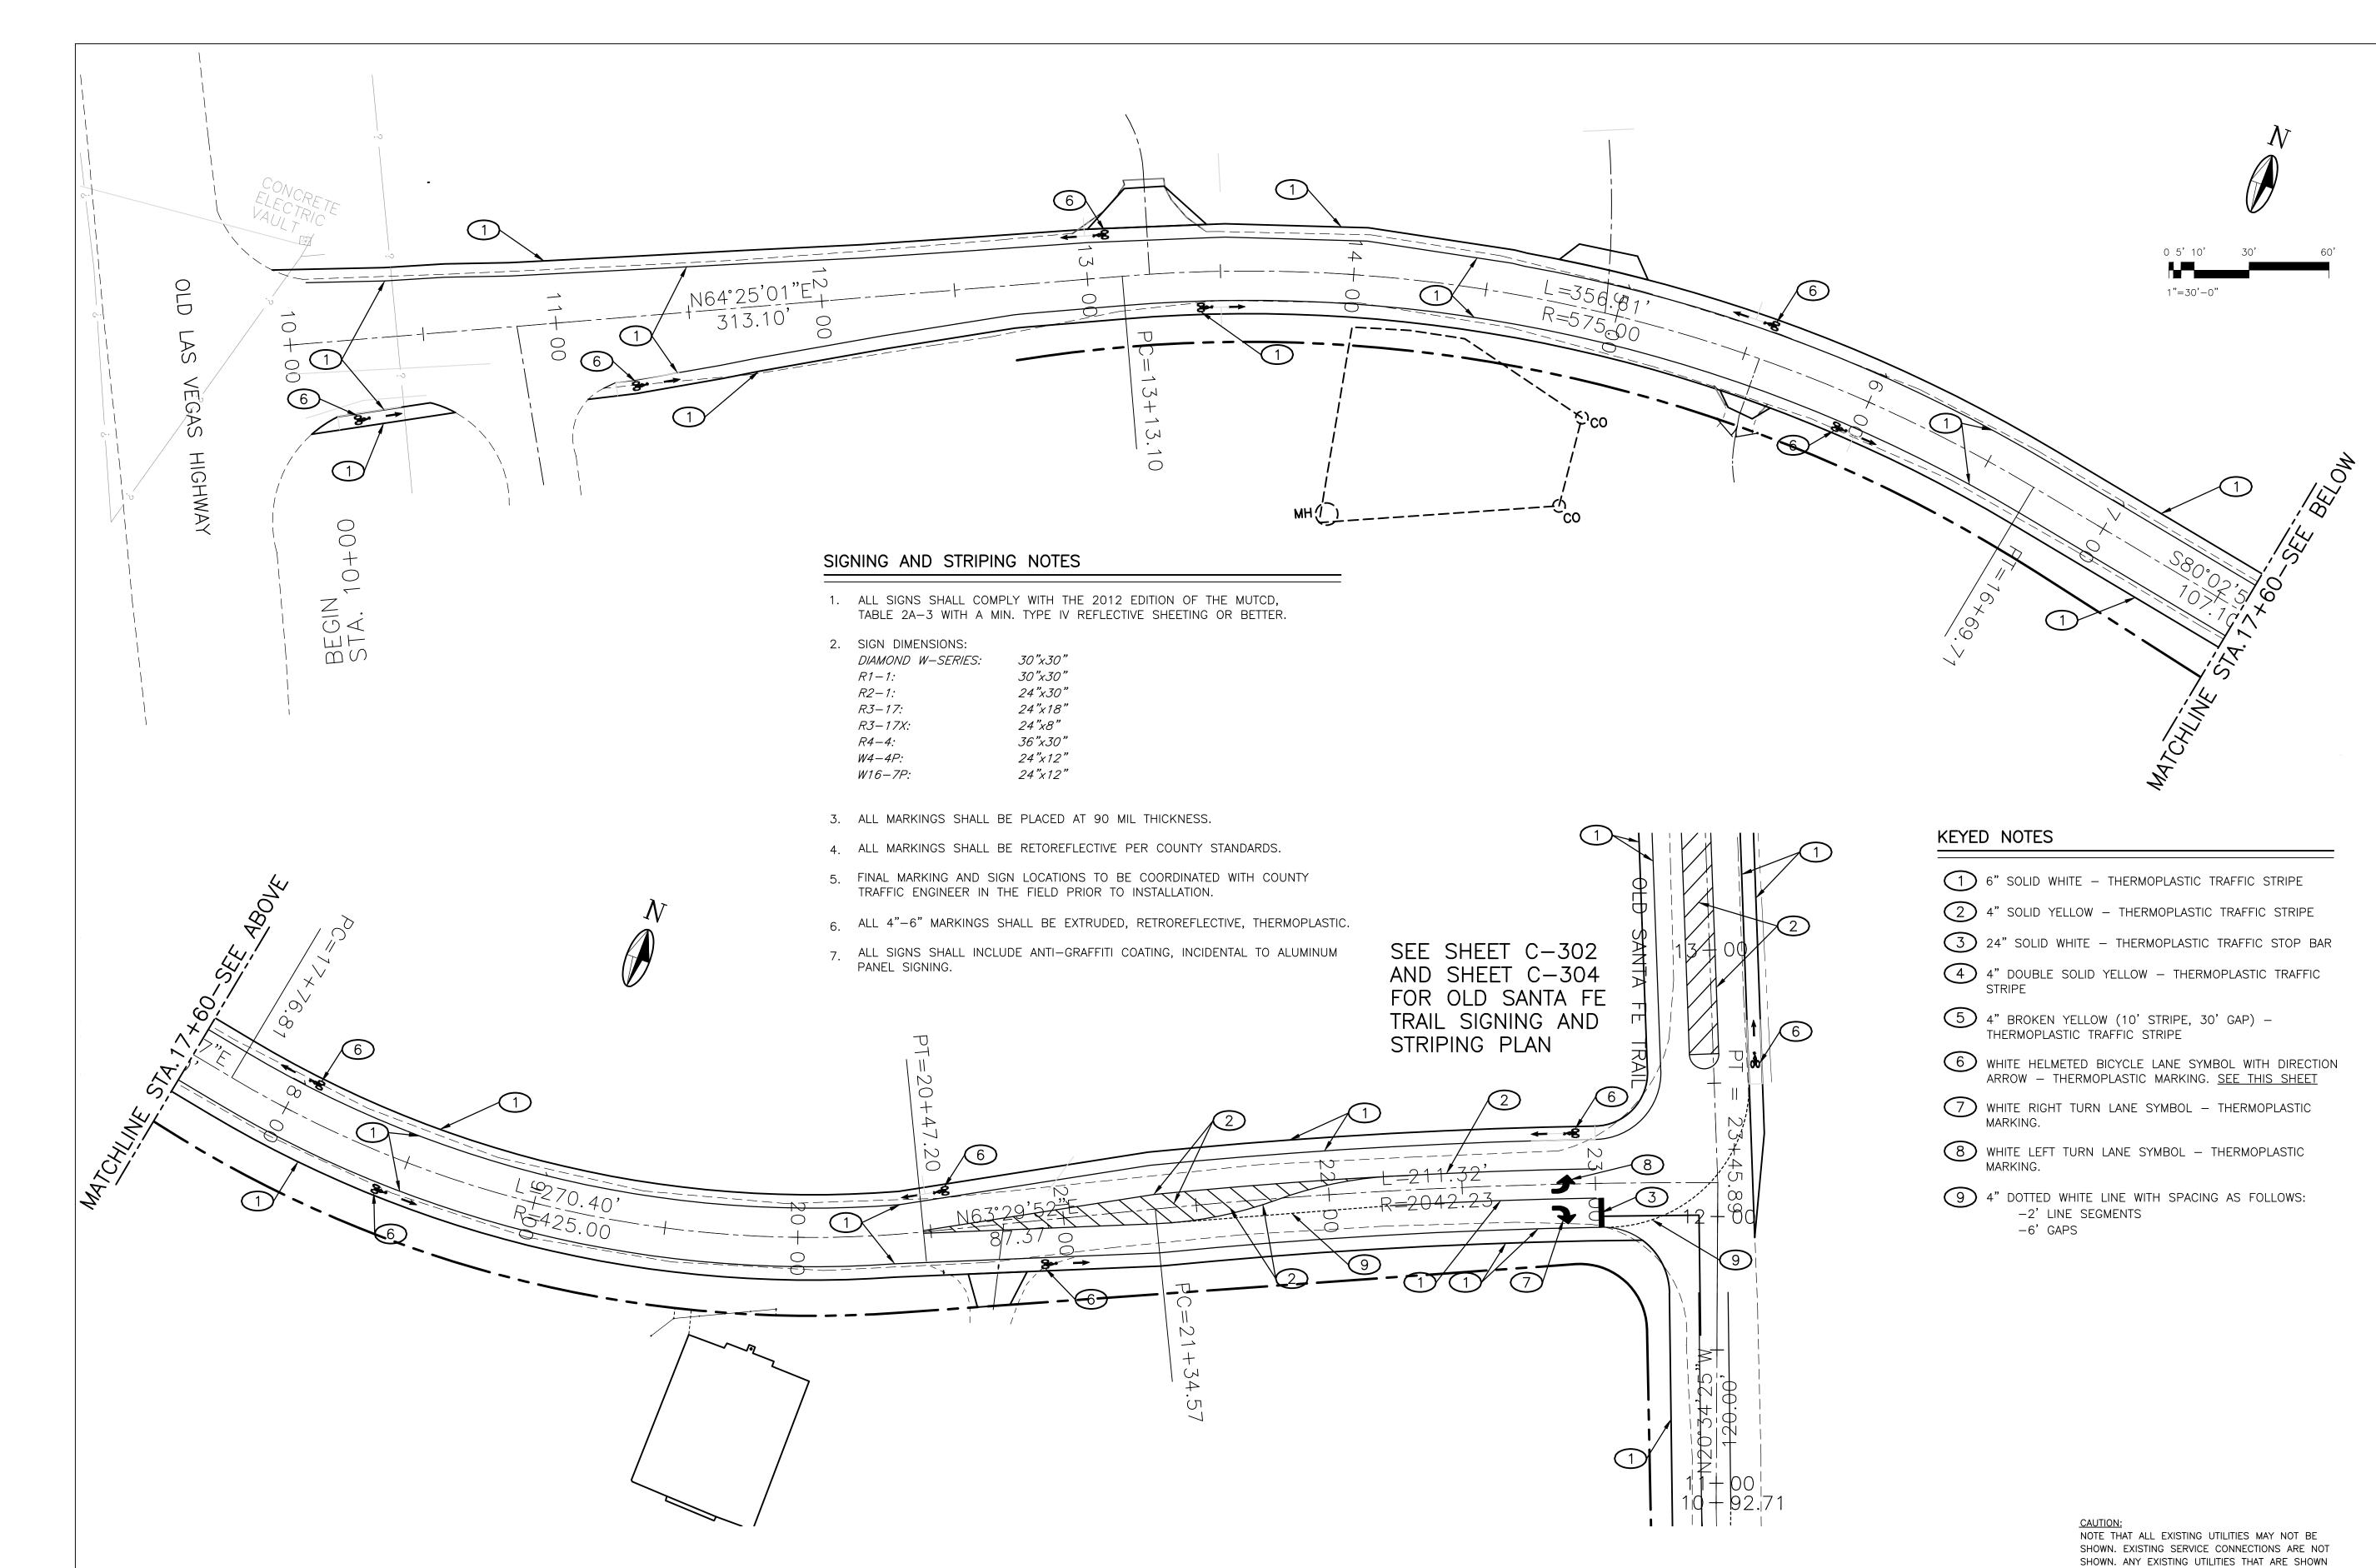INVESTIGATIONS PRIOR TO ANY EXCAVATION TO

DETERMINE THE ACTUAL LOCATION OF UTILITIES

IT SHALL BE THE RESPONSIBILITY OF THE CONTRACTOR TO CONTACT ALL THE UTILITY

AND OTHER IMPROVEMENTS.


OLD SANTA FE TRAIL ROAD IMPROVEMENTS AND

EL GANCHO WAY STRIPING PLAN

WATERLINE TL2N

APPROVED: - REVIEWED:
DATE: NOV., 2014 SHEET:

DRAWN BY: J.LOVATO C-303

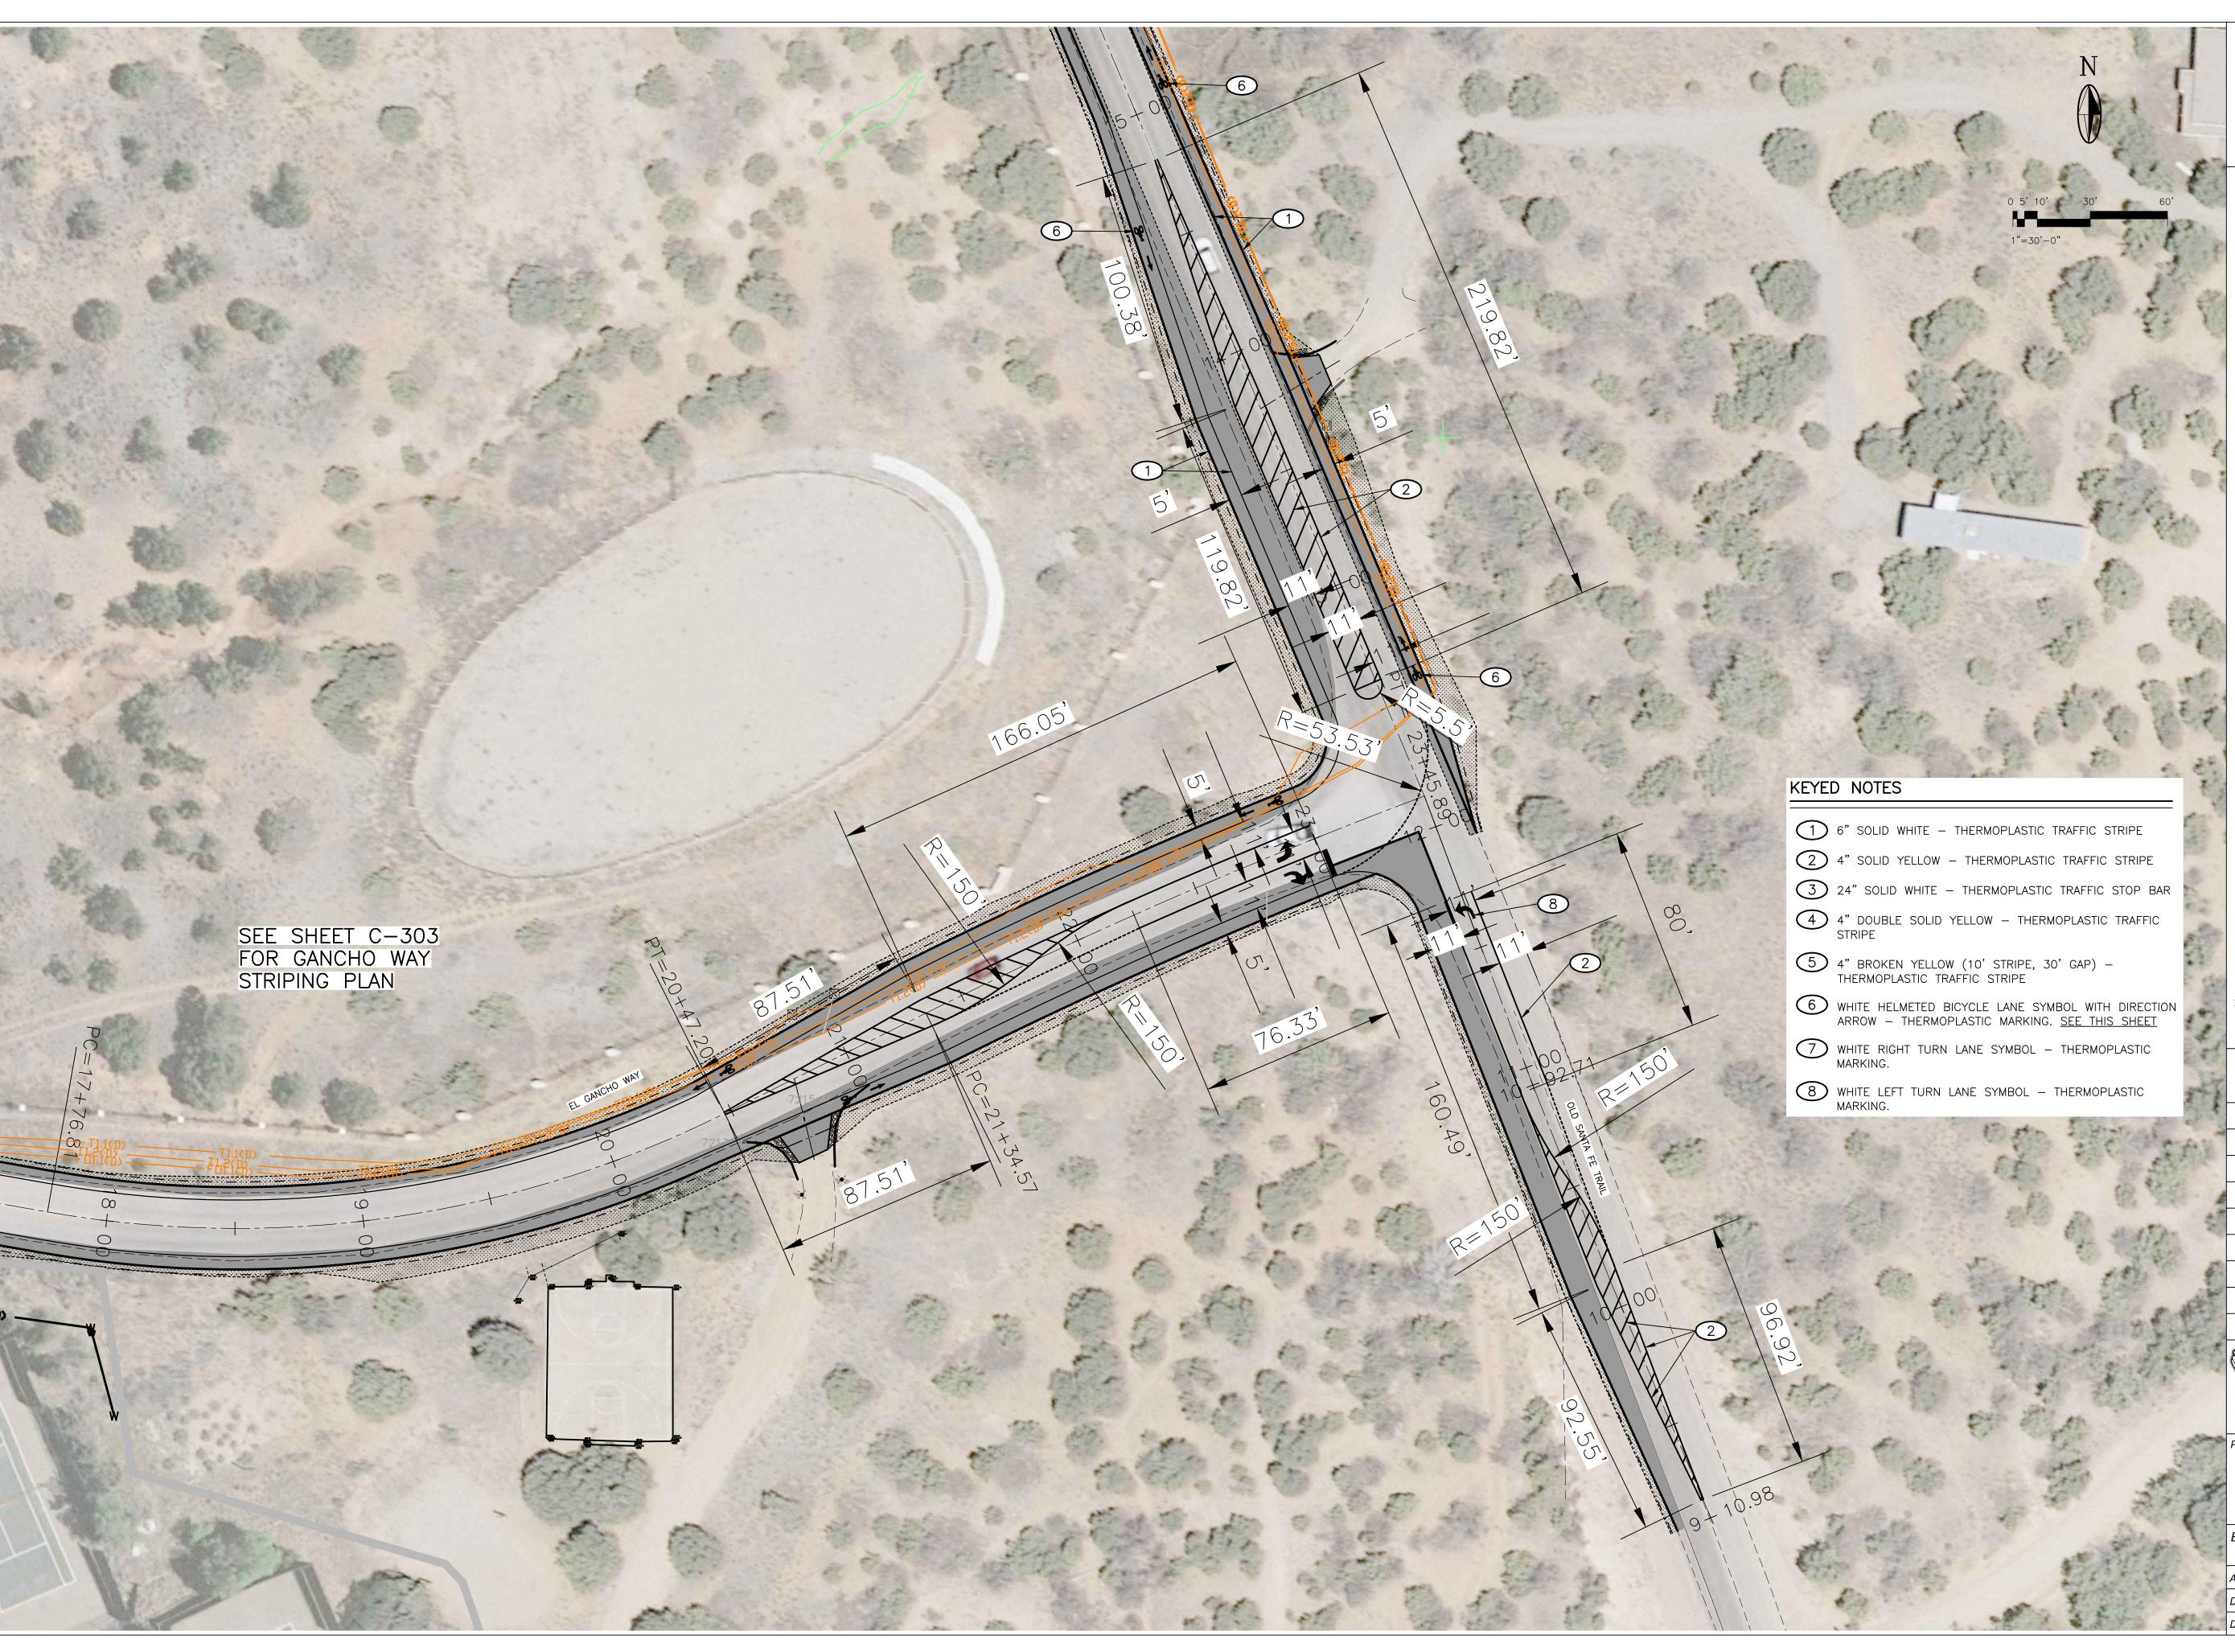

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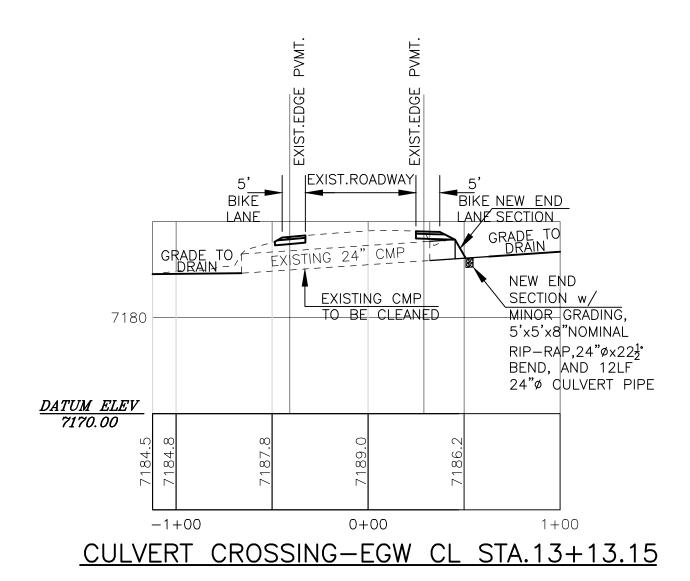
PUBLIC WORKS DEPARTMENT 424 NM 599 SANTA FE, NM 87507


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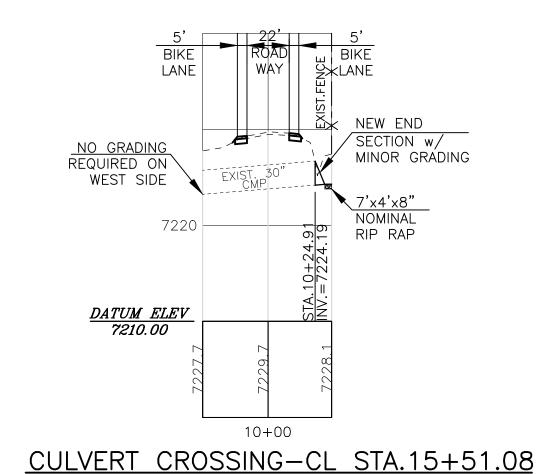
OLD SANTA FE TRAIL ROAD IMPROVEMENTS **WATERLINE TL2N**


EL GANCHO WAY-OLD SANTA FE TRAIL INTERSECTION DETAILS


APPROVED: -REVIEWED: -DATE: NOV., 2014 C-304 DRAWN BY: J.LOVATO






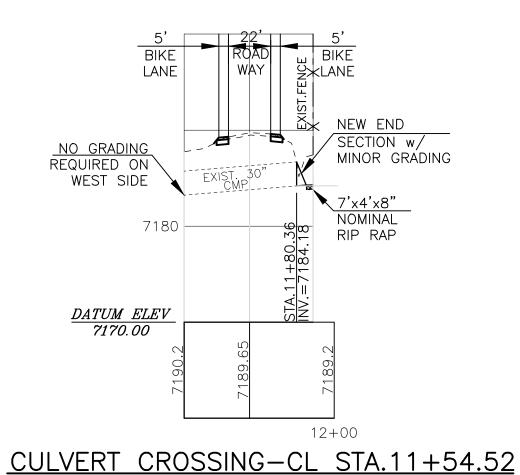


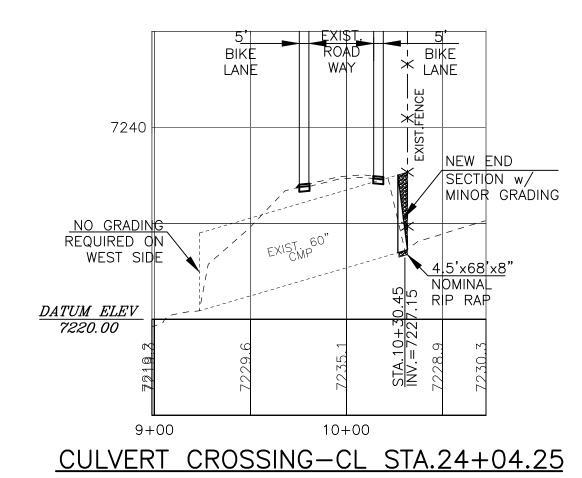


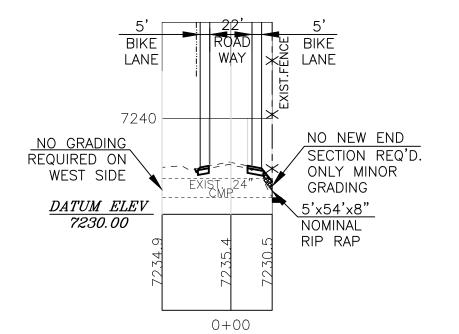



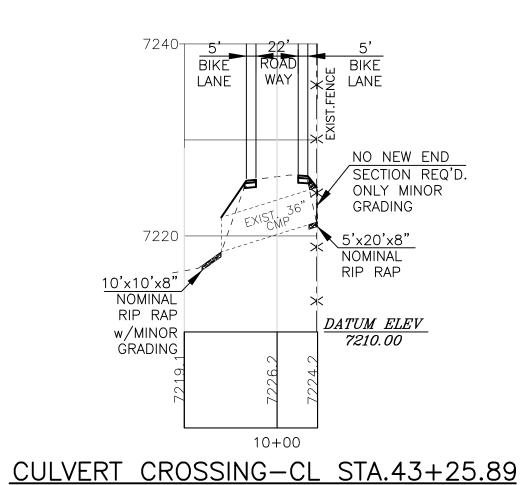

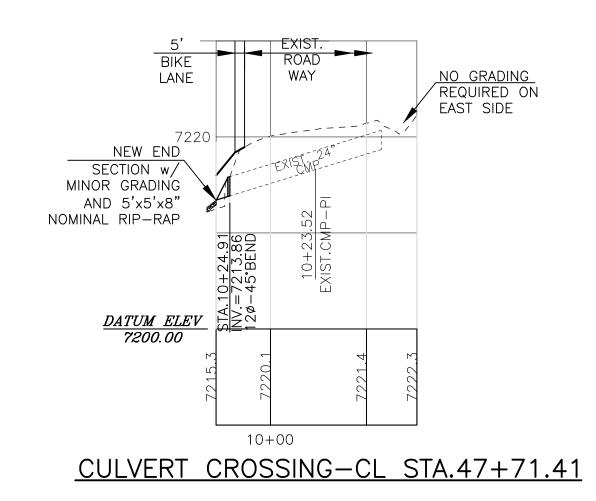

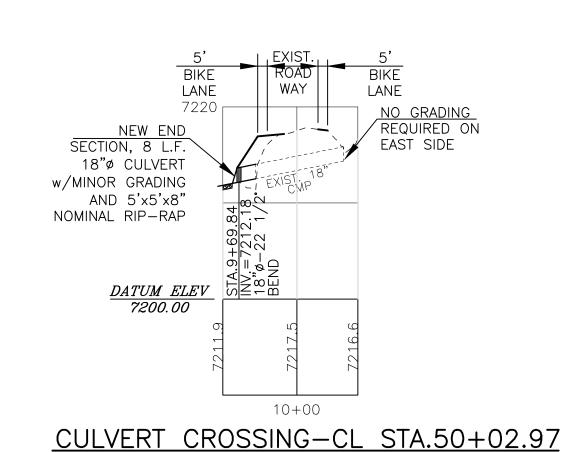



2701 Miles Road SE Albuquerque, New Mexico 87106 505 242 5700 office 505 242 0673 fax

MolzenCorbin.com

NOTICE OF EXTENDED PAYMENT PROVISION: THIS CONTRACT ALLOWS THE OWNER TO MAKE PAYMENT WITHIN 45 DAYS AFTER SUBMISSION OF AN UNDISPUTED REQUEST FOR PAYMENT

	REVISION				
SYMBOL:	DATE:	BY:			



PROJECT NAME:

OLD SANTA FE TRAIL

ROAD IMPROVEMENTS

AND


CULVERT CROSSING SECTIONS

APPROVED: -

WATERLINE TL2N

DATE: NOV., 2014 SHEET:
DRAWN BY: J.LOVATO C-401

REVIEWED: -

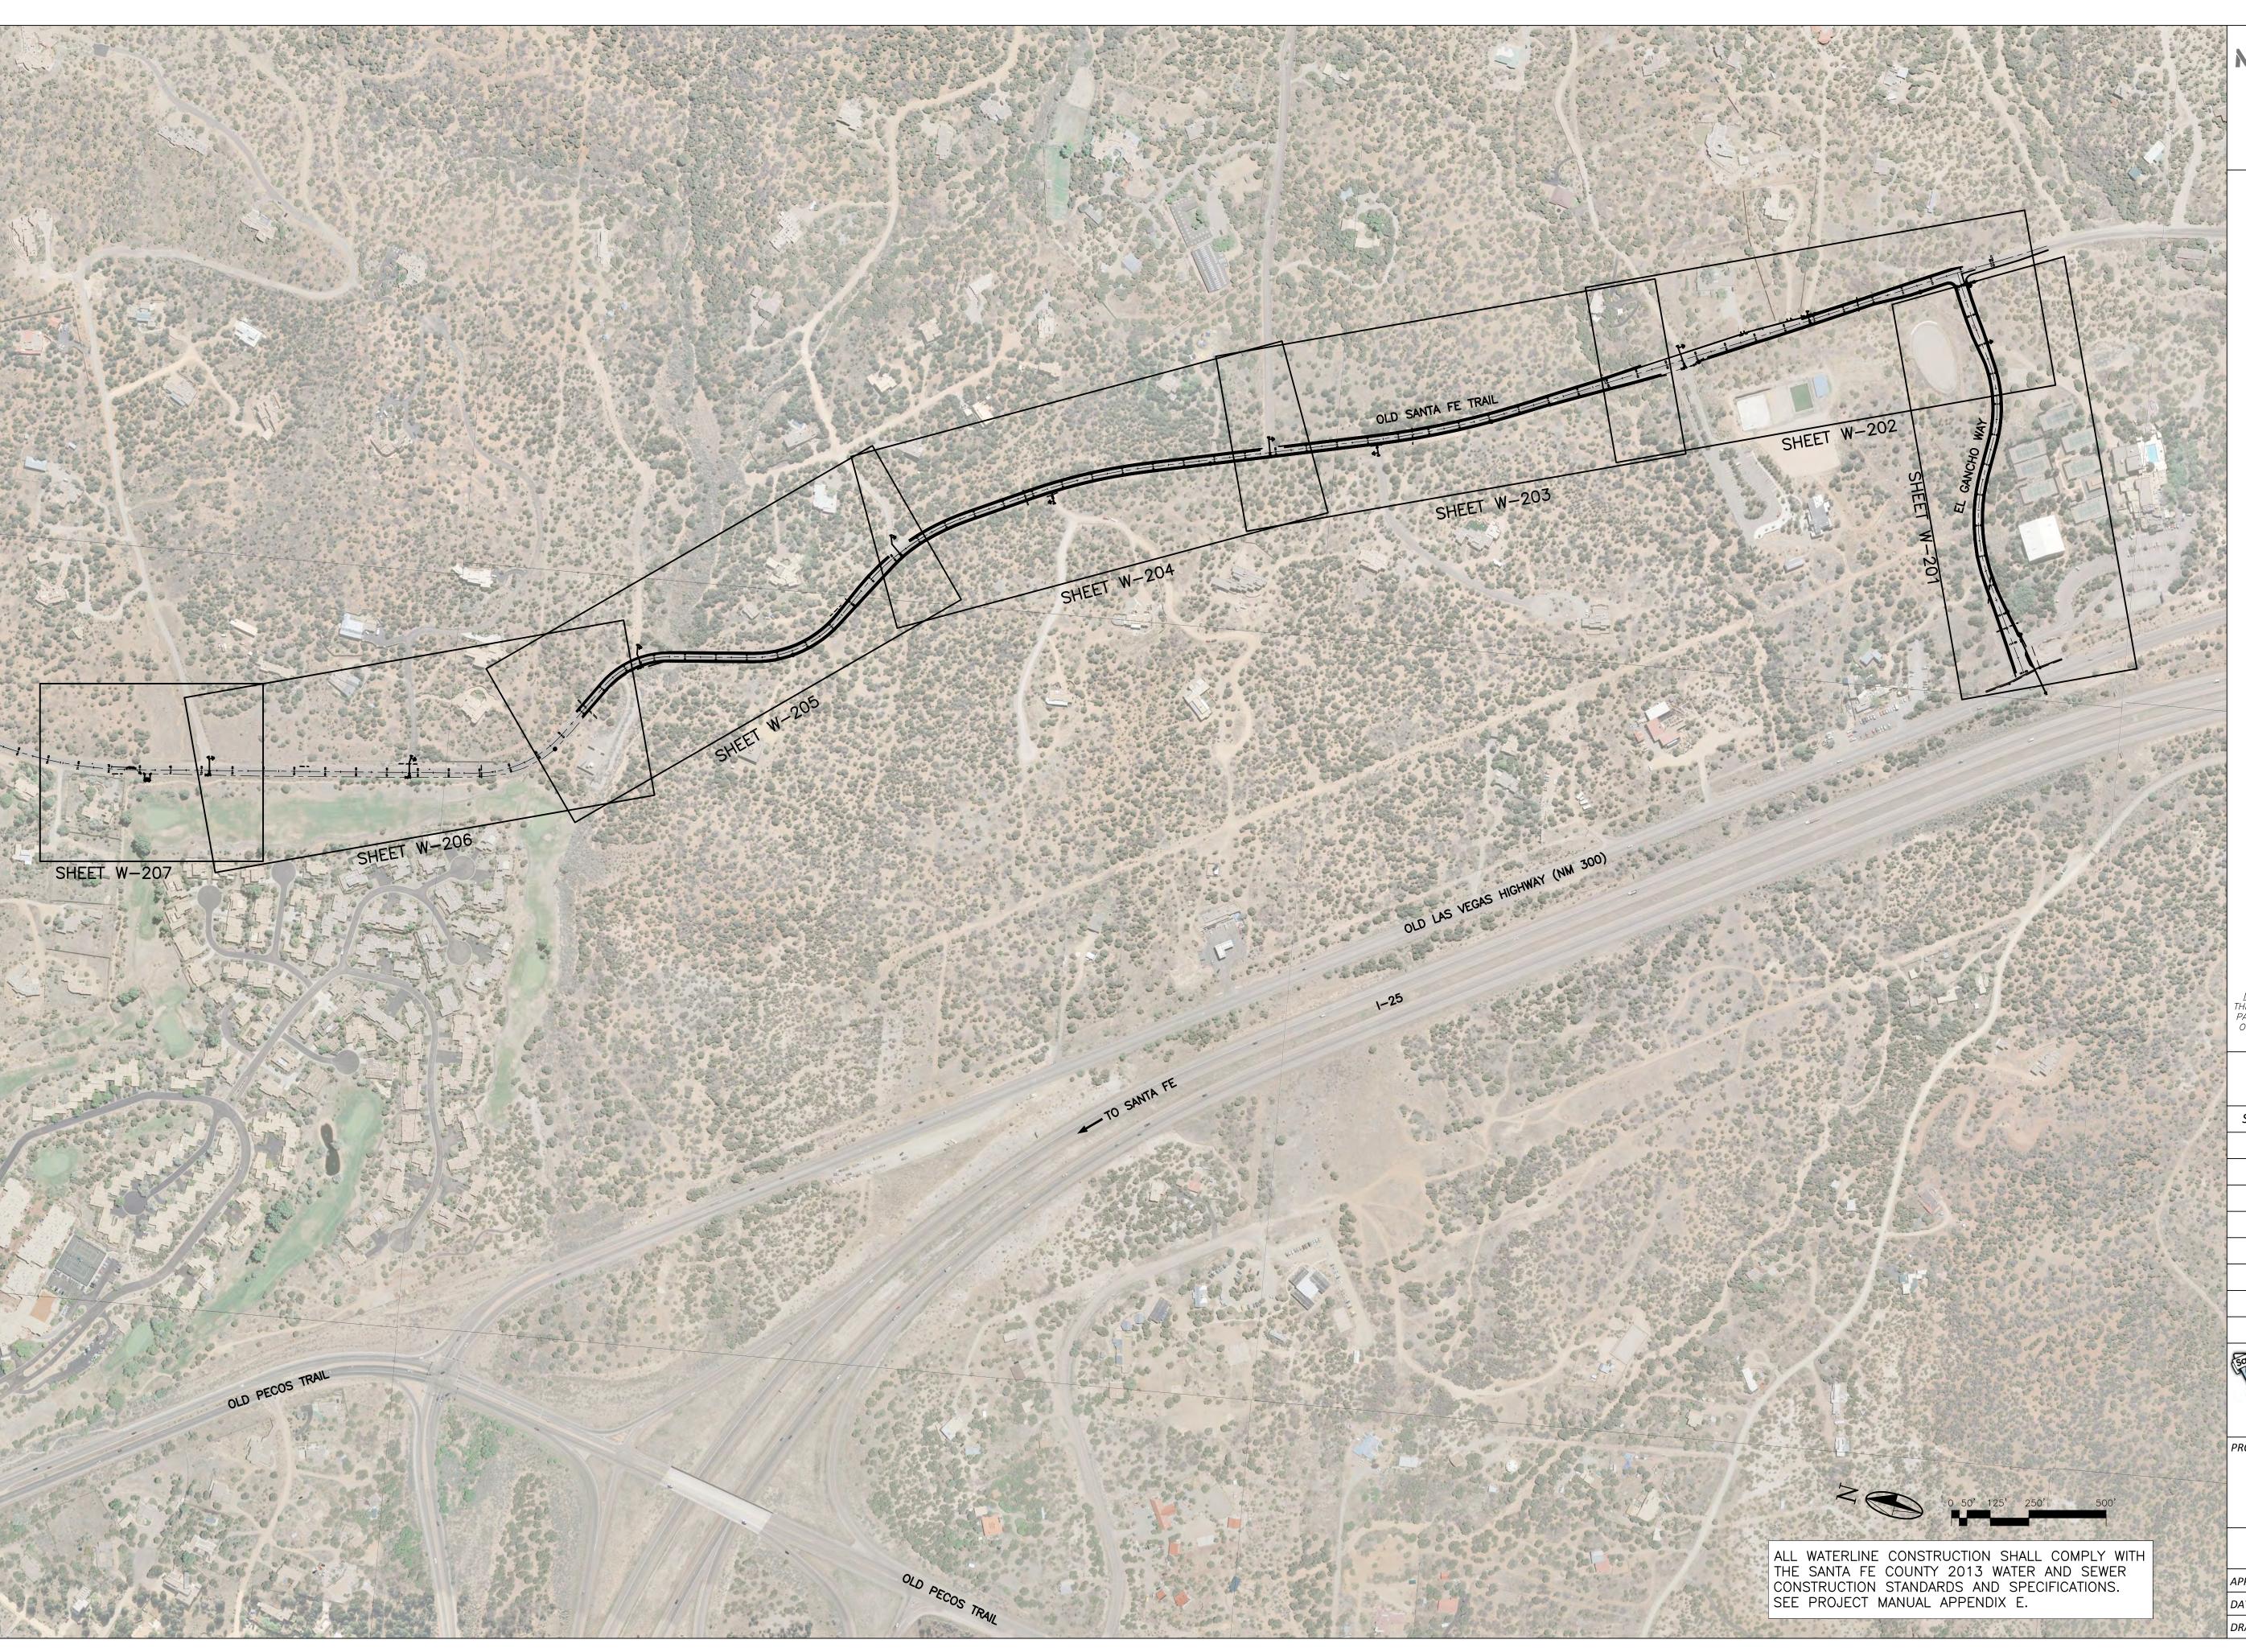

2701 Miles Road SE Albuquerque, New Mexico 87106 505 242 5700 office 505 242 0673 fax MolzenCorbin.com



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REVISION

SYMBOL:	DATE:	BY:



PROJECT NAME:

OLD SANTA FE TRAIL ROAD IMPROVEMENTS AND


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WATERLINE DRAWINGS


WATERLINE TL2N


APPROVED: R. GEORGE REVIEWED: SM


DATE: NOV., 2014 SHEET:


DRAWN BY: J.MARTINEZ W-101

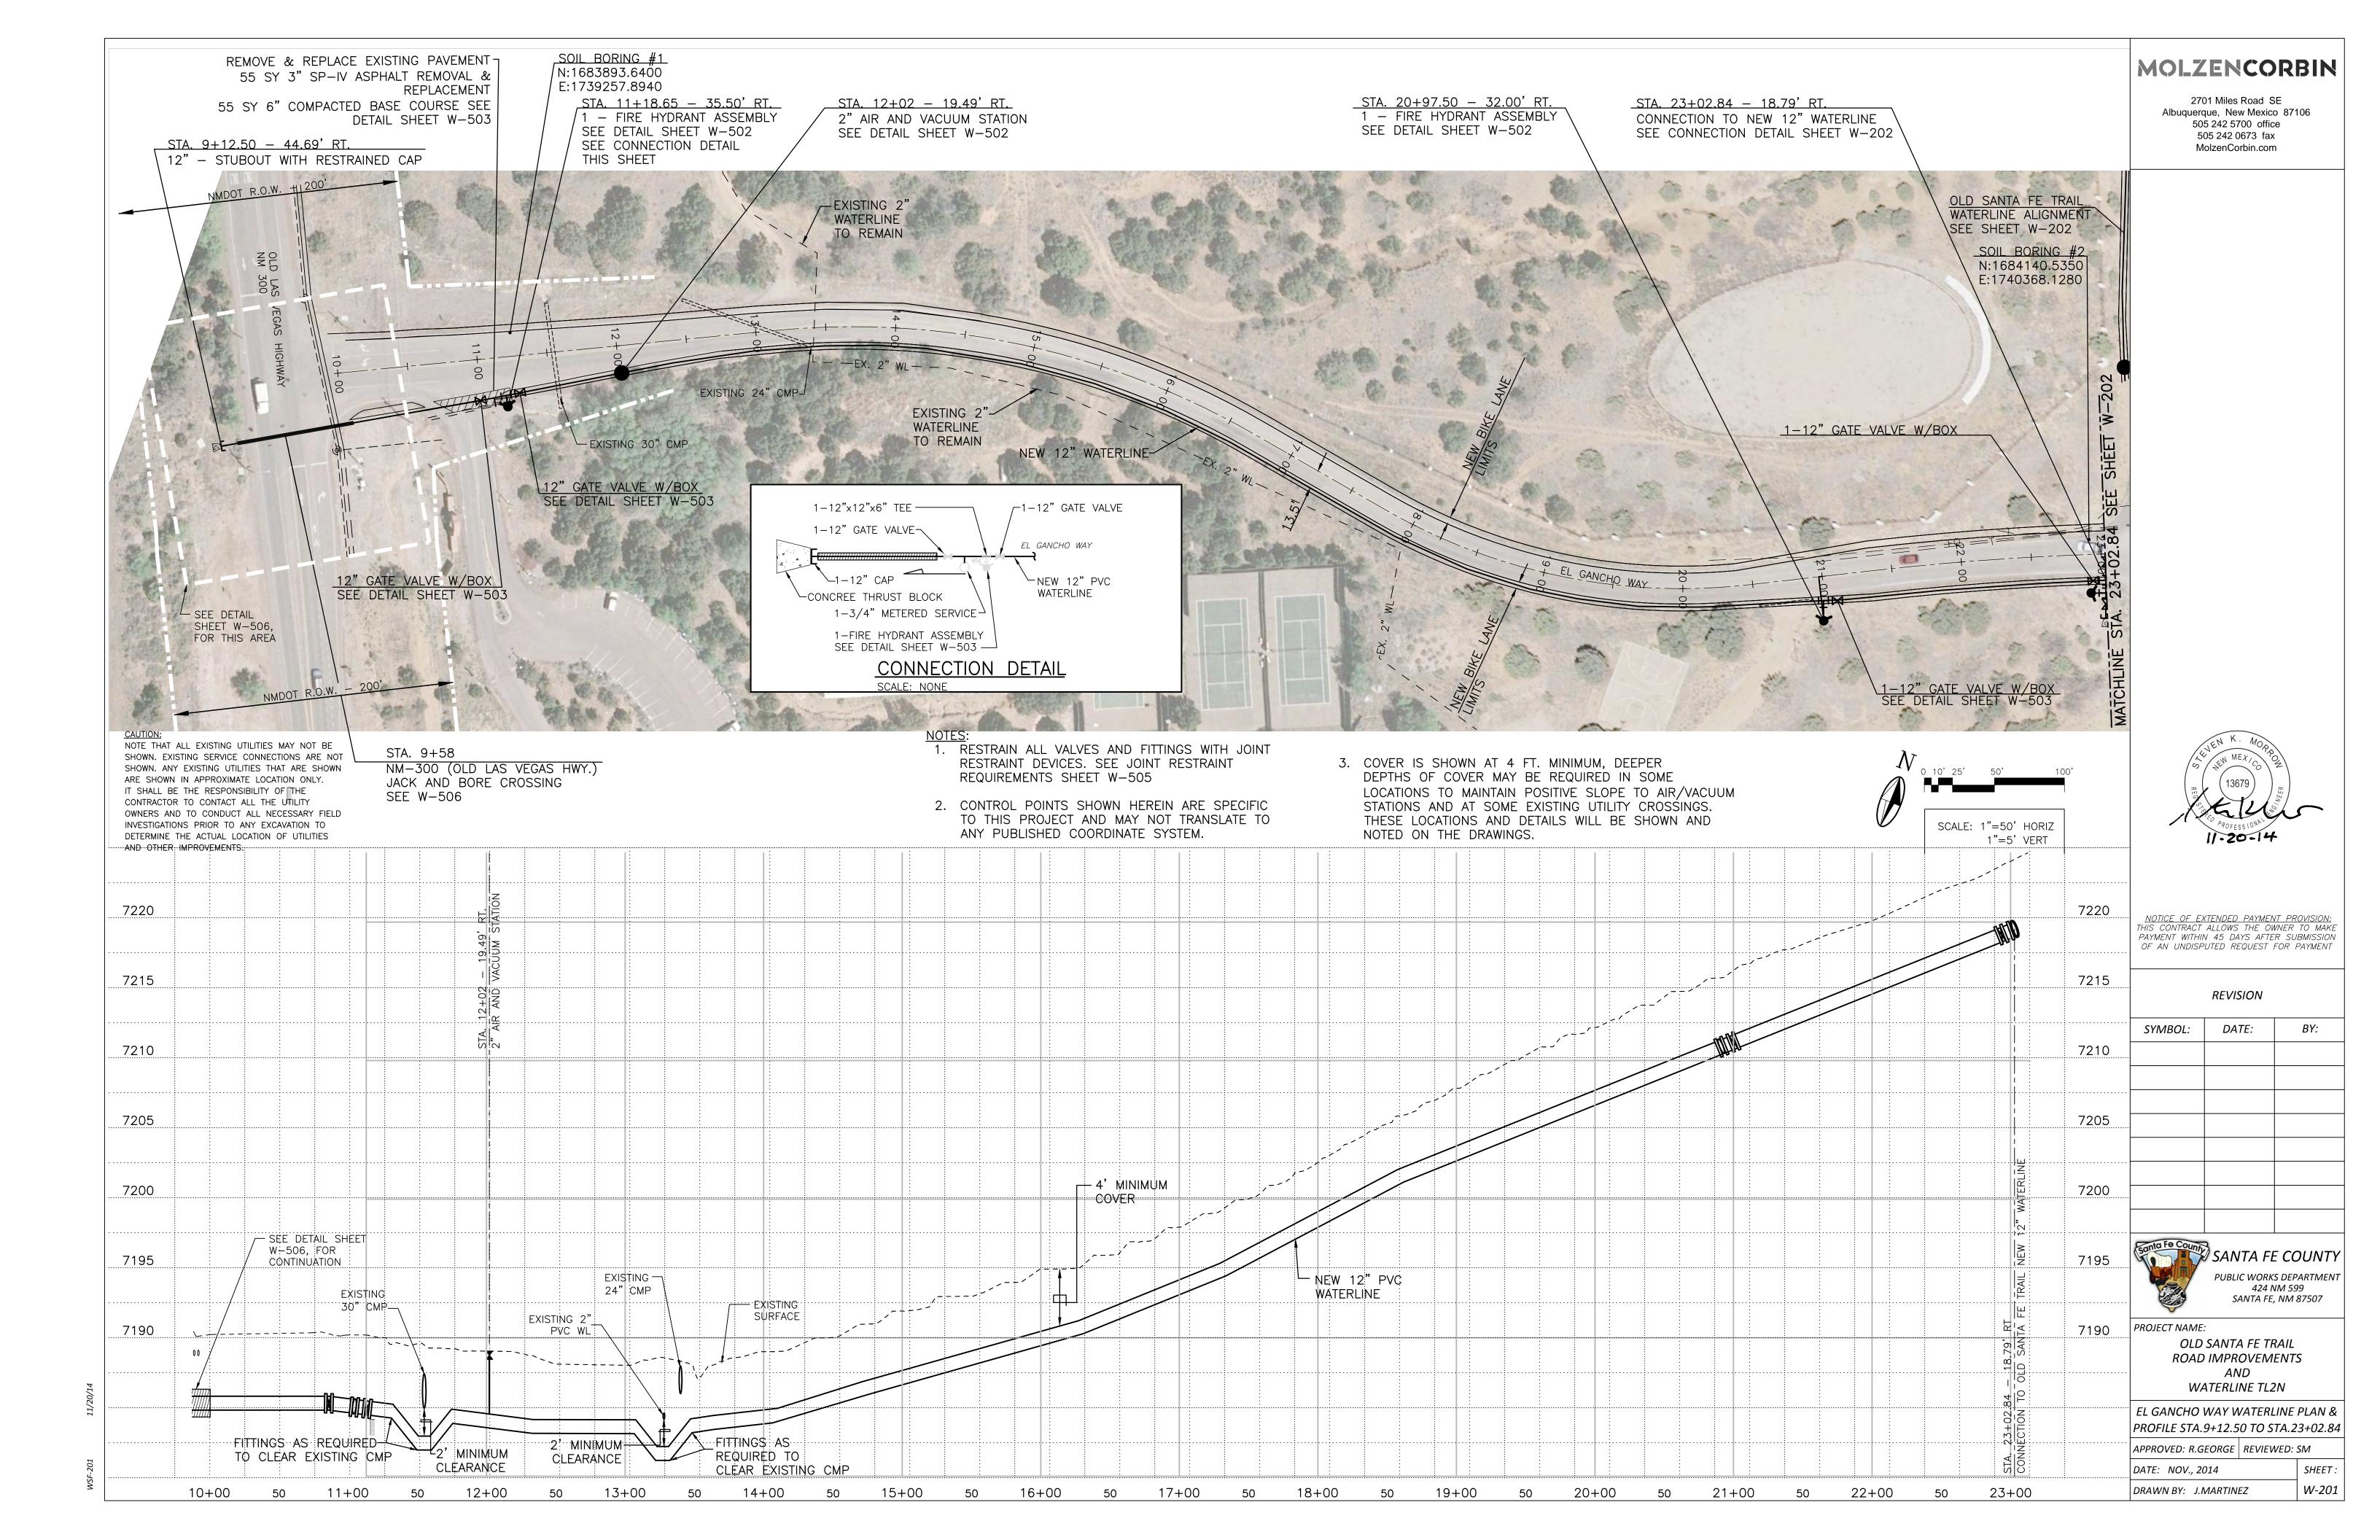


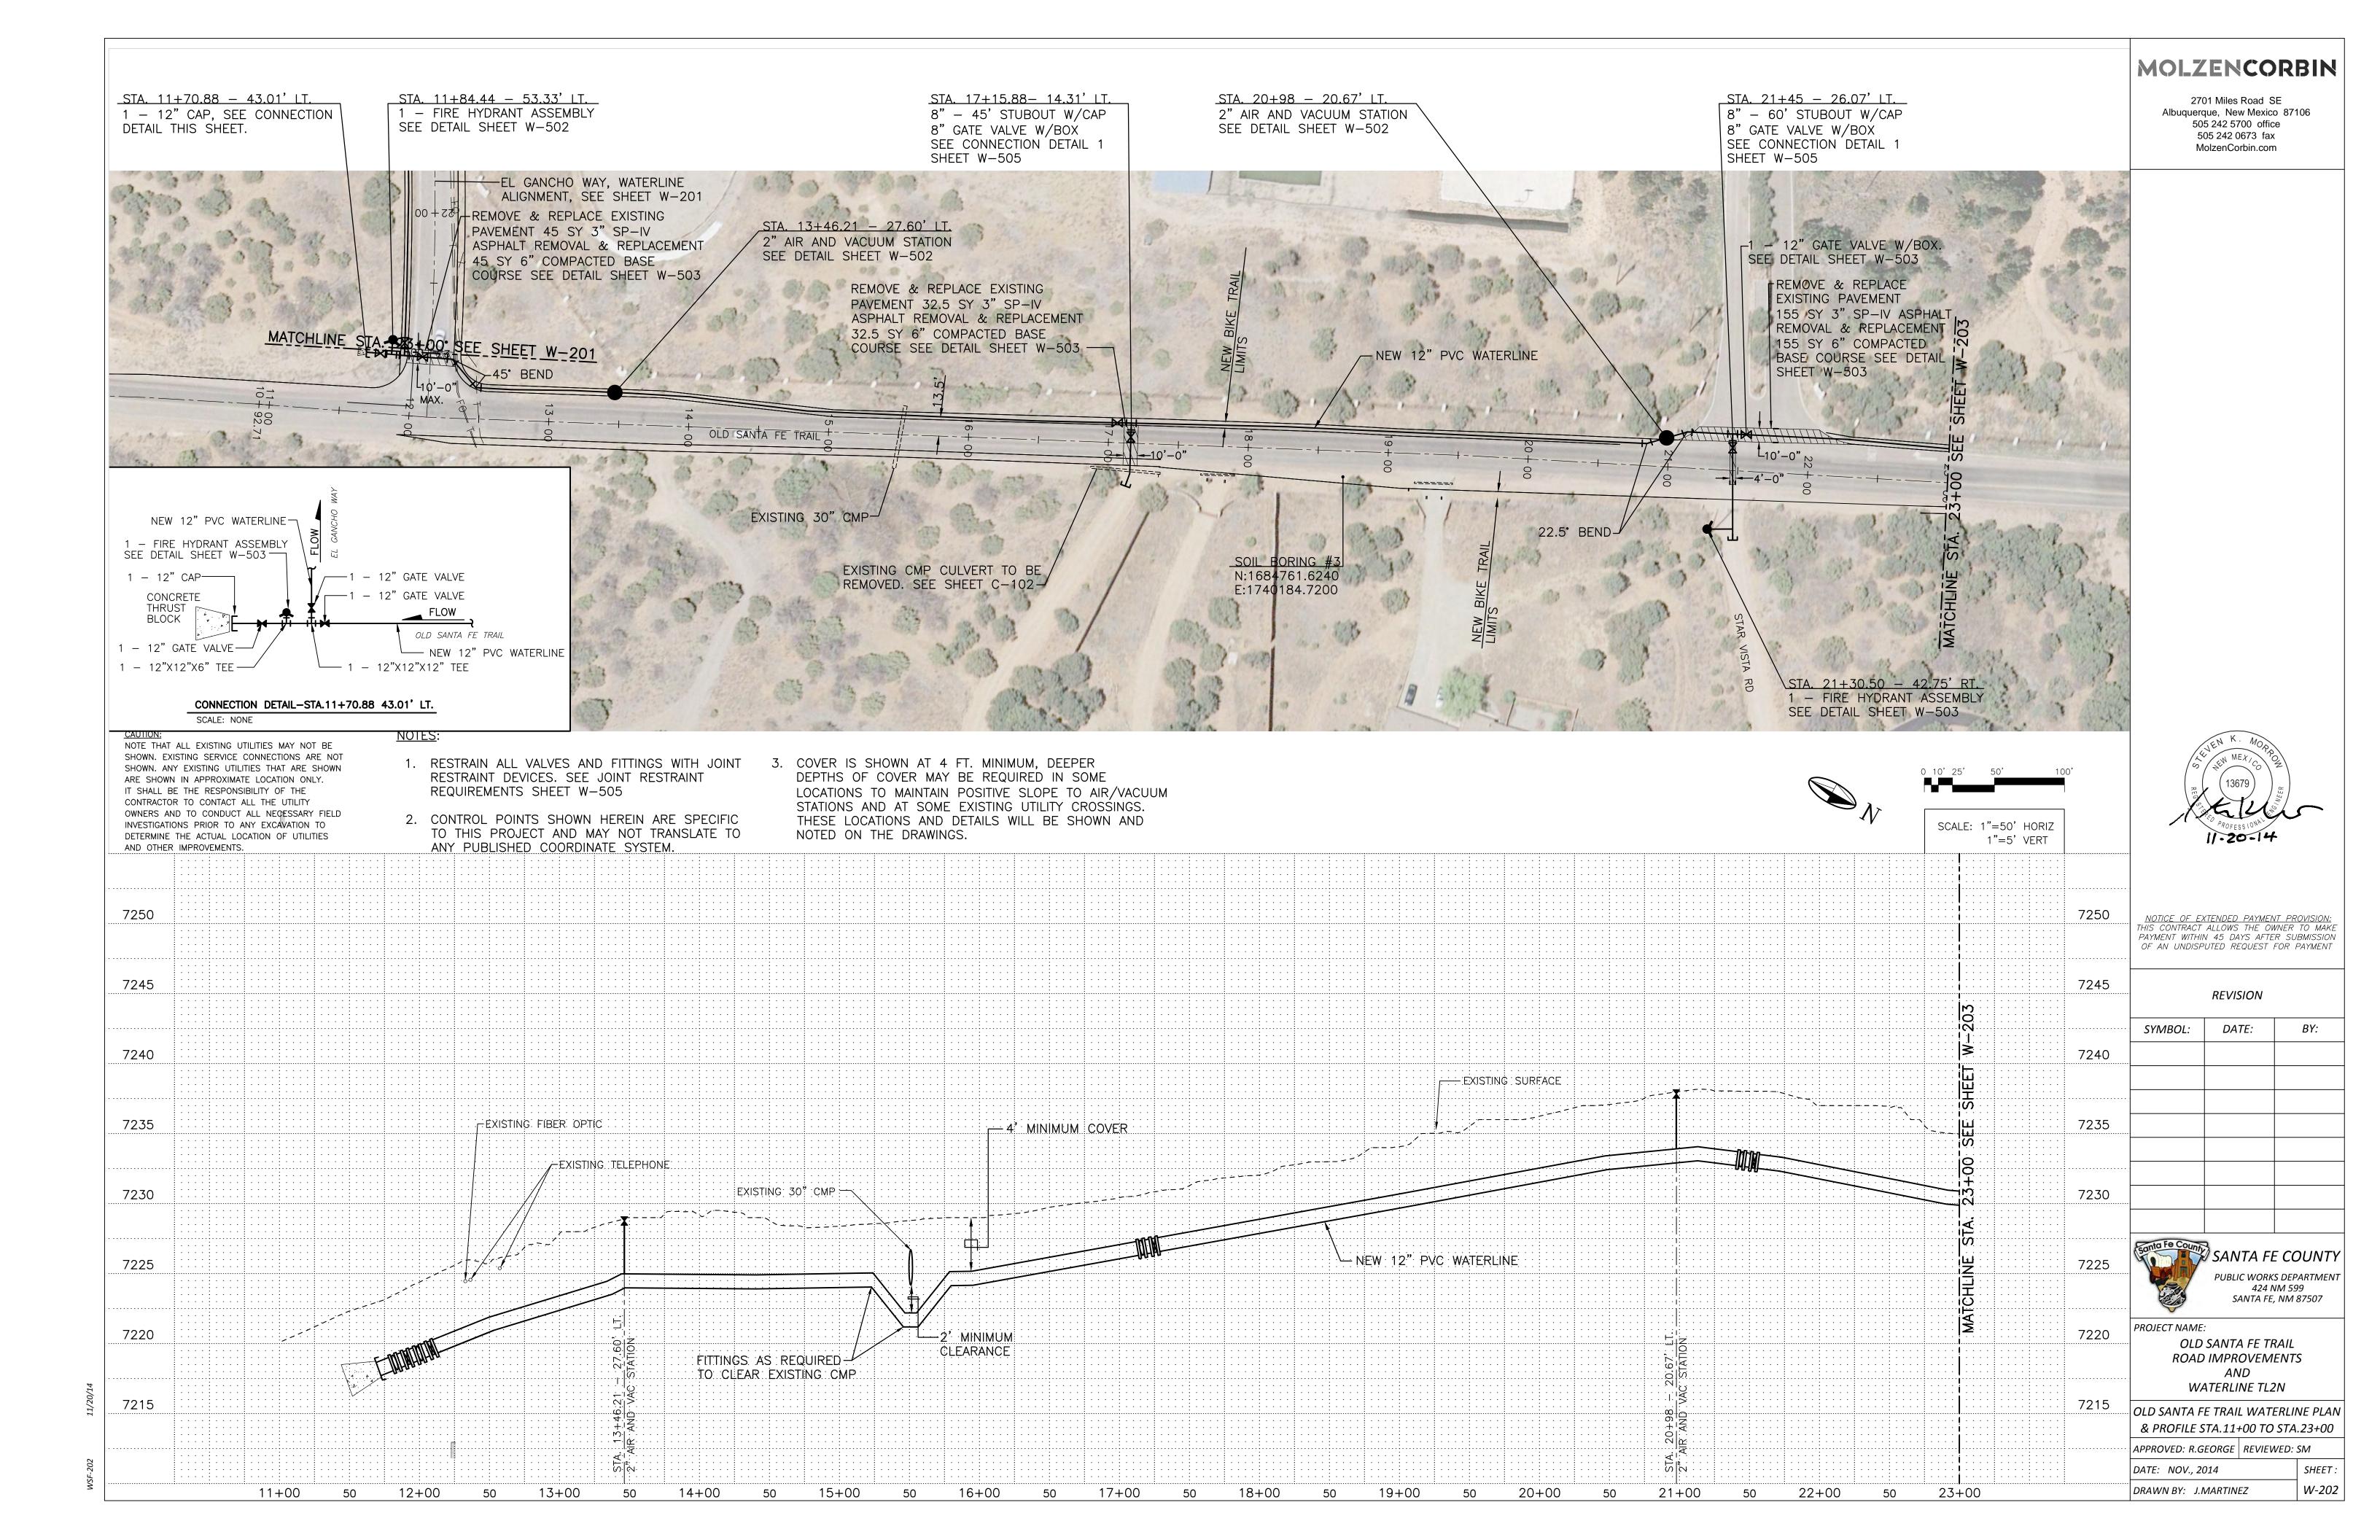


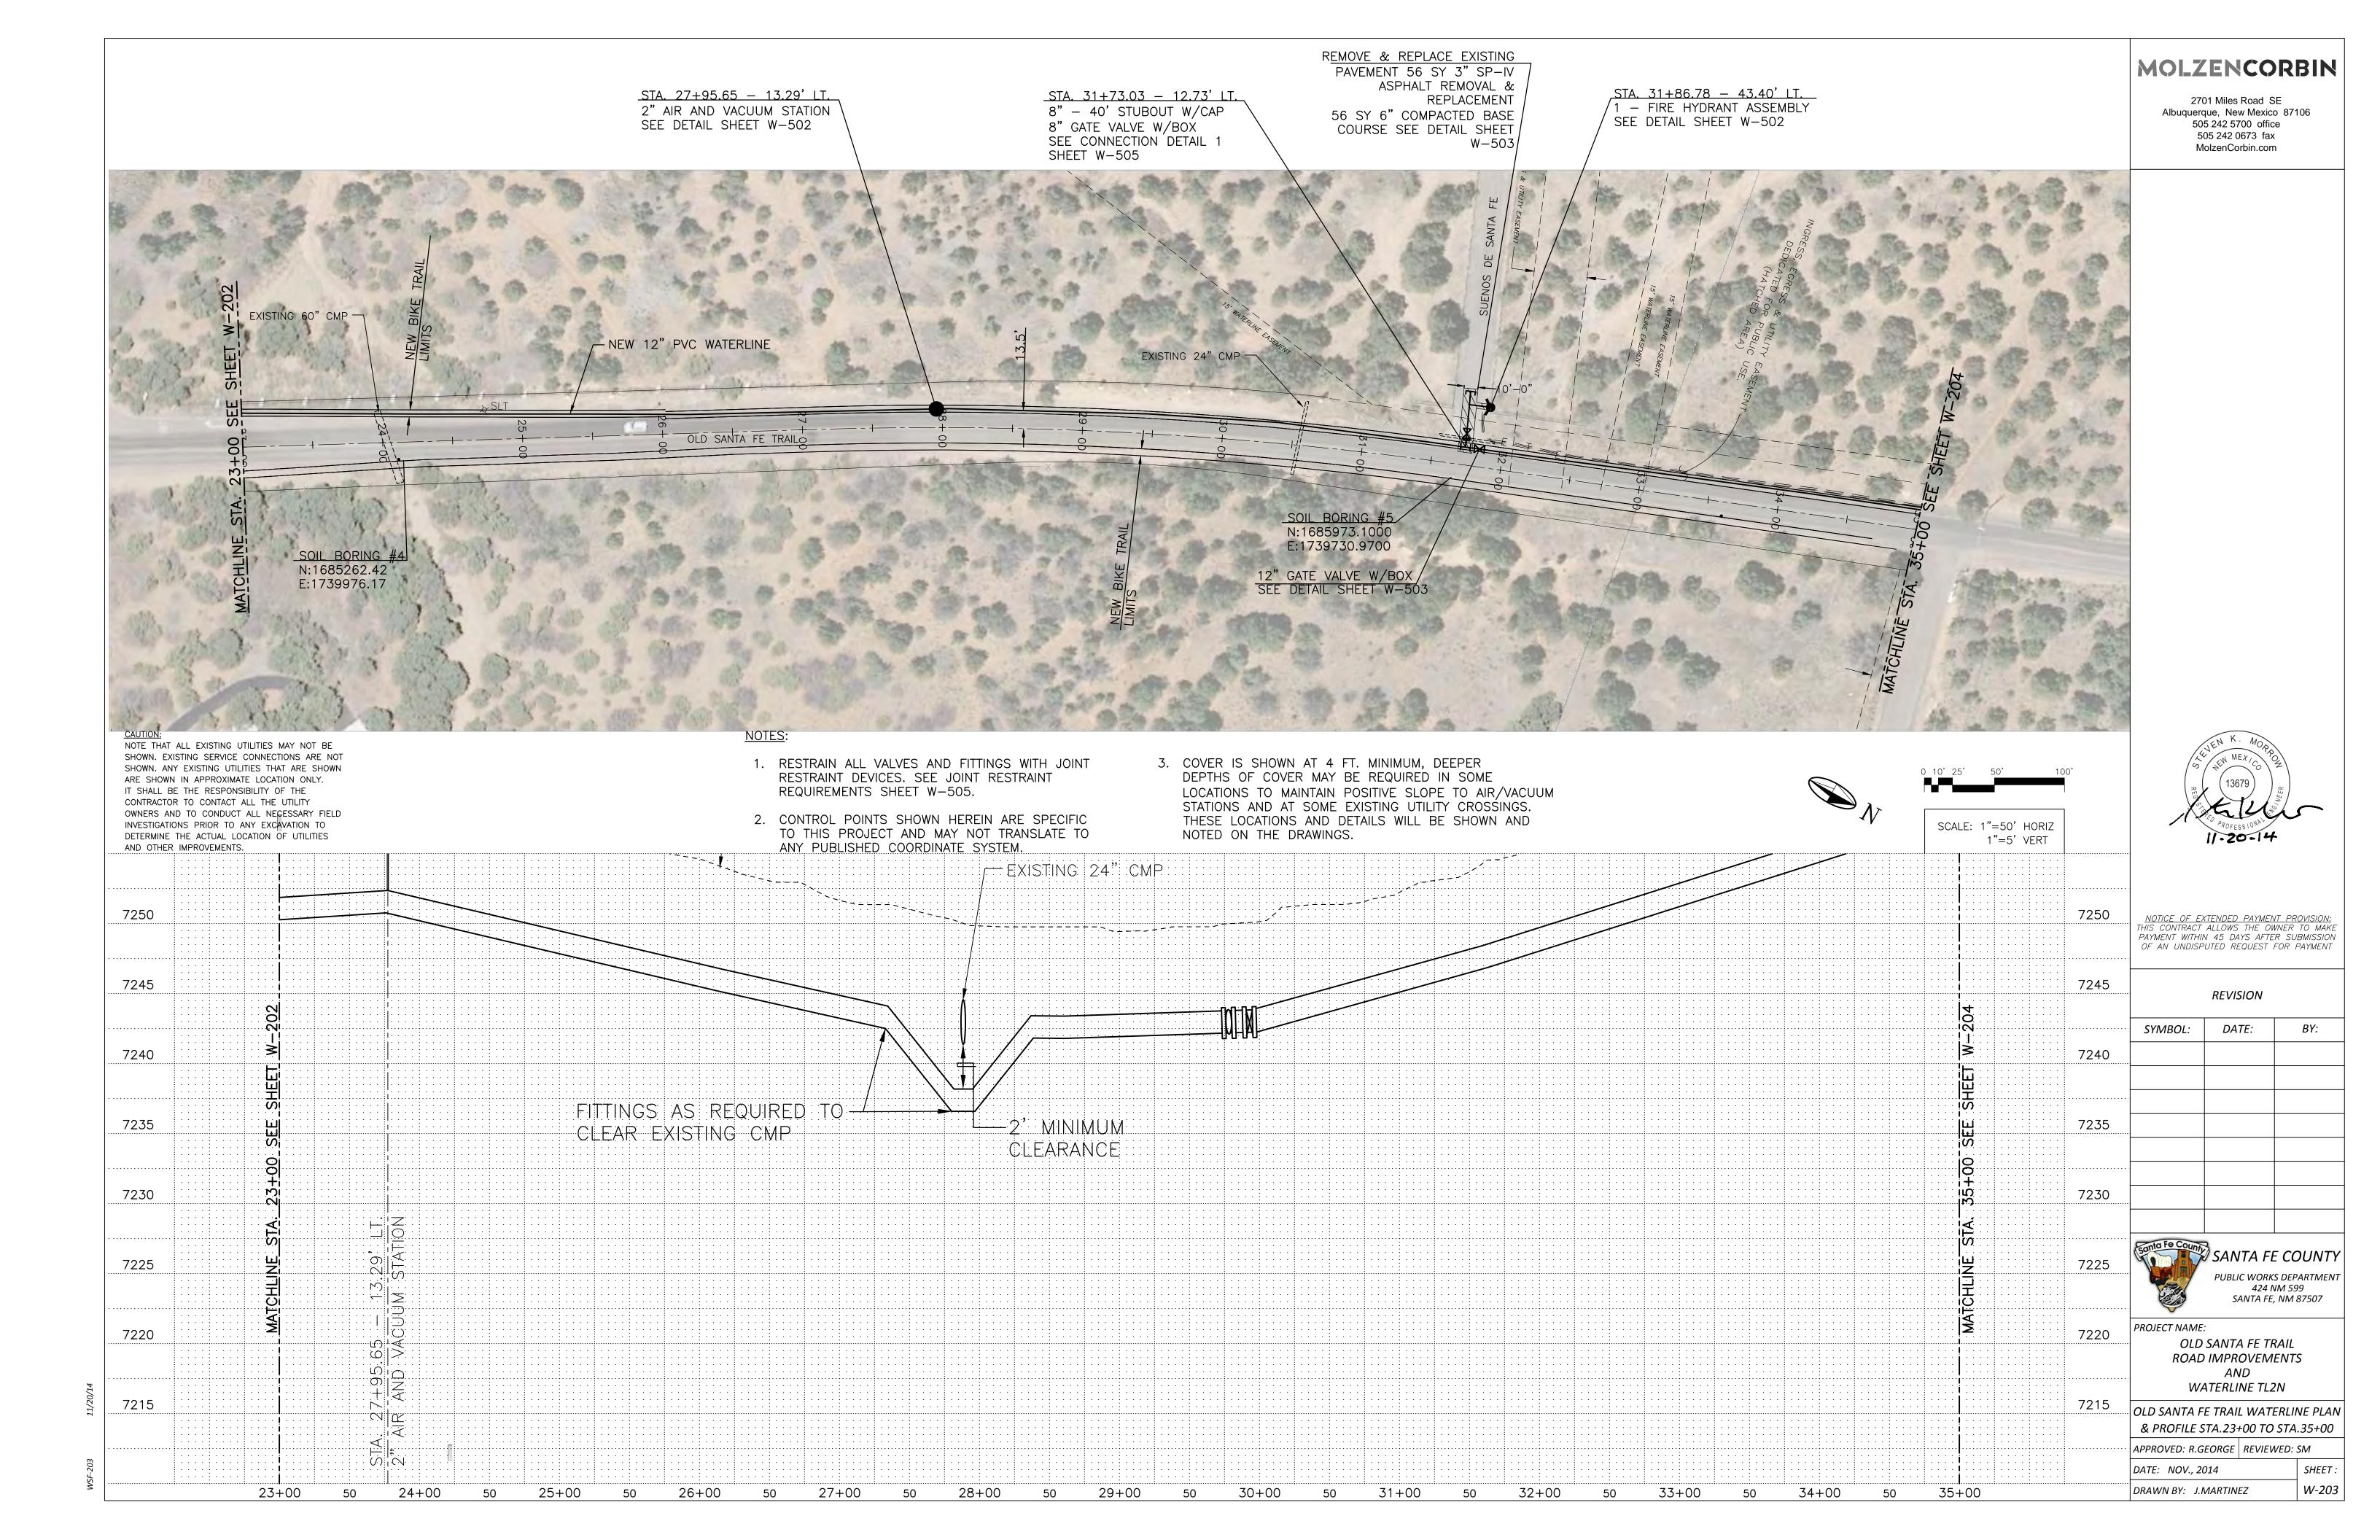


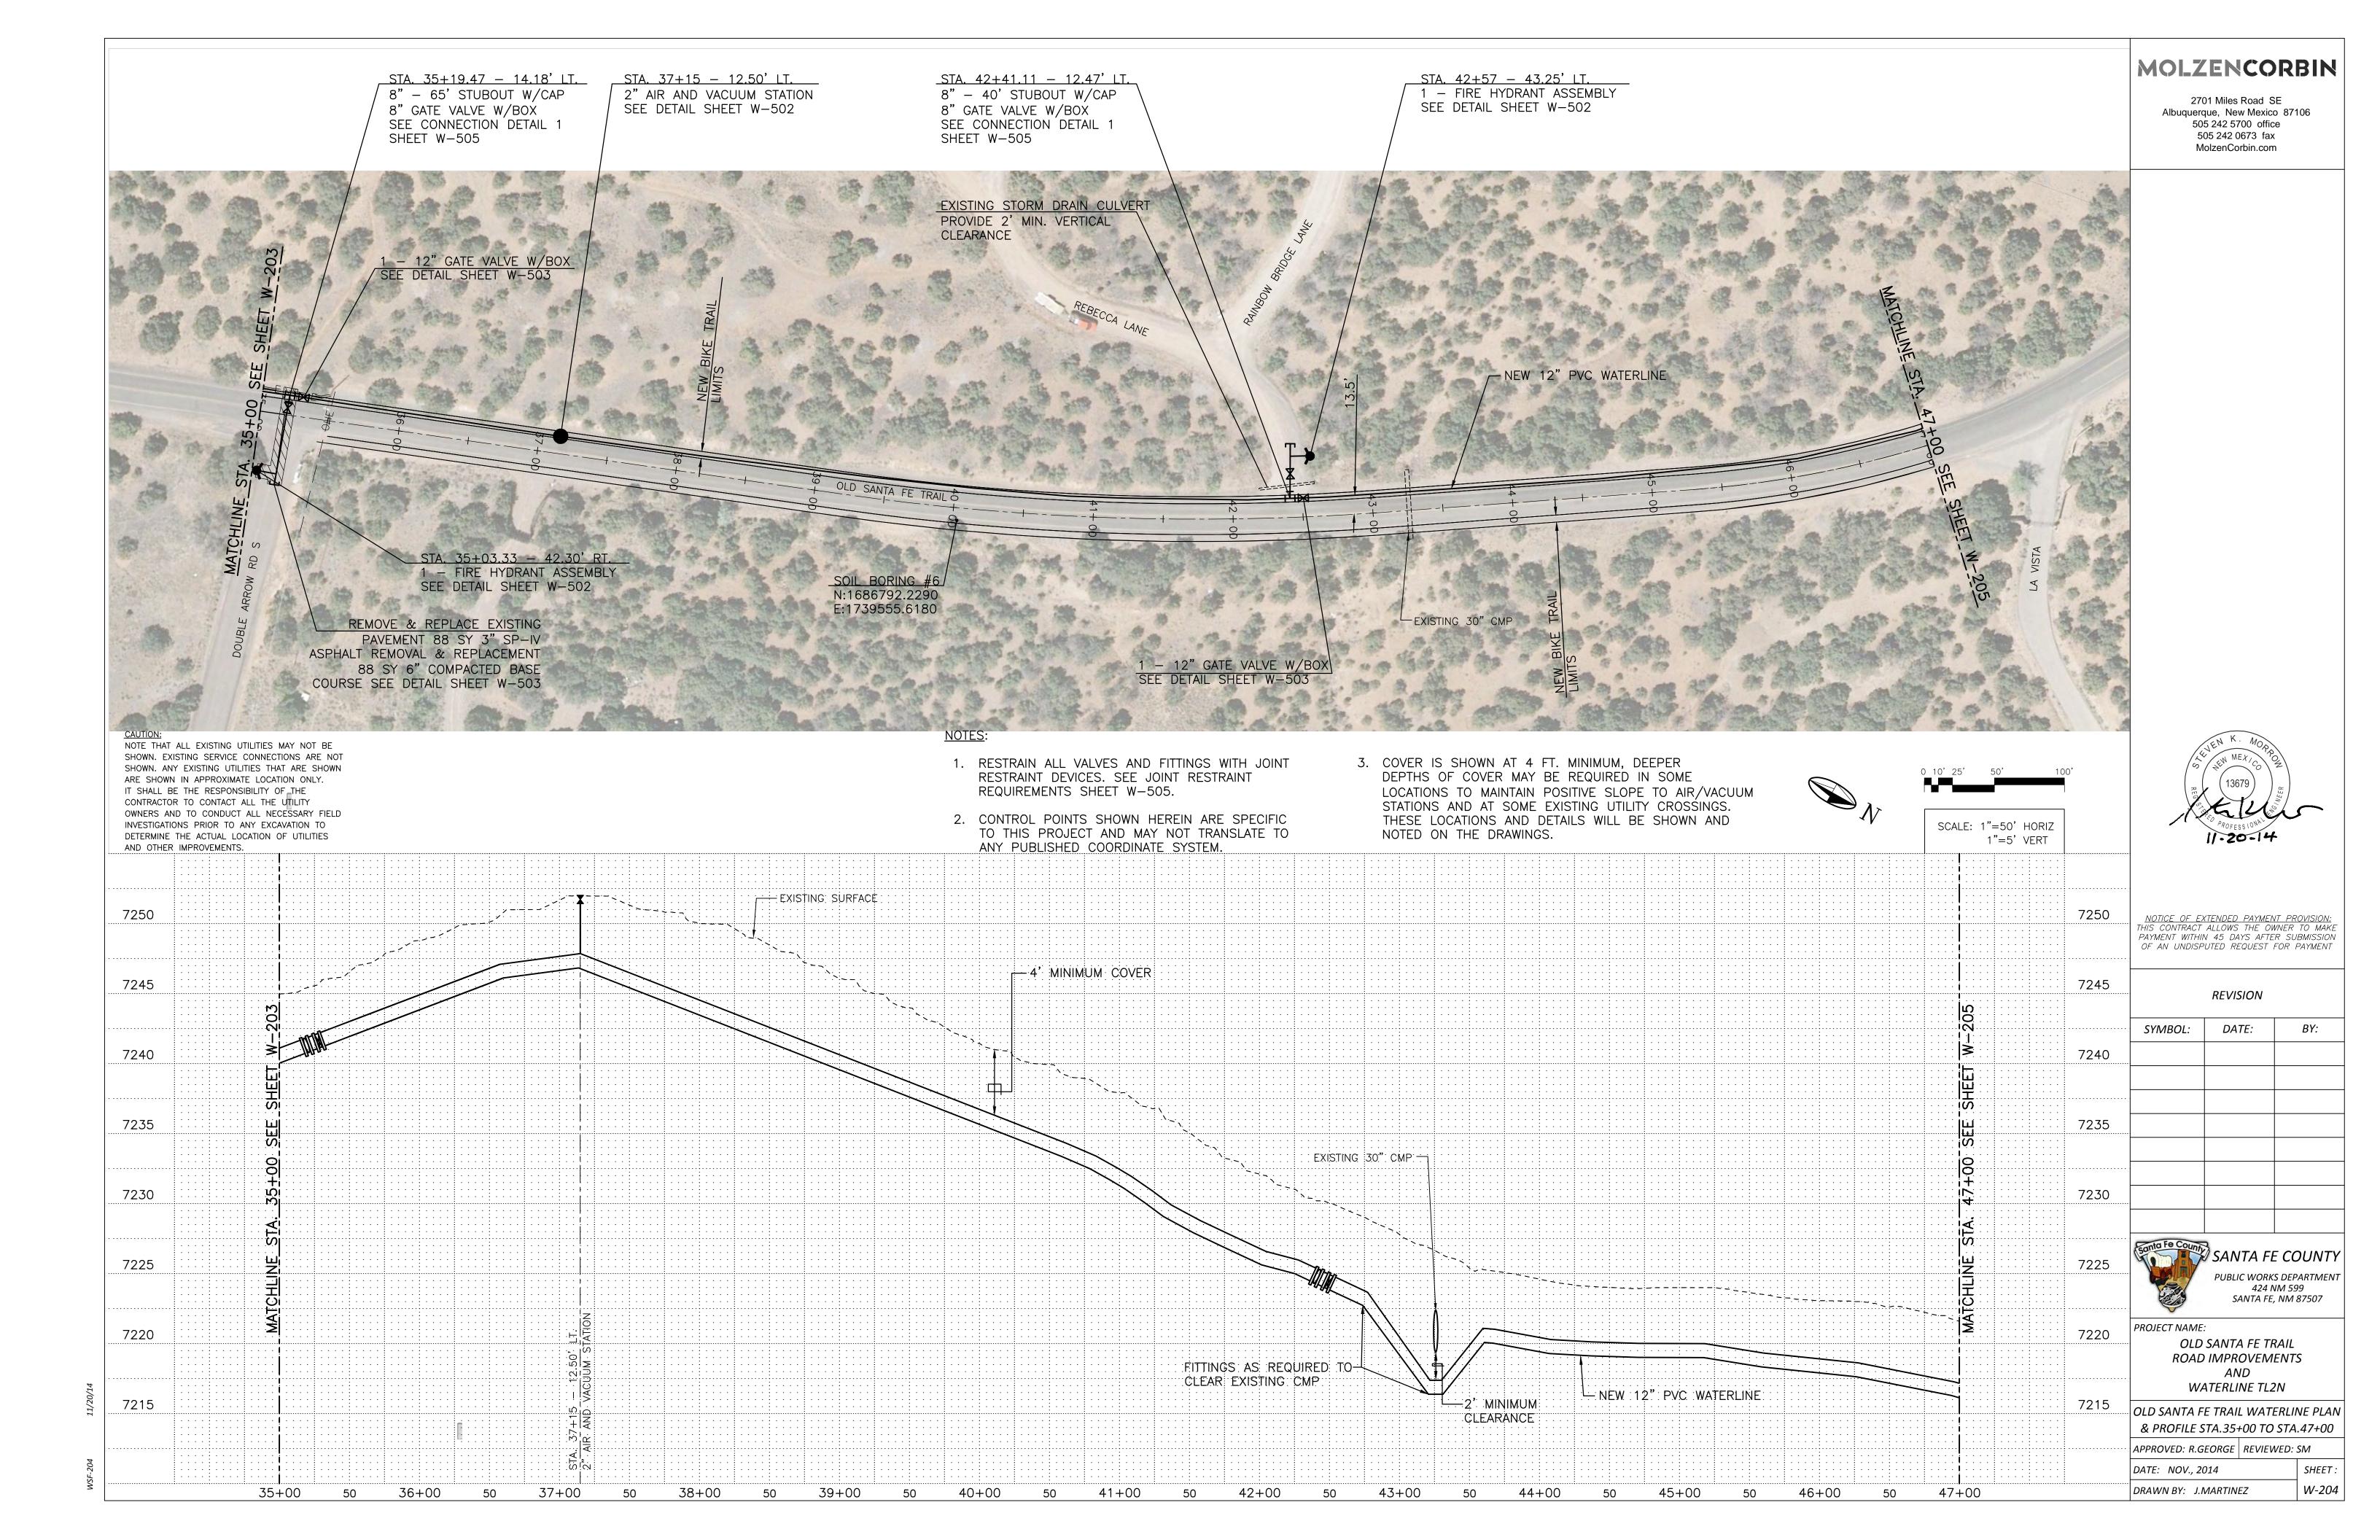


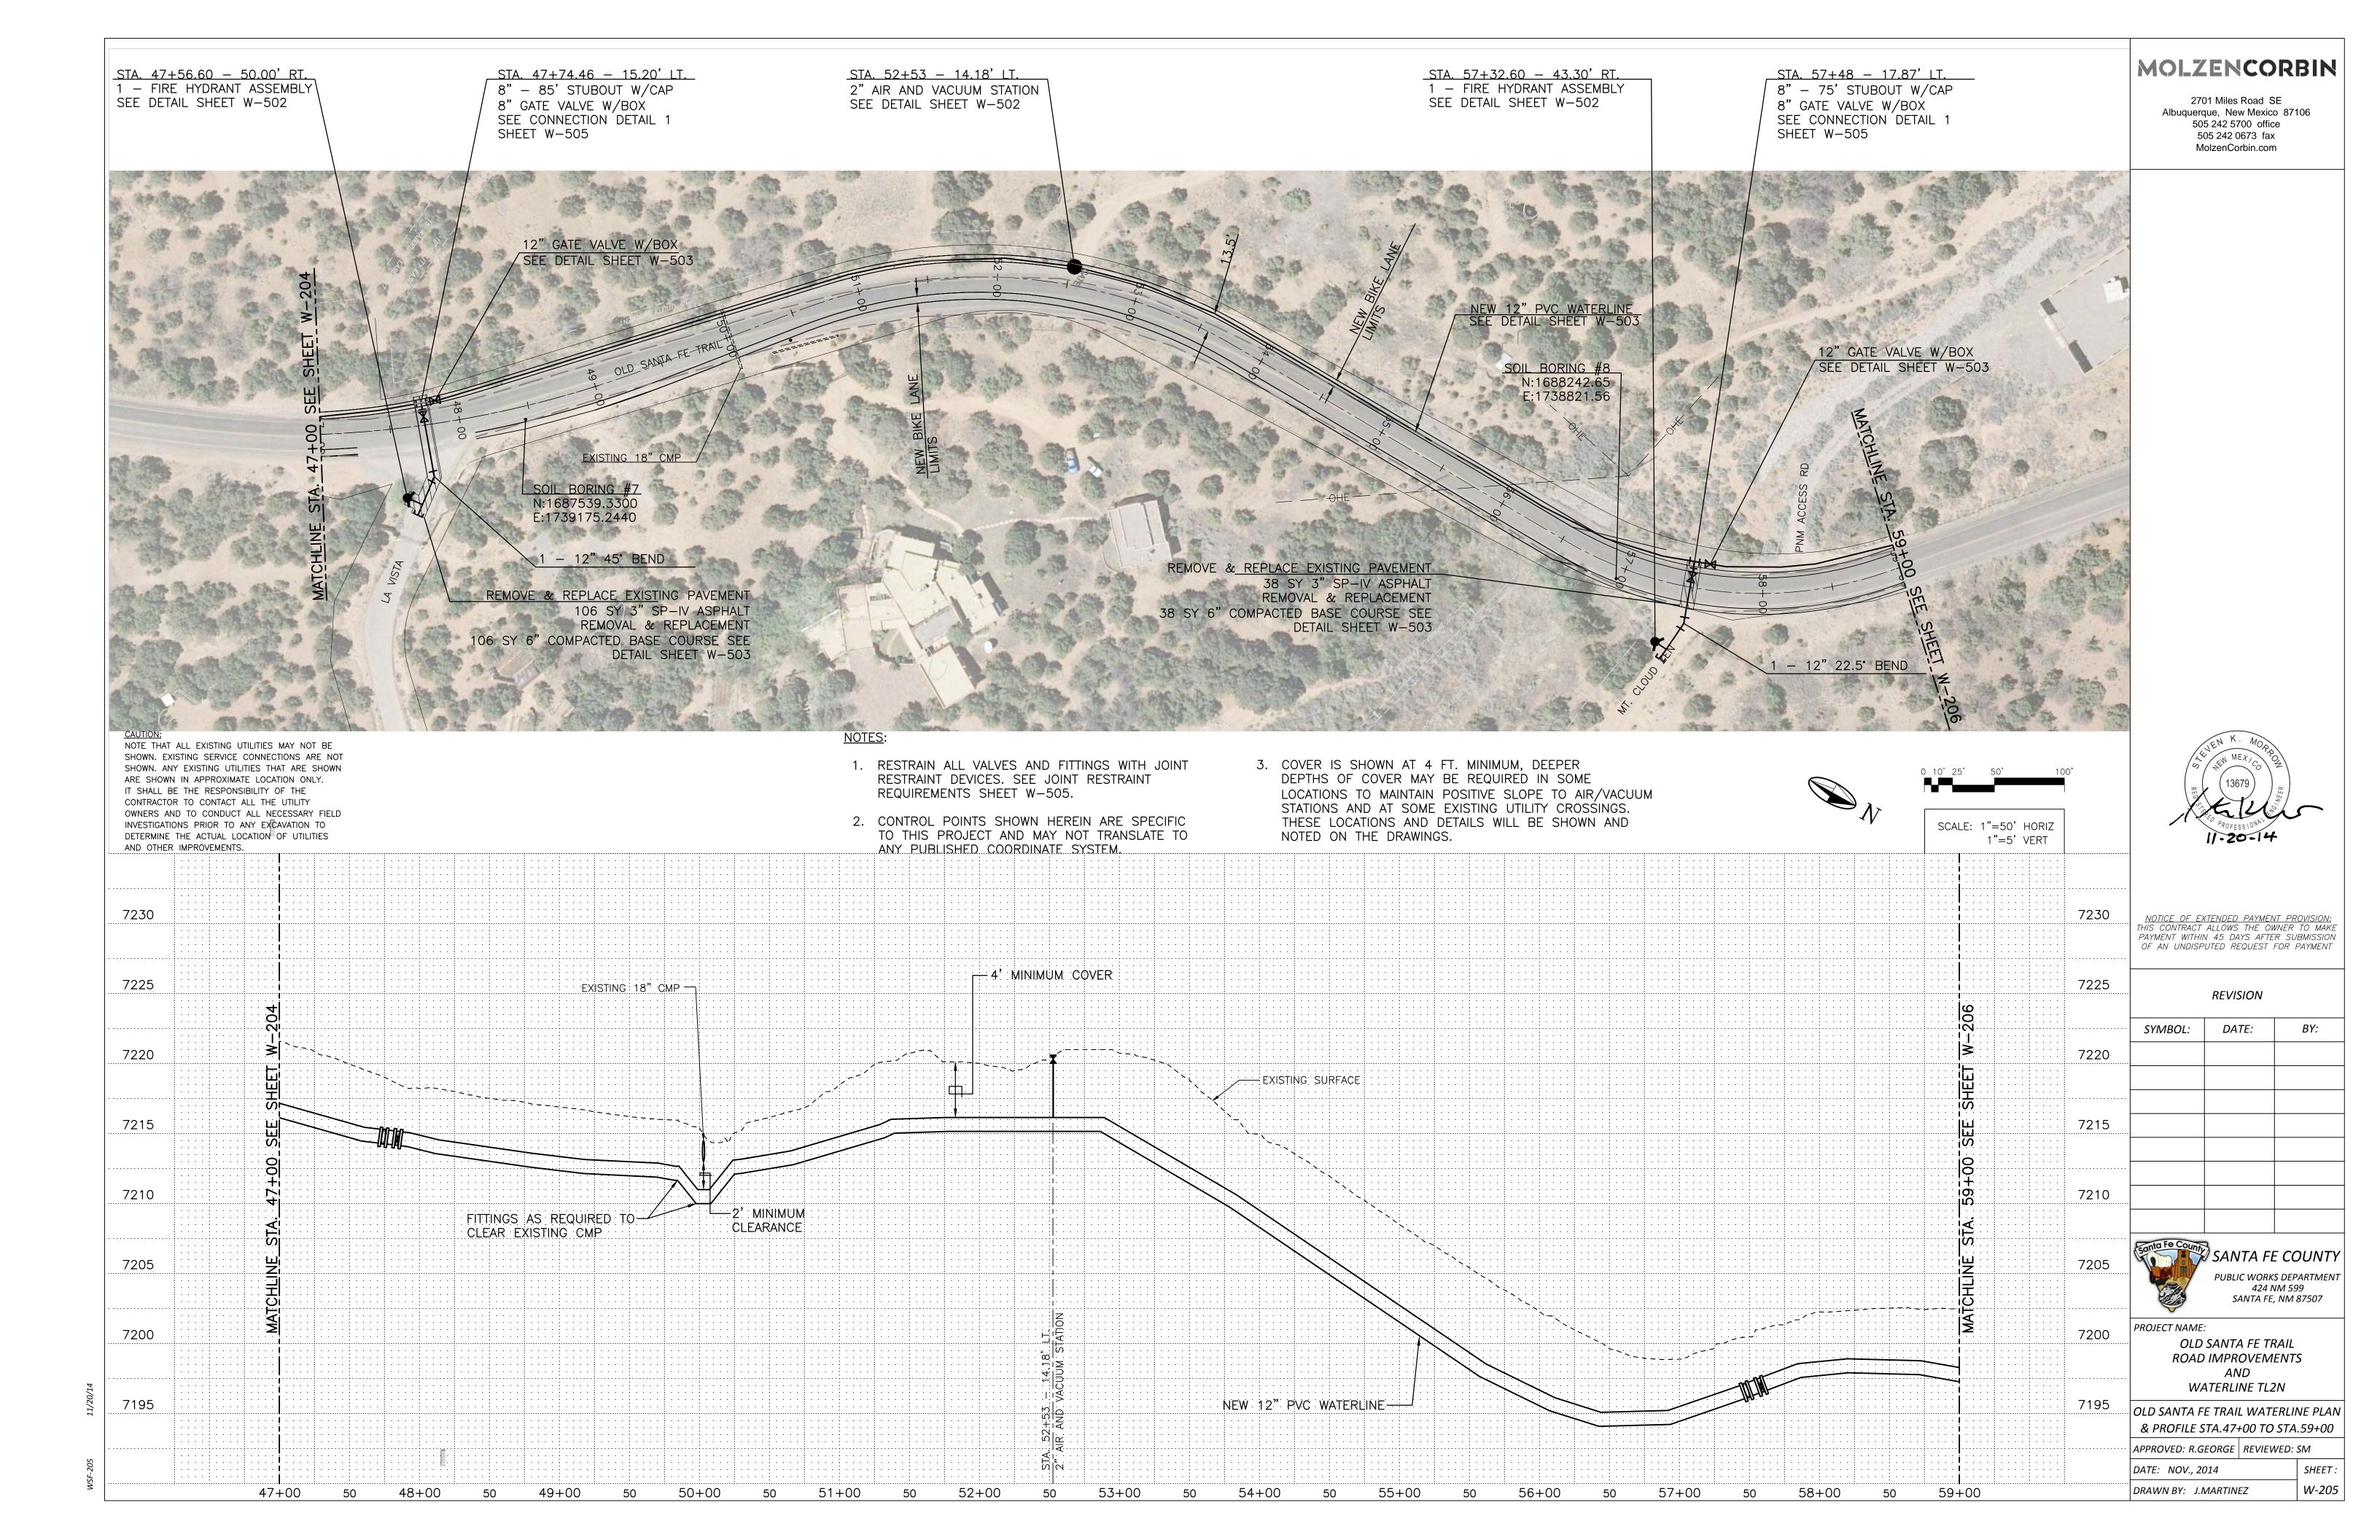

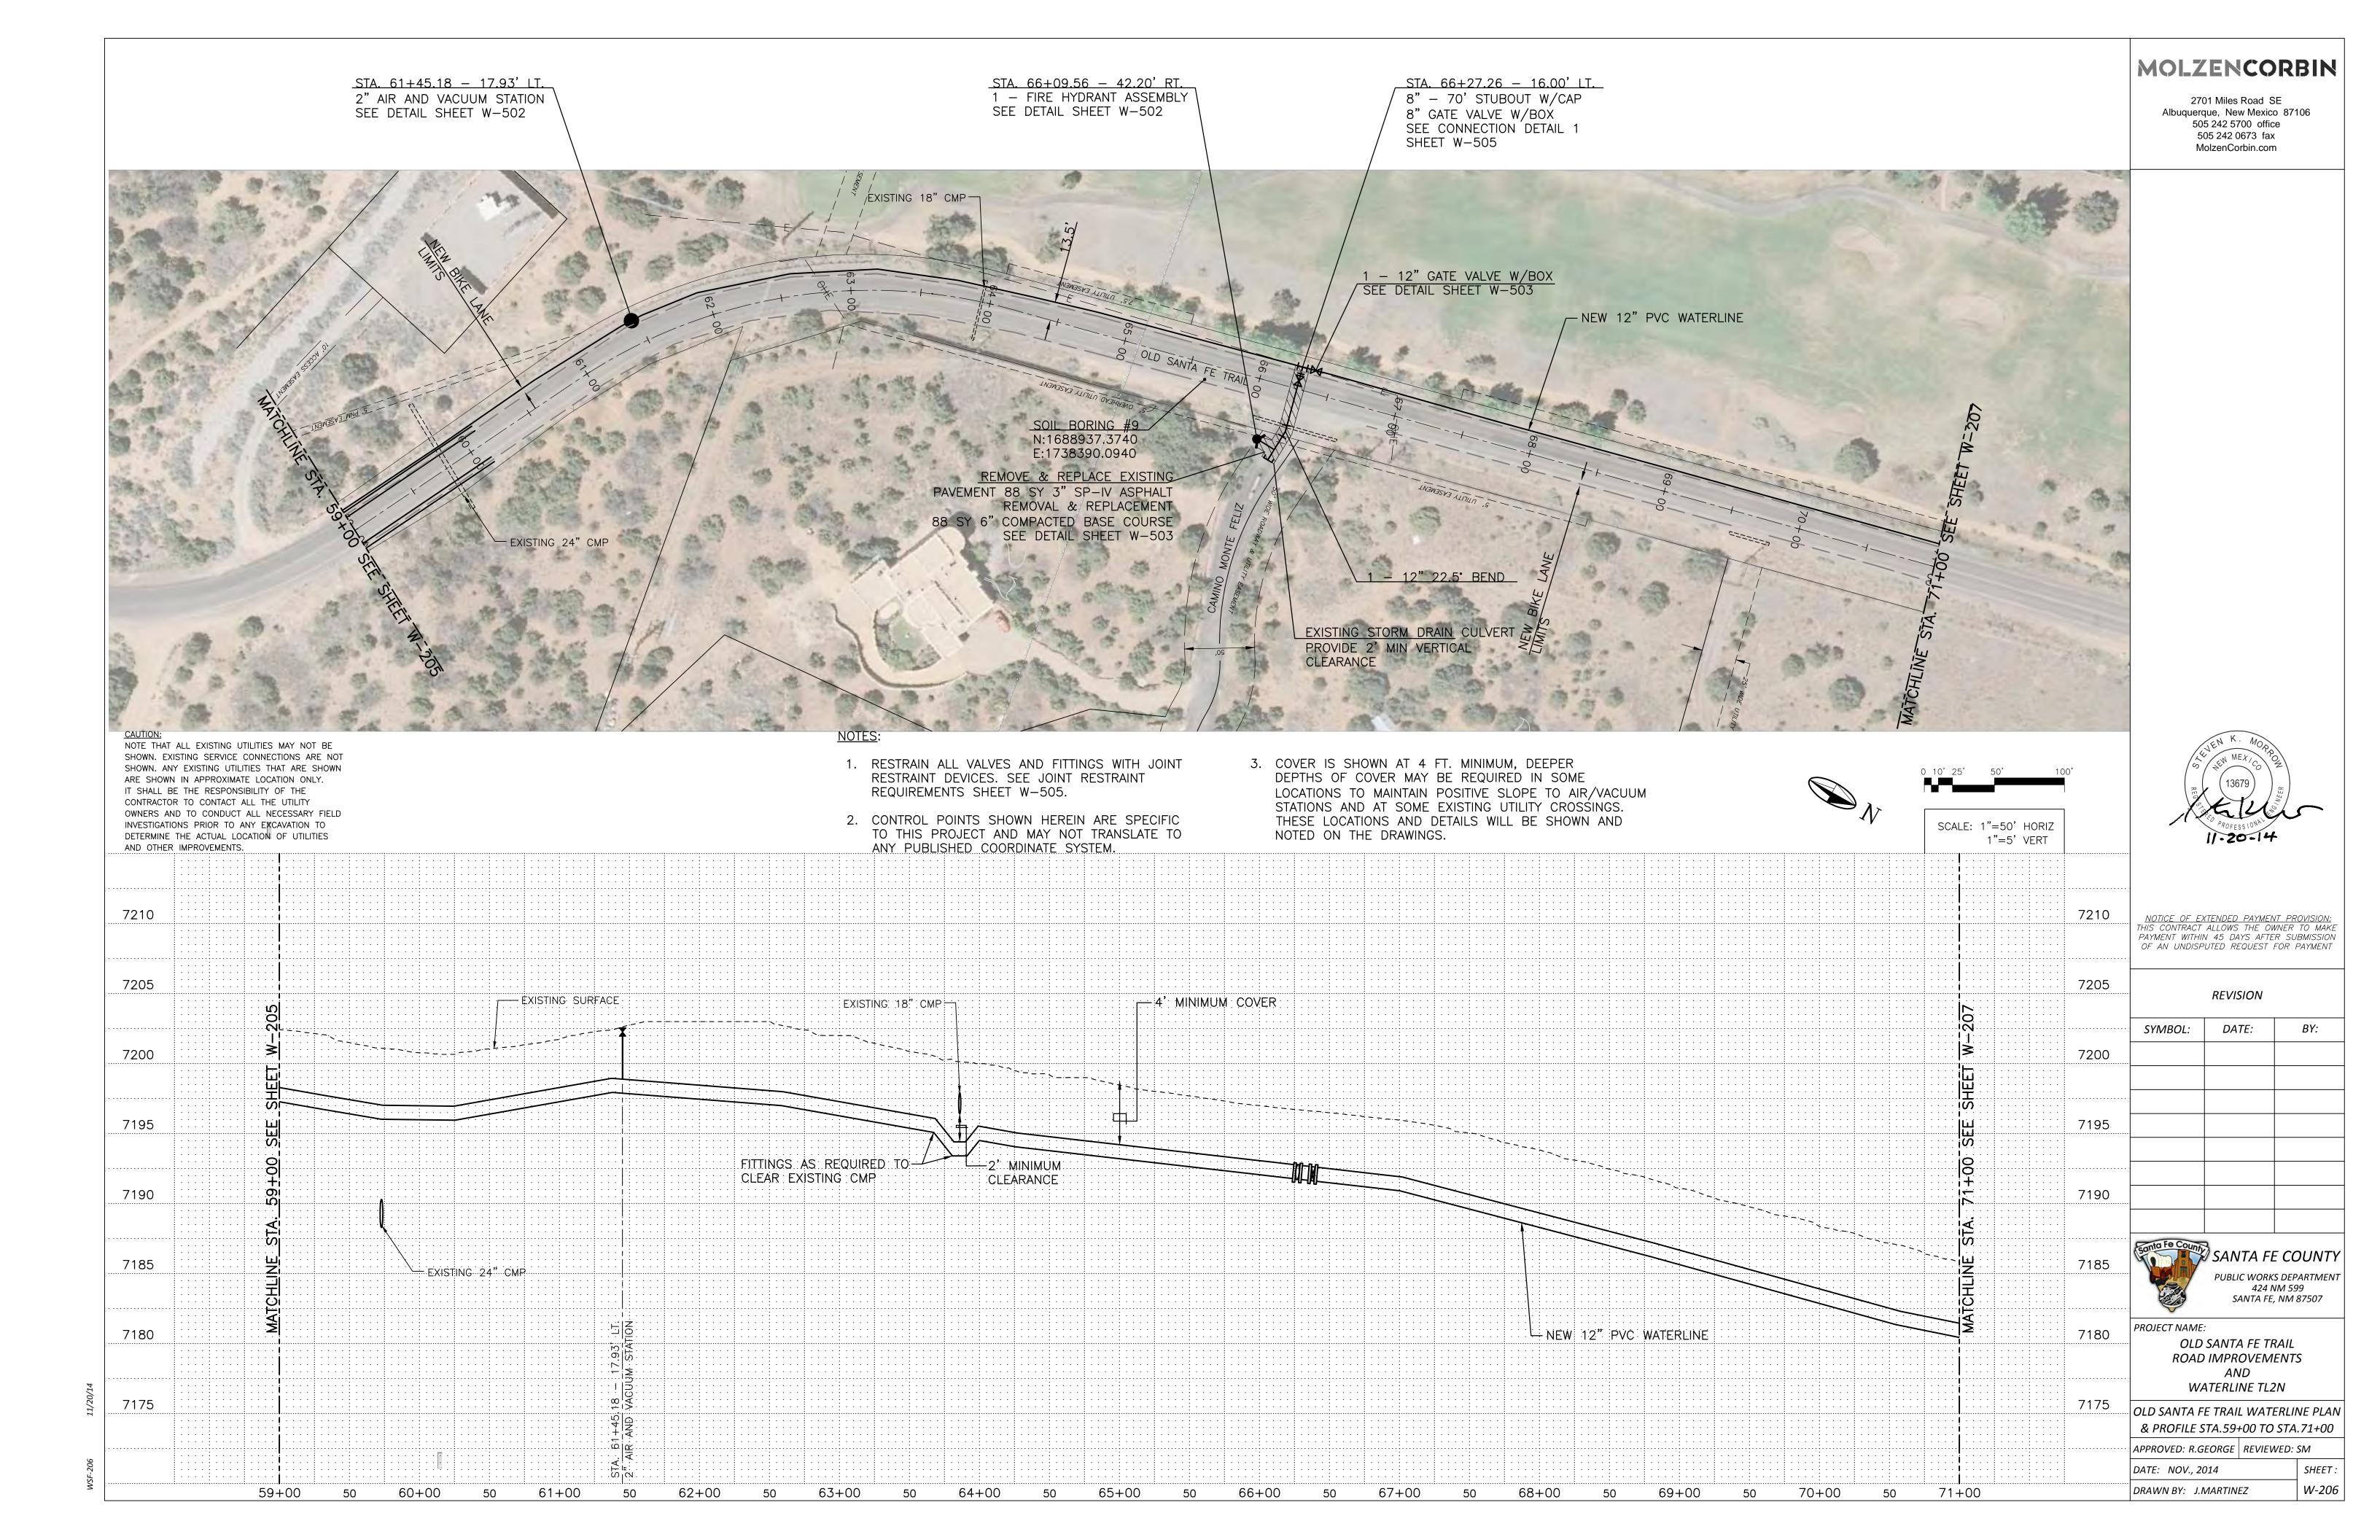

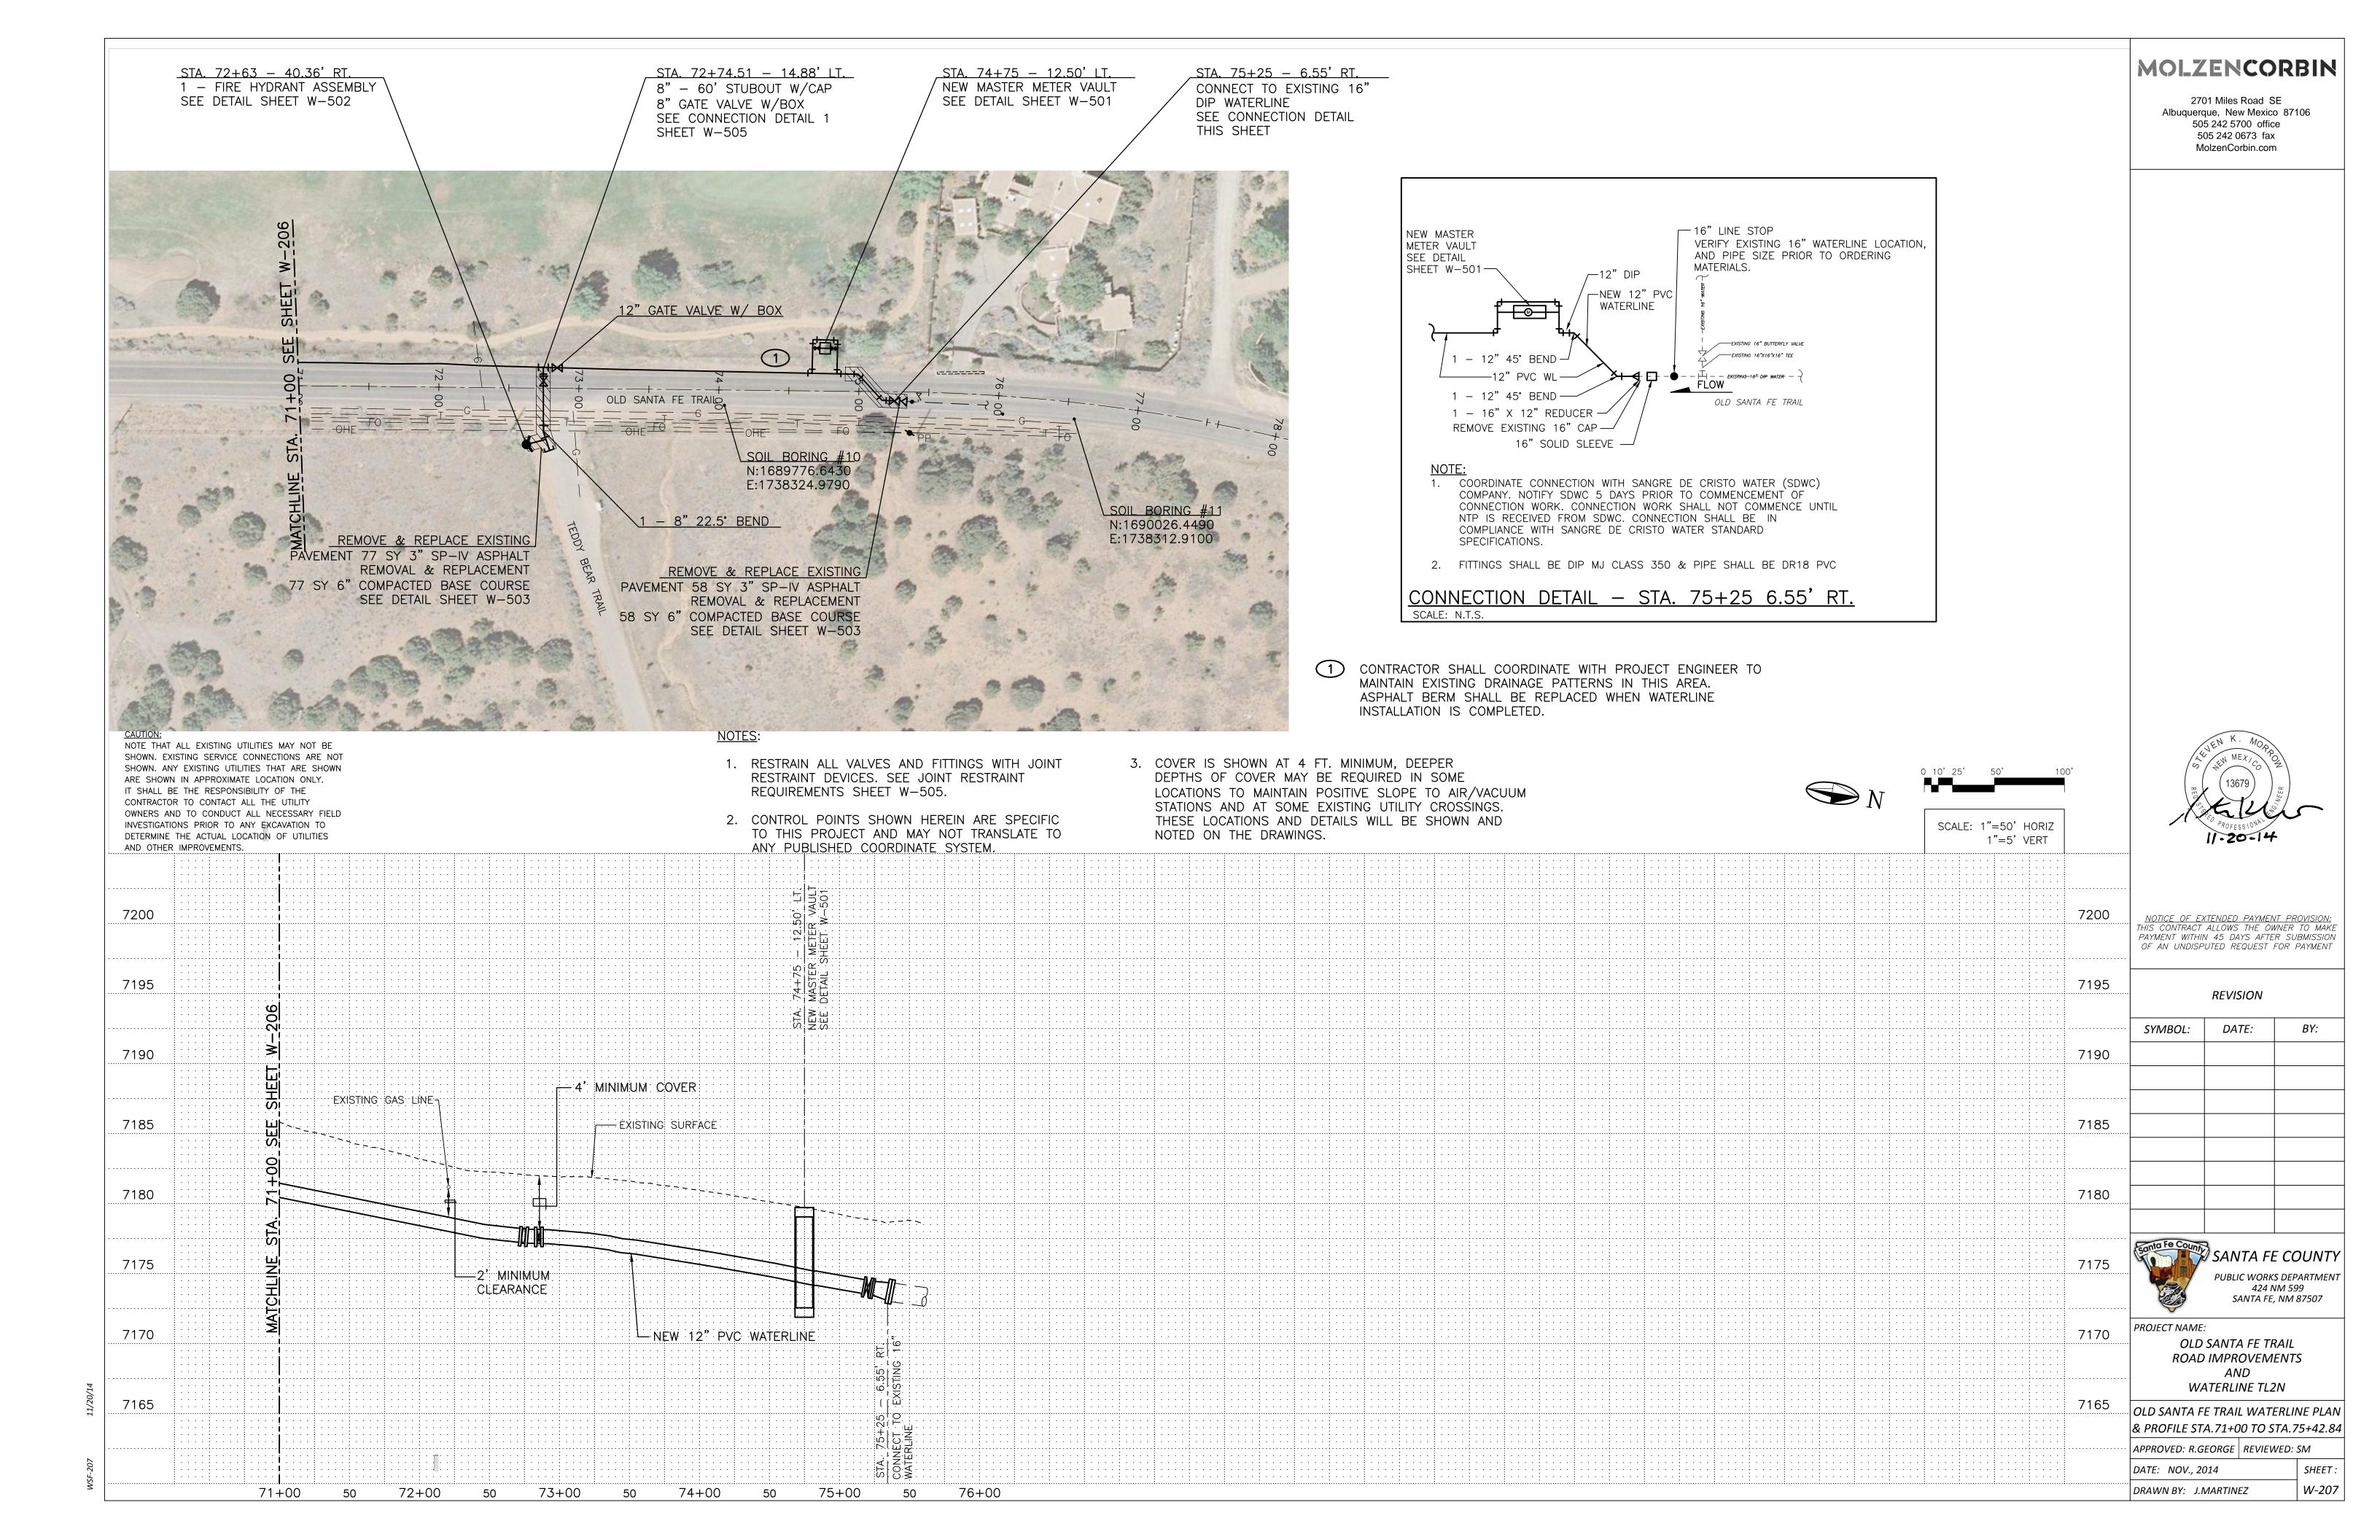

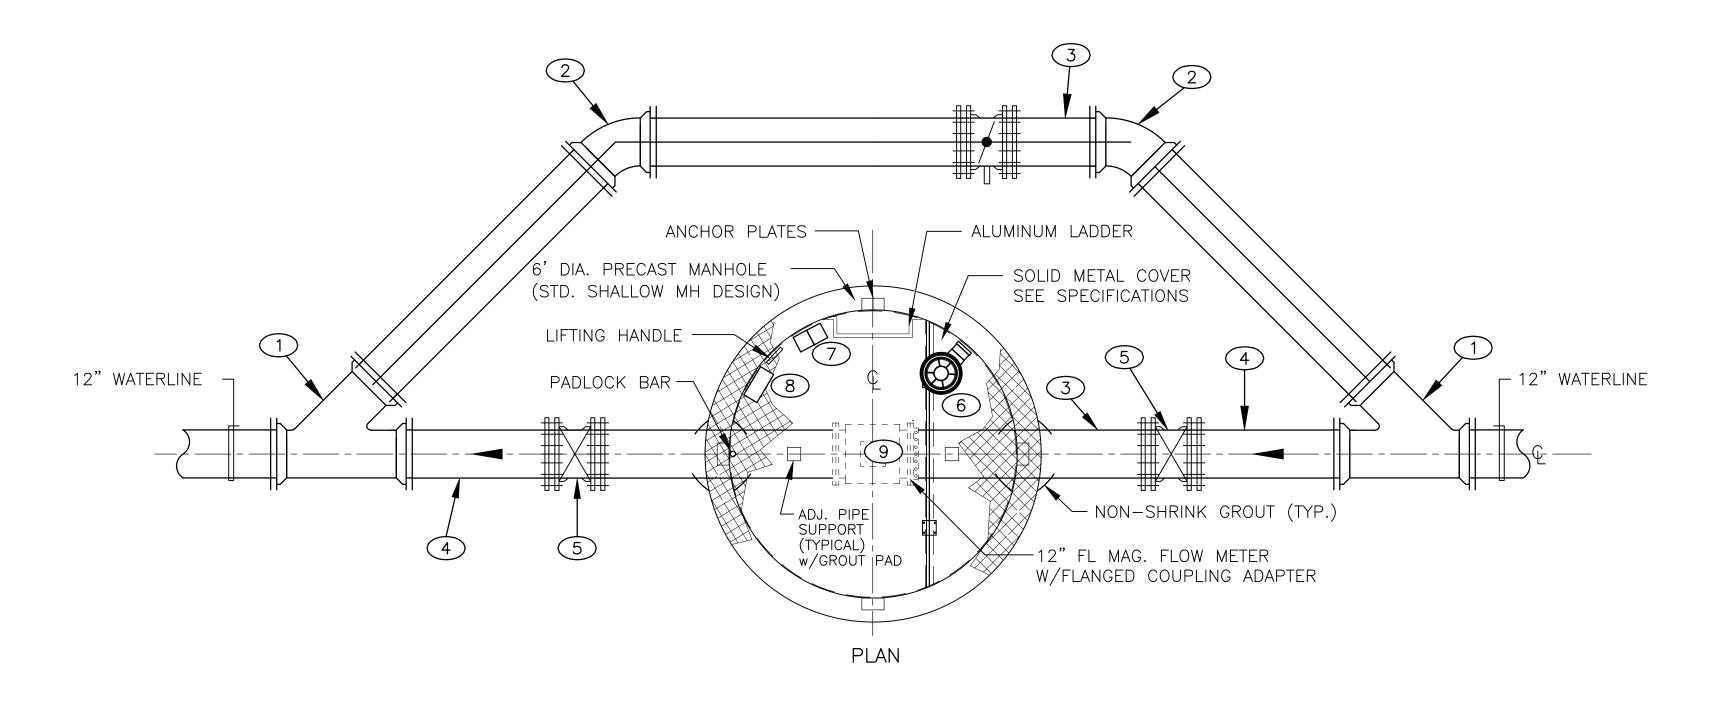

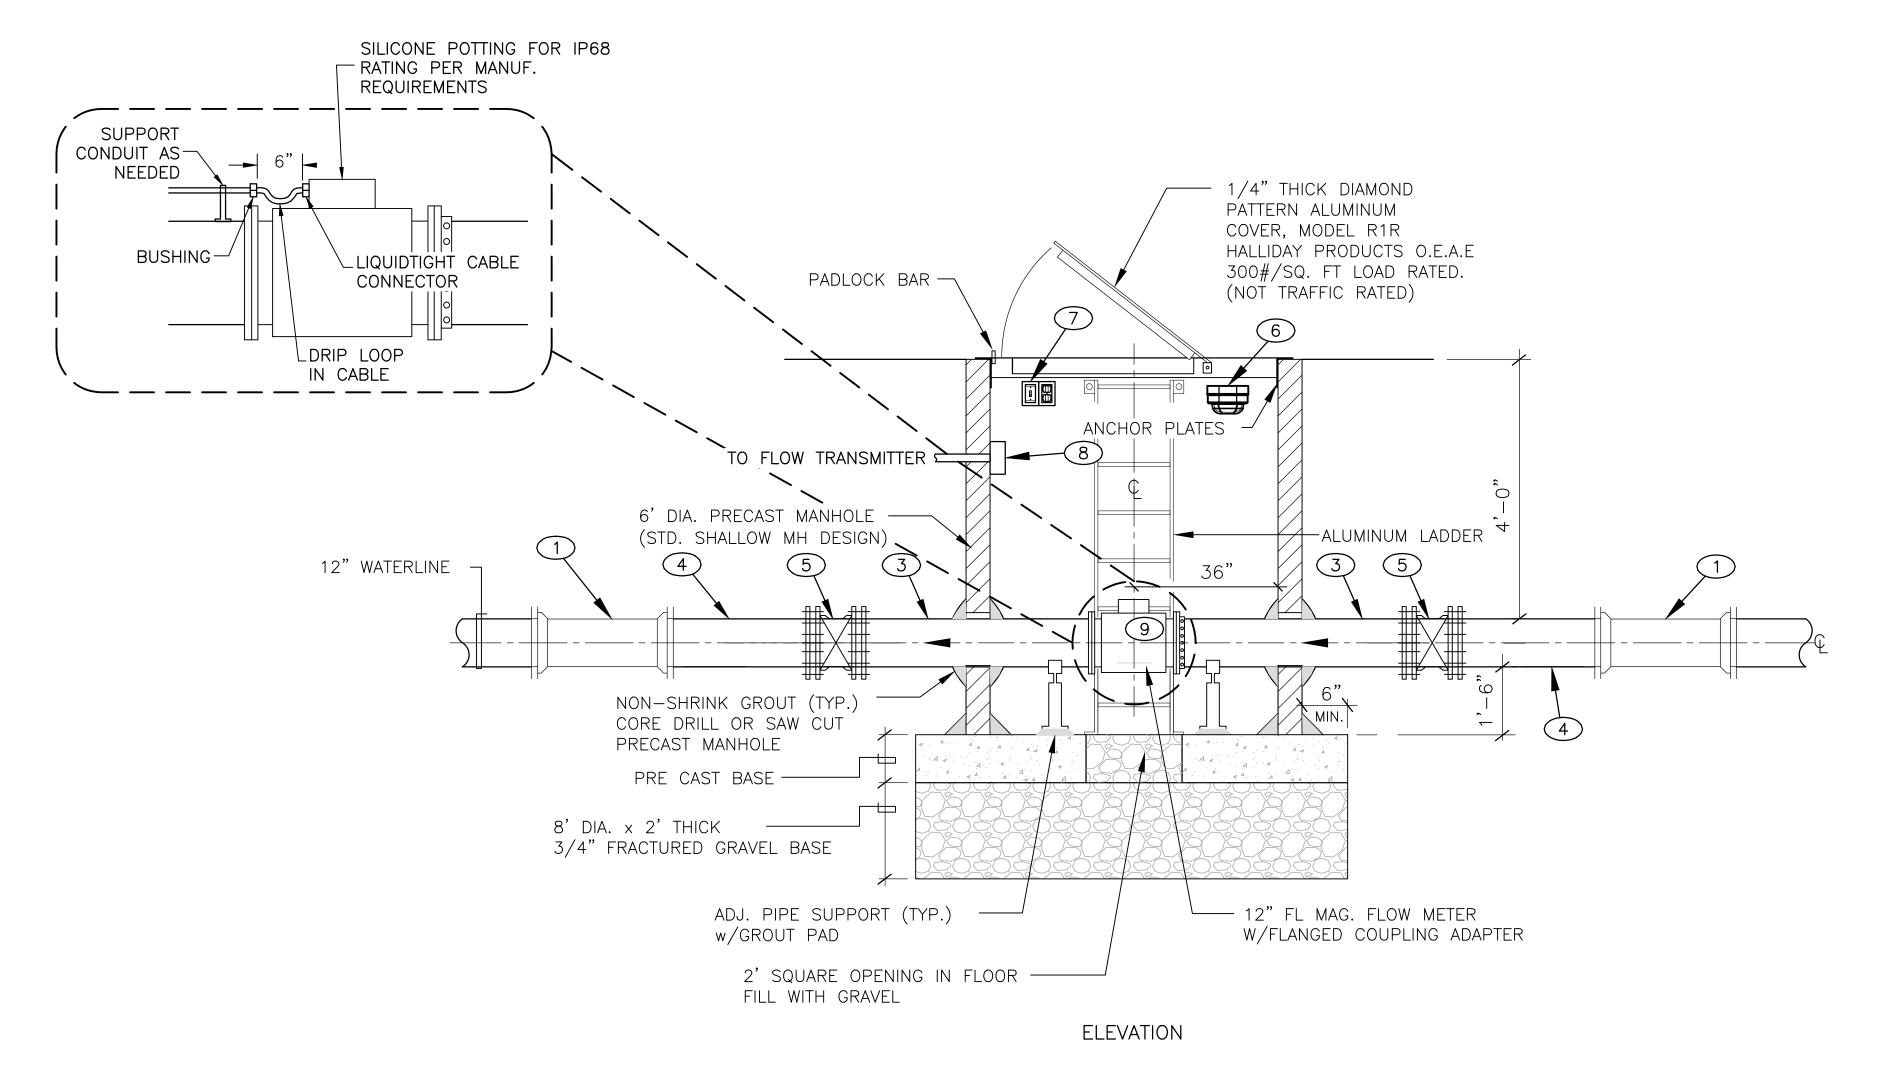

12" FLOW METER ASSEMBLY — DETAIL SCALE: 1/2"=1"

KEYED NOTES

- 12" MJ WYE
- (2) 12"-45° MJ BEND
- (3) 12" SPOOL PEXPE, 24" LONG
- (4) 12" SPOOL PEXPE, 36" LONG
- (5) 12" GATE VALVE (MJ ENDS)
- PROVIDE 45W, LED TYPE, NEMA 4X, IP66, WET LISTED, LUMINAIRE WITH STAINLESS STEEL WIRE GUARD AND WALL MOUNT OUTLET BOX OPTION FOR MOUNTING ON THE WALL. RIG—A—LITE, SAFJ LED SERIES OR ENGINEER REVIEWED EQUIVALENT.
- 7 LIGHT SWITCH AND GFCI RECEPTACLE IN WEATHER PROOF WHILE NOT IN USE ENCLOSURES.
- 8 12"x12", HINGED, NEMA 4 ENCLOSURE. LOCATION SHOWN IS FOR DRAFTING PURPOSES ONLY.
 INSTALL AS NEEDED FOR ROUTING OF CONDUITS TO THE FLOW TRANSMITTER. SHOW THE EXACT LOCATION ON THE AS—BUILTS.
- 9 12" KROHNE OPTIFLUX 4000 METER WITH IFC 300 WALL-MOUNTED SIGNAL CONVERTER (NO SUBSTITUTION).



2701 Miles Road SE
Albuquerque, New Mexico 87106
505 242 5700 office
505 242 0673 fax
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	REVISION		
SYMBOL:	DATE:	BY:	



PROJECT NAME:

OLD SANTA FE TRAIL

ROAD IMPROVEMENTS

WATERLINE TL2N

MASTER METER


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VAULT DETAIL


APPROVED: R.GEORGE REVIEWED: SM

DATE: NOV., 2014 SHEET:


DRAWN BY: J.MARTINEZ W-501

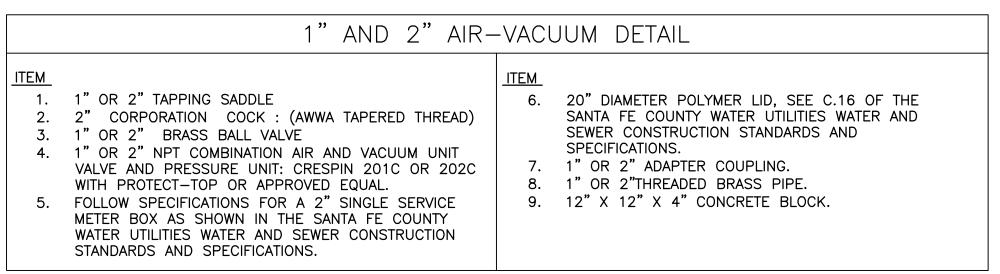

- NOTE: SEE APPROVED CONSTRUCTION PLANS FOR SERVICE LOCATION DETAIL FOR PLACEMENT DIMENSIONS AND DIRECTIONS.
- NOTE: DETAILS ON THIS SHEET ARE REFERENCED FROM THE SANTA FE COUNTY WATER UTILITIES WATER AND SEWER CONSTRUCTION STANDARDS AND SPECIFICATIONS. REFER TO PROJECT MANUAL APPENDIX E.

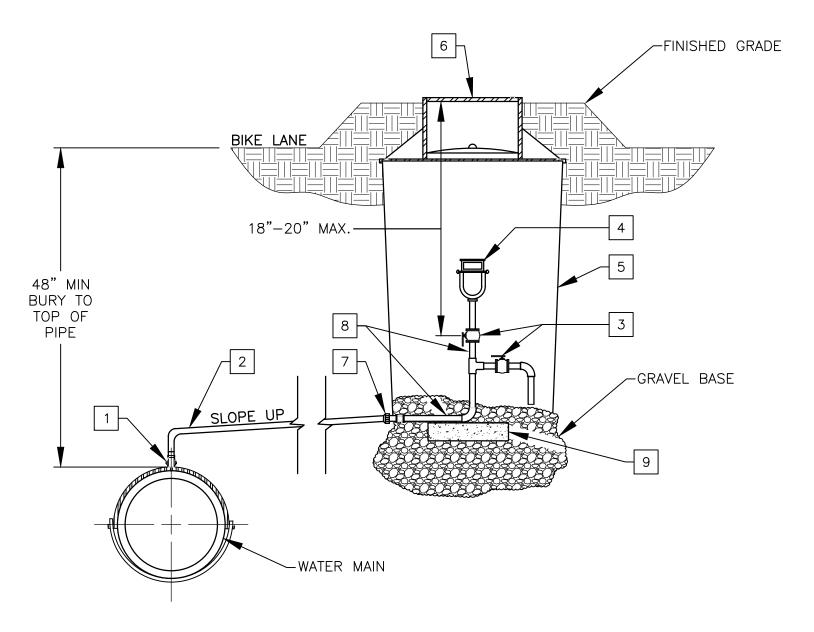

2" SINGLE BODY WATER COMBINATION AIR VALVE STATION - SECTION SCALE: NONE

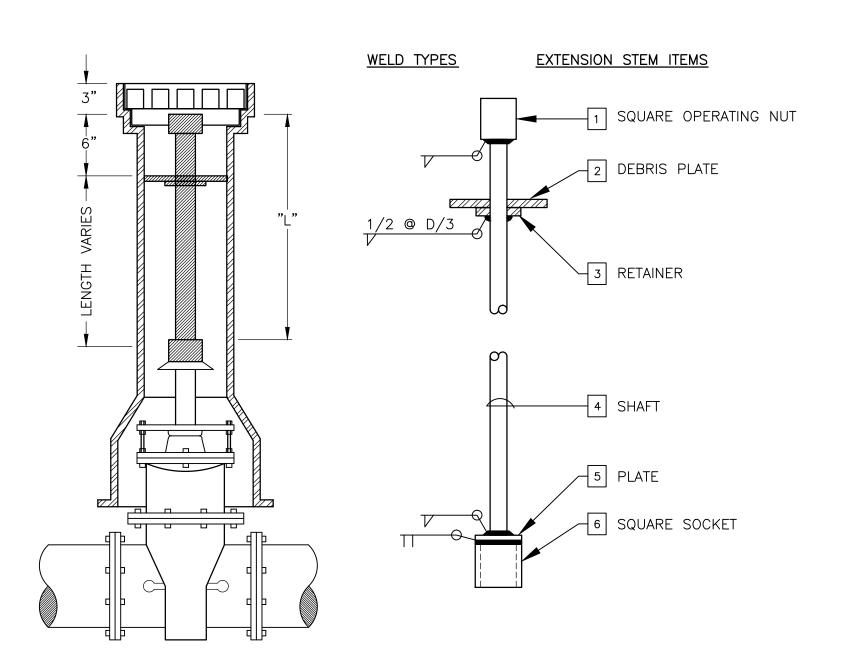

1. 2" x 2" x 2" BAR

2. 5" DIA. PLATE 3/16" WITH 1-3/8" DIA. HOLE

3. 1-3/8" DIA. HEAVY WASHER

4. 1" DIA. SCHEDULE 40 STEEL PIPE (L < 6')1-1/4" DIA. SCHEDULE 40 STEEL PIPE (L > 6")


5. 2-1/2" x 2-1/2" x 1/4" PLATE 6. 2-1/2" x 2-1/2" x 1/4" TUBING

VALVE STEM EXTENSION DETAIL


SCALE: NONE


NOTE: ALL STEEL TO BE SAW OR MACHINE CUT.

NOTE: DETAILS ON THIS SHEET ARE REFERENCED FROM THE SANTA FE COUNTY WATER UTILITIES WATER AND SEWER CONSTRUCTION STANDARDS AND SPECIFICATIONS.

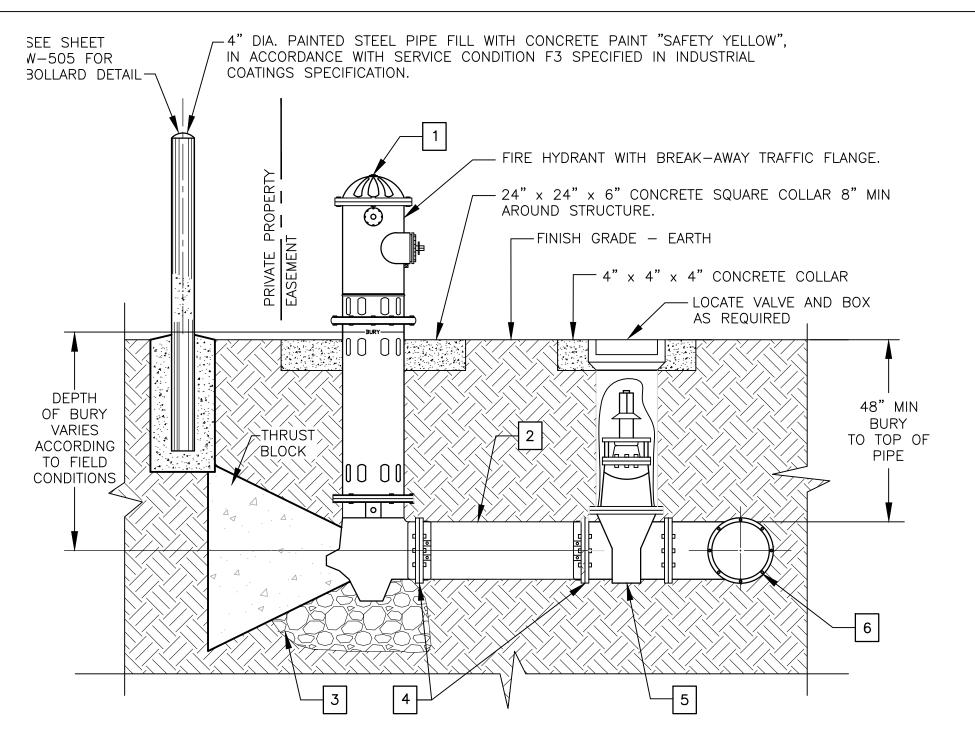

FIRE HYDRANT ASSEMBLY DETAIL — ADDITIVE ALTERNATE #2

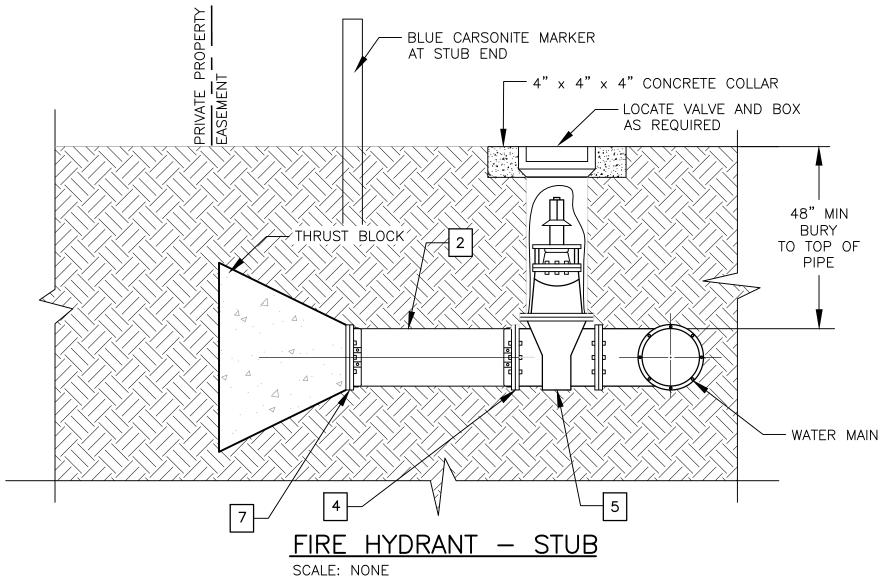

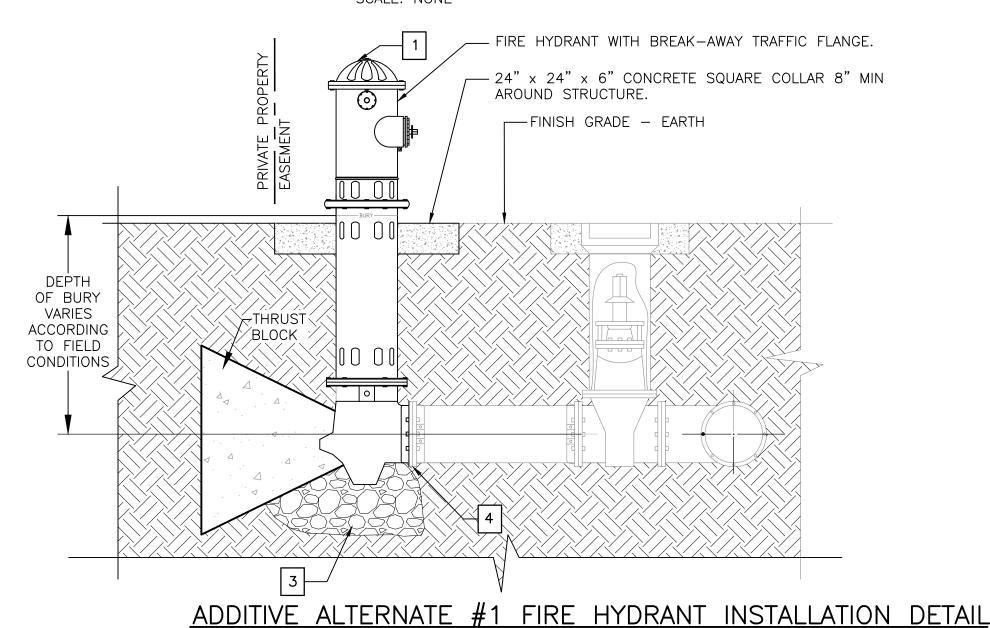

KEYED NOTES:

FIRE HYDRANT

REMOVE THRUST BLOCK. 1/2 CUBIC YARD 3/8" GRAVEL DRAIN W/10 MIL. PLASTIC SHEET

6" MJ x FL GATE VALVE AND BOX

TEE: MJ RUN W/6" FLANGE OUTLET

6" RESTRAINED CAP

A. FIRE HYDRANT SHALL NOT BE INSTALLED NEAR ANY STRUCTURES AND SHALL HAVE A MINIMUM 30" CLEAR SPACE IN ALL DIRECTIONS.

B. HYDRANT TO BE SET PLUMB AND AT PROPER ELEVATION (ELEVATION PROVIDED BY DEVELOPER) HYDRANTS INSTALLED AS PART OF A NEW DEVELOPMENT/EXTENSION SHALL BE A STANDARD 5' BURY HYDRANT AND SHALL BE SET TO FINISHED GRADE WITHOUT THE USE OF HYDRANT EXTENSIONS (IF AN ADJUSTMENT IS REQUIRED, RE-LAY THE WATER MAIN AND FIRE HYDRANT LEG OR INSTALL RESTRAINED OFFSET

C. WEEP HOLE MUST HAVE 1/4" PLUG REMOVED AND BE FREE DRAINING INTO GRAVEL DRAIN. USE FULLY RESTRAINED JOINTS FROM THE FIRE

D. FIRE HYDRANT SHALL BE PAINTED AND REFLECTIVE NUMBERS

E. REFER TO RESTRAIND JOINT TABLE ON SHEET W-505

F. RESTRAINED CAP AND PIPE SHALL BE WRAPPED IN PLASTIC BOND

6" PIPE

6" MJ RETAINER AND 6" HARNESS (IF REQUIRED) RESTRAINED JOINTS

AS DIRECTED BY SFCU).

HYDRANT TO THE FLANGED CONNECTION ON VALVE DEPTH.

INSTALLED AFTER INSTALLATION

BREAKER BEFORE INSTALLATION OF THRUST BLOCK

13679 11-20-14

MOLZENCORBIN

2701 Miles Road SE Albuquerque, New Mexico 87106

505 242 5700 office

505 242 0673 fax

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NOTICE OF EXTENDED PAYMENT PROVISION: IS CONTRACT ALLOWS THE OWNER TO MAKE PAYMENT WITHIN 45 DAYS AFTER SUBMISSION OF AN UNDISPUTED REQUEST FOR PAYMENT

REVISION SYMBOL: DATE: BY:



PROJECT NAME:

OLD SANTA FE TRAIL ROAD IMPROVEMENTS AND


AIR AND VACUUM STATION DETAIL

WATERLINE TL2N

APPROVED: R.GEORGE | REVIEWED: SM DATE: NOV., 2014

W-502 DRAWN BY: J.MARTINEZ

USE MECHANICALLY RESTRAINED FITTINGS & PIPE JOINTS FOR THRUST RESTRAINT UNLESS CONCRETE BLOCKING IS SPECIFICALLY CALLED FOR BY SDCW

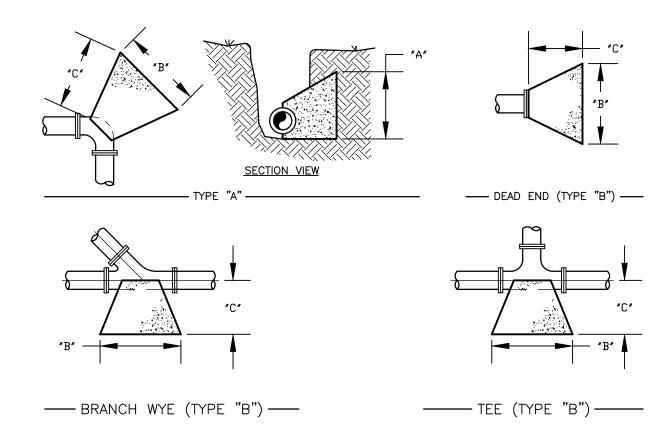


THRUST BLOCK SIZING TABLE

PIPE		TYPE "A" BENDS								TYI	ЭЕ ,	"B"			
DIAMETER	11	-1/	′4°	22	:-1/	′2°		45°			90°		FI	ΓΤΙΝ	GS
	Α	В	С	Α	В	С	Α	В	С	Α	В	С	Α	В	С
4"	12	12	12	12	12	12	12	12	12	12	12	12	12	12	12
6"	12	12	12	12	12	12	12	18	12	18	24	12	12	24	12
8"	12	12	12	12	18	12	18	24	12	24	30	18	18	30	12
10"	12	12	12	12	24	12	20	30	12	24	42	18	24	36	18
12"	12	18	12	18	24	12	24	36	18	32	48	24	24	42	18
14"	12	24	12	18	36	18	30	42	24	36	60	24	30	48	24
16"	18	24	24	24	36	24	30	40	24	42	66	24	36	54	24
18"	18	30	24	24	40	24	36	54	24	48	72	24	42	60	24
20"	20	30	24	30	42	24	42	60	24	54	80	24	42	76	24
24"	24	36	24	36	54	24	48	72	24	66	96	30	54	80	30

- 1. TABLE BASED ON 200 P.S.I. (130 P.S.I. WORKING PRESSURE) AND 3000 LB/FT^2 ALLOWABLE SOIL BEARING PRESSURE.
- 2. USE TEE OUTLET DIAMETER TO DETERMINE THRUST BLOCK SIZING. USE BRANCH DIAMETER ON WYE TO DETERMINE THRUST BLOCK SIZING.
- 3. THE "C" DIMENSION LISTED IS A MINIMUM DIMENSION. CONCRETE BLOCKING MUST BE POURED TO THE UNDISTURBED SOIL OF THE TRENCH WALL.

CONCRETE THRUST BLOCKING DETAIL SCALE: NONE

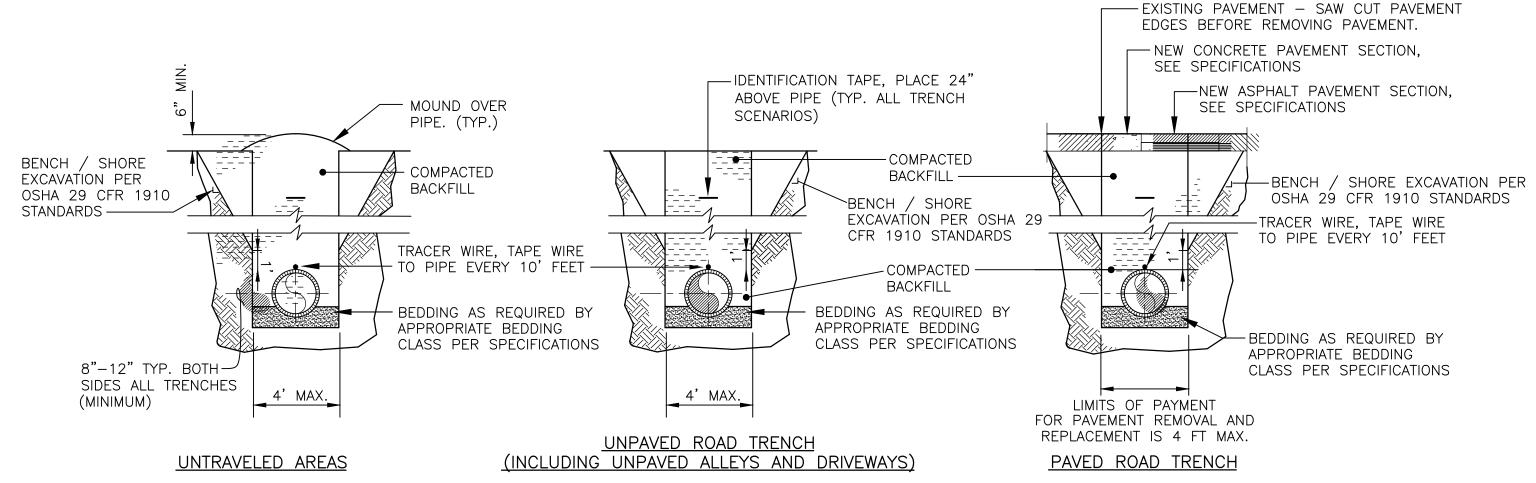

GENERAL NOTES FOR TRENCHING:

- 1. PIPE BEDDING REQUIREMENTS, SEE SPECIFICATIONS
- 2. PIPE IDENTIFICATION TAPE REQUIREMENTS, SEE SPECIFICATIONS3. TRENCH BACKFILL COMPACTION REQUIREMENTS, SEE SPECIFICATIONS

TRENCH COMPACTION DETAILS

SCALE: NONE

VALVE BOX INSTALLATION:

NEW PAVING

VALVE BOXES SHALL BE INSTALLED AND RAISED TO GRADE IN THE FOLLOWING MANNER FOR NEW PAVING.

- 1. VALVE BOX SHALL BE INSTALLED OVER VALVE DURING MAIN INSTALLATION. TOP OF VALUE BOX SHALL BE LEFT BELOW THE TOP OF SUB-GRADE UNTIL VALVE IS READY TO BE RAISED TO FINAL GRADE.
- 2. WHEN THE VALVE BOX IS READY TO BE RAISED, AN OCTAGON SHAPE SHALL BE CUT—OUT AROUND THE VALVE BOX FROM THE FIRST PAVING LIFT (AS SHOWN IN DETAIL) THE VALVE BOX SHALL BE RAISED TO THE FINISHED STREET GRADE; THE SOIL AROUND THE VALVE BOX SHALL BE THOROUGHLY COMPACTED IN ACCORDANCE WITH SFC STANDARDS; THE CONCRETE COLLAR (CONSISTING OF 3,000 PSI CONCRETE AND #4 REBAR) SHALL BE POURED FLUSH WITH TOP OF THE FIRST PAVING COURSE (INCLUDING HAND RODDING CONCRETE TO REMOVE VOIDS) AND THE VALVE BOX SHALL BE PROTECTED FROM VEHICULAR TRAFFIC FOR 24 HOURS.

EXISTING PAVING


INSTALL VALVE BOXES PER "NEW PAVING" (ABOVE) WITH THE CONCRETE COLLAR POURED FLUSH WITH THE FINISHED GRADE OF THE EXISTING PAVING WITH A SMOOTH TROWELED FINISH. NOTE: IF EXCAVATION OVER 42" SQUARE IS REQUIRED TO ADJUST VALVE BOX TO GRADE, "NEW PAVING" CONCRETE COLLAR PROCEDURES SHALL BE FOLLOWED AS WELL AS ANY NECESSARY PAVING SHALL BE COMPLETED.

LINDAY/ED ADEAC


IN DIRT OR GRAVEL STREETS, TOP OF VALVE BOX AND CONCRETE COLLAR SHALL BE LEFT 6" BELOW THE STREET GRADE. IN OTHER UNPAVED AREAS, VALVE BOX AND CONCRETE COLLAR SHALL BE LEFT 2" ABOVE FINISHED GRADE OR AS DIRECTED BY SFC UTILITIES.

PROTECTION OF VALVE BOXES:

VALVE BOXES SHALL BE PROTECTED FROM DAMAGE, LOSS AND SHALL NOT BE FILLED WITH DIRT AND DEBRIS. VALVES MUST BE ACCESSIBLE DURING CONSTRUCTION WITH MINIMUM EXCAVATION. VALVES IDENTIFIED BY SFC UTILITIES AS KEY SHUT OFF VALVES SHALL REMAIN AT GRADE AND PROTECTED DURING ALL PHASES OF CONSTRUCTION.

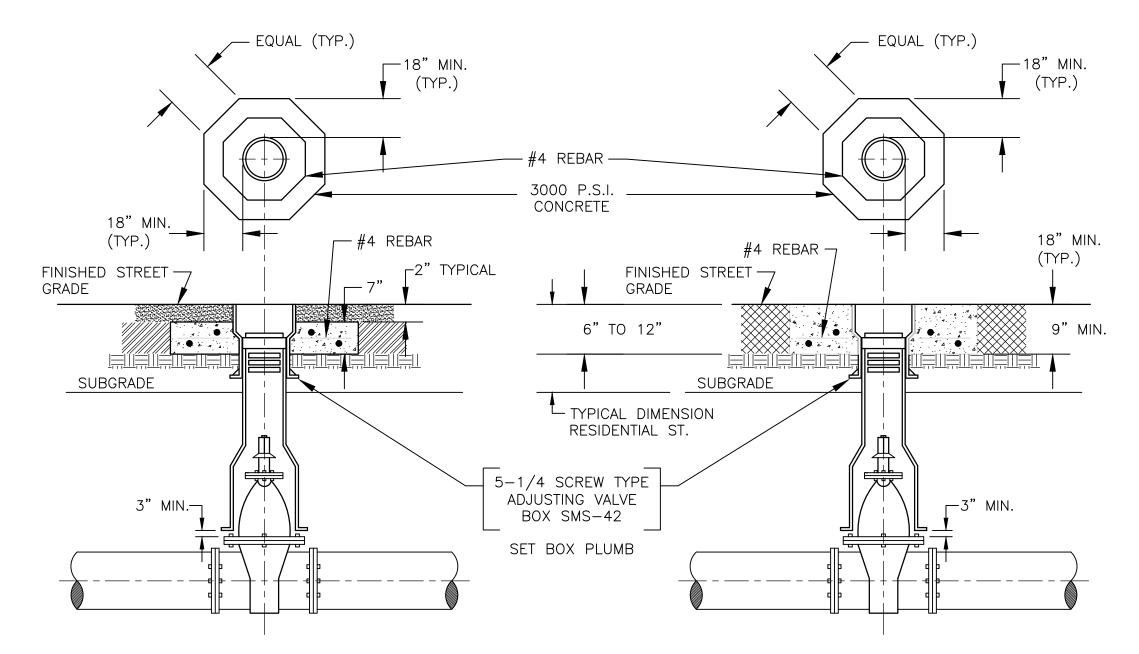


NEW PAVING SCALE: NONE

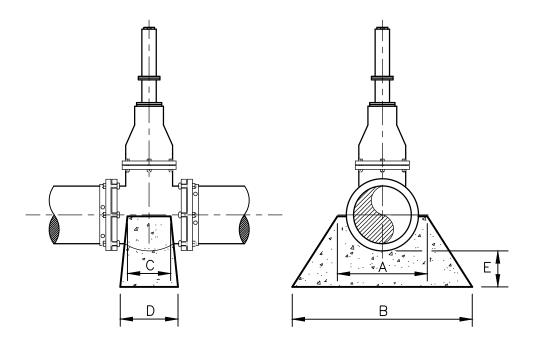

VAI	COI _VE SU	NCRETE PPORT			
ALVE SIZE	Α	В	С	D	E
4"	10"	20"	4"	6"	6" MIN.
6"	12"	22"	4"	8"	6" MIN.
8"	12"	22"	4"	8"	6" MIN.
10"	14"	24"	4"	8"	6" MIN.
12"	16"	24"	4"	8"	6" MIN.
14"	20"	28"	6"	12"	6" MIN.
16"	24"	36"	6"	12"	6" MIN.

CONCRETE VALVE SUPPORT DETAILS

EXISTING PAVING SCALE: NONE

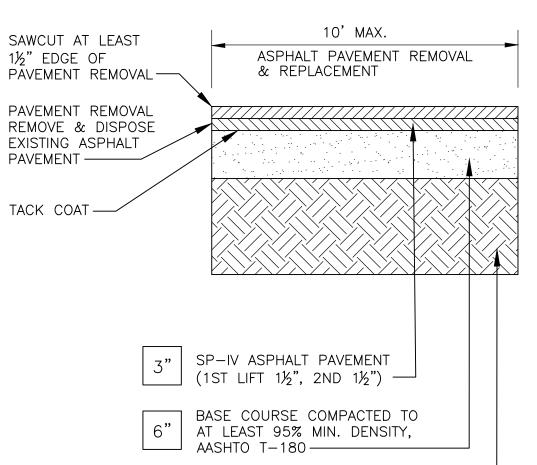

12" SUBGRADE COMPACTED TO
12" AT LEAST 95% MIN. DENSITY
AASHTO T-180

NOTE:

1. APPLY TACK COAT TO SAWCUT EDGE PRIOR TO PLACING ASPHALT LIFT

ASPHALT PAVEMENT SECTION

MOLZENCORBIN

2701 Miles Road SE Albuquerque, New Mexico 87106 505 242 5700 office 505 242 0673 fax MolzenCorbin.com



NOTICE OF EXTENDED PAYMENT PROVISION:
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PAYMENT WITHIN 45 DAYS AFTER SUBMISSION
OF AN UNDISPUTED REQUEST FOR PAYMENT

REVISION

	REVISION	
SYMBOL:	DATE:	BY:
Santa Fe County	3	- 00///



PROJECT NAME:


OLD SANTA FE TRAIL ROAD IMPROVEMENTS AND

WATERLINE TL2N
STANDARD WATERLINE

APPROVED: R.GEORGE REVIEWED: SM

DATE: NOV., 2014 SHEET:

DRAWN BY: J.MARTINEZ W-503

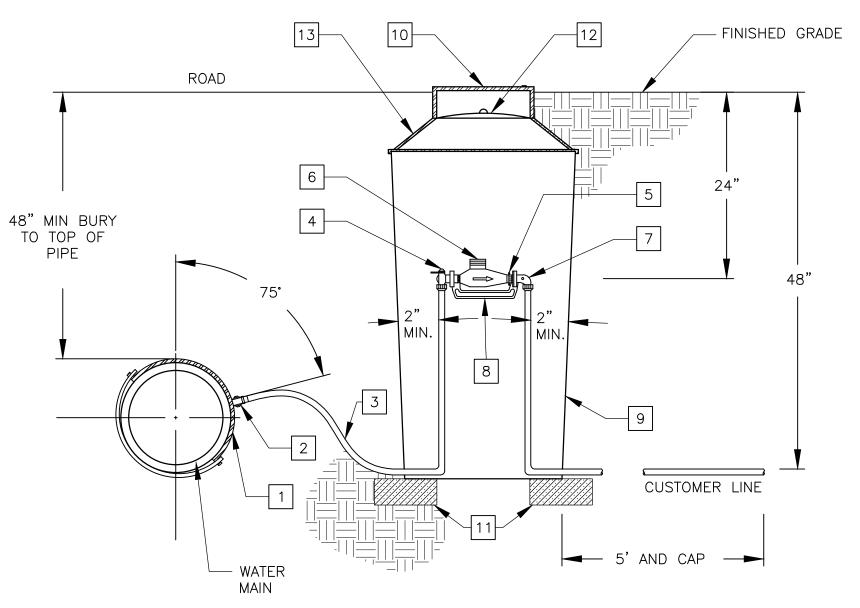

5/8" SINGLE SERVICE DETAIL

- 1. 3/4" SERVICE SADDLE : SEE C.23
- 2. 3/4" CORPORATION STOP: SEE C.22 (A.W.W.A. TAPERED THREAD)
- 3. 3/4" COPPER TUBBING (TYPE "K"): SEE C.13
- 4. 3/4" ANGLE VALVE : SEE C.18
- 5. 3/4" EXPANSION CONNECTION: SEE C.20 (5/8" X 3/4" M.T.R. CONNECTION)


(FURNISHED AND INSTALLED BY SFC UTILITIES)

6. 5/8" X 3/4" NEPTUNE T-10 WATER METER W/E-CODER R900/ REGISTER AND RADIO TRANSMITTER

- 3/4" ANGLE CARTRIDGE W/DUAL CHECK VALVE: SEE C.19
- 8. 3/4" CAST IRON METER YOKE : SEE C.17
- 9. 20" DIA. X 36" METER BOX : SEE C.15
- 10. POLYMER LID (12-5/16" DIA.) : SEE C.16
- 11. BLOCKS USE AS DIRECTED BY SFC UTILITIES
- 12. INNER ALUMINUM FROST LID: SEE C.16 13. DOUBLE LID COVER: SEE C.16
- (20" DIA. X 11-1/2" DIA. INNER OPENING)

5/8" SINGLE SERVICE DETAIL

NOT TO SCALE

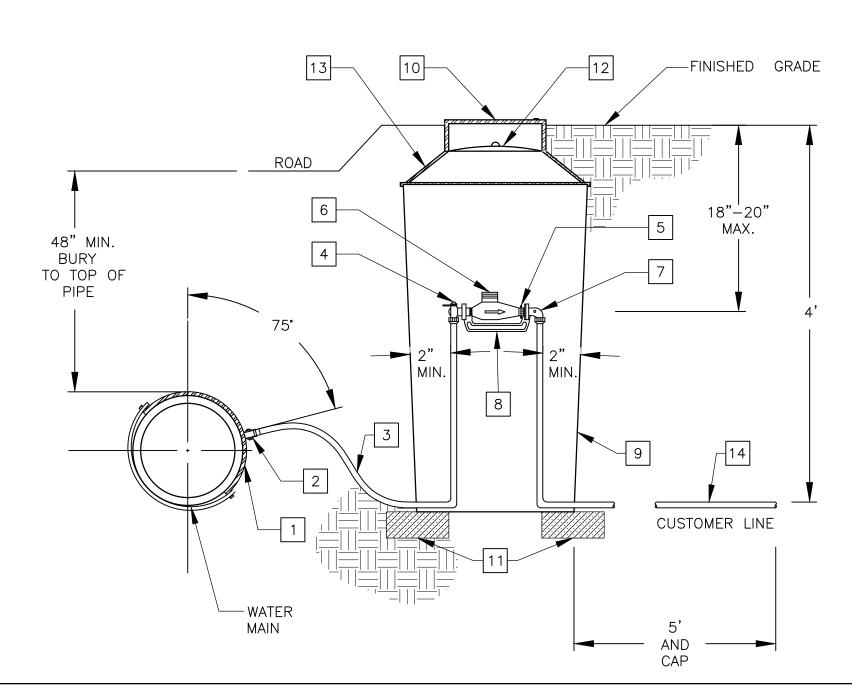

1" SINGLE SERVICE DETAIL

1" SERVICE SADDLE : SEE C.23

- 1" CORPORATION STOP: SEE C.22 (AWWA TAPERED THREAD)
- 1" COPPER TUBBING (TYPE "K"): SEE C.13

SEE C.19

- 4. 1" ANGLE VALVE: SEE C.18 5. 1" EXPANSION CONNECTION: SEE C.20
- 6. 1" NEPTUNE T-10 WATER METER W/E-CODER R900 I REGISTER AND RADIO TRANSMITTÉR
- (FURNISHED AND INSTALLED BY SFC UTILITIES) 7. 1" ANGLE CARTRIDGE W/DUAL CHECK VALVE:


- 1" CAST IRON METER YOKE: SEE C.17
- 24" DIA. X 36" METER BOX: SEE C.15
- 10. POLYMER LID (12-5/16" DIA.): SEE C.16
- 11. BLOCKS USE AS DIRECTED BY SFC UTILITIES 12. INNER ALUMINUM FROST LID: SEE C.16
- 13. DOUBLE LID COVER: SEE C.16 (20" DIA. X 11-1/2" DIA. INNER OPENING) WITH EXTENSION RING (20" DIA. 24" DIA.)
- 14. 1" COPPER TUBING (TYPE "K"): SEE C.13

10" 18" STANDARD CLASS 12" 22" STANDARD CLASS 14" 26" SCHEDULE 20 16" 28" SCHEDULE 20 20" 30" 0.375" WALL 24"

CARRIER PIPE

(NOMINAL SIZE)

3/4"-2" CU TUBING

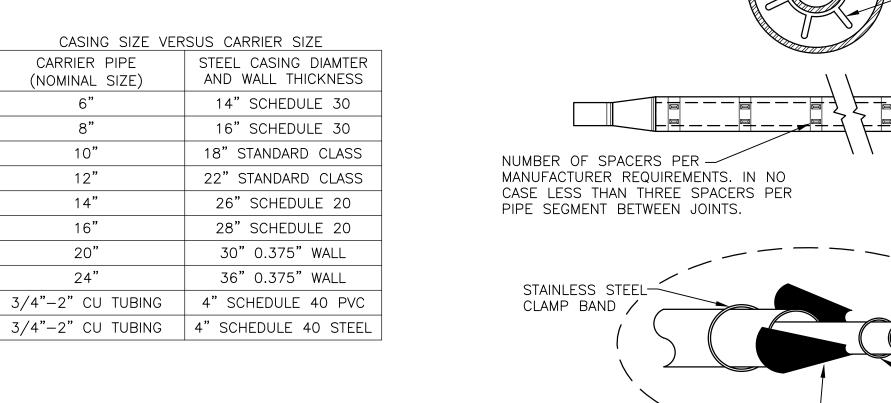

RUBBER CASING SEAL-PER SPECIFICATIONS

MOLZENCORBIN

STEEL CASING

- CARRIER PIPE

SPECIFICATIONS

CASING SPACER PER


STAINLESS STEEL CLAMP BAND

2701 Miles Road SE Albuquerque, New Mexico 87106 505 242 5700 office 505 242 0673 fax MolzenCorbin.com

NOTE: SEE APPROVED CONSTRUCTION PLANS FOR SERVICE LOCATION DETAIL FOR PLACEMENT DIMENSIONS AND DIRECTIONS.

NOTE: DETAILS ON THIS SHEET ARE REFERENCED FROM THE SANTA FE COUNTY WATER UTILITIES WATER AND SEWER CONSTRUCTION STANDARDS AND SPECIFICATIONS. REFER TO PROJECT MANUAL. APPENDIX E.

PIPE CASING DETAIL FOR WATER OR SEWER PROJECTS NOT TO SCALE

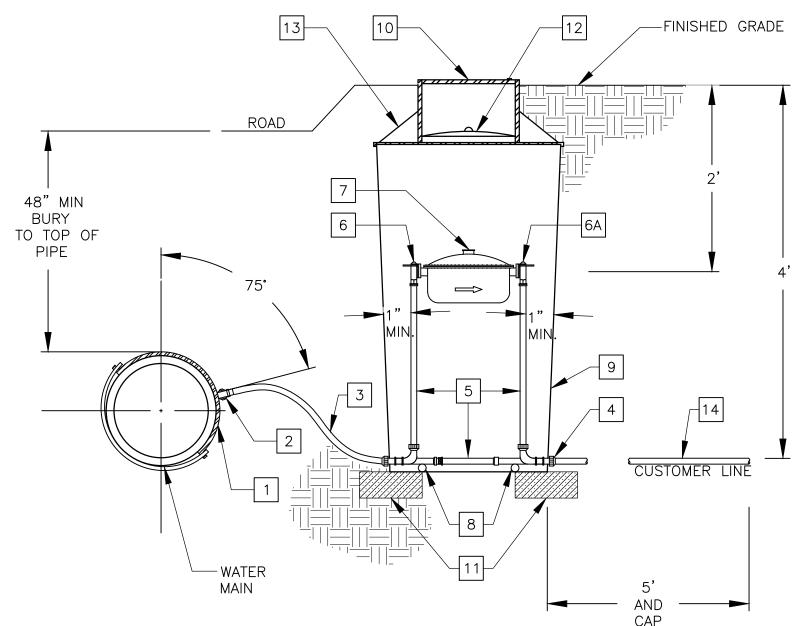

2" SINGLE SERVICE DETAIL

2" SERVICE SADDLE : SEE C.23 2" CORPORATION STOP: SEE C.22

(AWWA TAPERED THREAD)

- 2" COPPER TUBBING (TYPE "K"): SEE C.13
- 2" ADAPTER COUPLING
- 5. 2" PREFABRICATED METER SETTER
- (NO BY-PASS): SEE C.21
- 2" BALL ANGLE VALVE: SEE C.18 6A. 2" ANGLE CARTRIDGE W/DUAL CHECK VALVE: SEE C.19
- 2" NEPTUNE T-10 WATER METER C/E-CODER R900i REGISTER AND RADIO TRANSMITTER (FURNISHED & INSTALLED BY SFC UTILITIES)
 - 1" GALVANIZED PIPE 24" LONG
 - 36" DIA. X 36" METER BOX: SEE C.15
 - 10. 20" DIA. POLYMER LID: SEE C.16
 - 11. BLOCKS USE AS DIRECTED BY SFC UTILITIES
 - 12. INNER METAL FROST LID: SEE C.16
 - 13. 36" DIA. X 20" DOUBLE LID COVER: SEE C.16
 - 14. 1" COPPER TUBBING (TYPE "K"): SEE C.13

2" SINGLE SERVICE DETAIL



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REVISION

SYMBOL:	DATE:	BY:



PROJECT NAME:

OLD SANTA FE TRAIL **ROAD IMPROVEMENTS** AND

WATERLINE TL2N

MISCELLANEOUS UTILITY **DETAILS**

APPROVED: R.GEORGE | REVIEWED: SM DATE: NOV., 2014

W-504 DRAWN BY: J.MARTINEZ

JOINT RESTRAINT TABLE

TABLE: THIS TABLE IS BASED ON THE EBAA IRON MEGA LUG JOINT CALCULATIONS PROGRAM WITH THE FOLLOWING INPUT CRITERIA: 3.5FT DEPTH OF BURY (CONSERVATIVE); TRENCH TYPE 4: PVC PIPE MATERIAL: GM SOIL TYPE: 150 PSI TEST PRESSURE: 1.5 SAFETY FACTOR. SPECIFIC CALCULATIONS FOR RESTRAINED LENGTHS ARE REQUIRED FOR CONDITIONS NOT COVERED BY THIS TABLE.

LR: LENGTH OF RESTRAINED PIPE, IN FEET, FOR EACH SIDE OF THE FITTING.


MINIMUM RESTRAINED LENGTH: A MINIMUM RESTRAINED LENGTH OF 5 FT. FROM THE FITTING JOINT IS RECOMMENDED. VERTICAL OFFSETS SHALL BE COMPLETELY RESTRAINED BETWEEN THE TOP VERTICAL FITTING AND THE BOTTOM VERTICAL FITTING.

FJO: FITTING JOINT ONLY - THIS INCLUDES AT LEAST A 1 FT. LENGTH OF RESTRAINED PIPE BEYOND THE FITTING JOINT.

VERTICAL OFFSET: USE 11-1/2° BENDS OR 22-1/2" BENDS WHEREVER POSSIBLE DUE TO THE SHORTER RESTRAINED LENGTH REQUIREMENTS.


CAPS/PLUGS: CONCRETE BLOCKING MAY BE REQUIRED BY SFC UTILITIES ON A CASE-BY-CASE BASIS IN ADDITION TO MECHANICAL RESTRAINT.

PIPE LENGTH: PIPING SHALL BE LAID OUT TO MINIMIZE PIPE JOINTS NEAR FITTINGS. WHEREVER POSSIBLE, FULL 20 FT. PIPE LENGTHS SHALL BE UTILIZED WHEN CONNECTING TO FITTINGS OR VALVES. NO PIPE BELL JOINTS SHALL BE USED WHERE FITTINGS ARE LESS THAN 20 FT. APART.

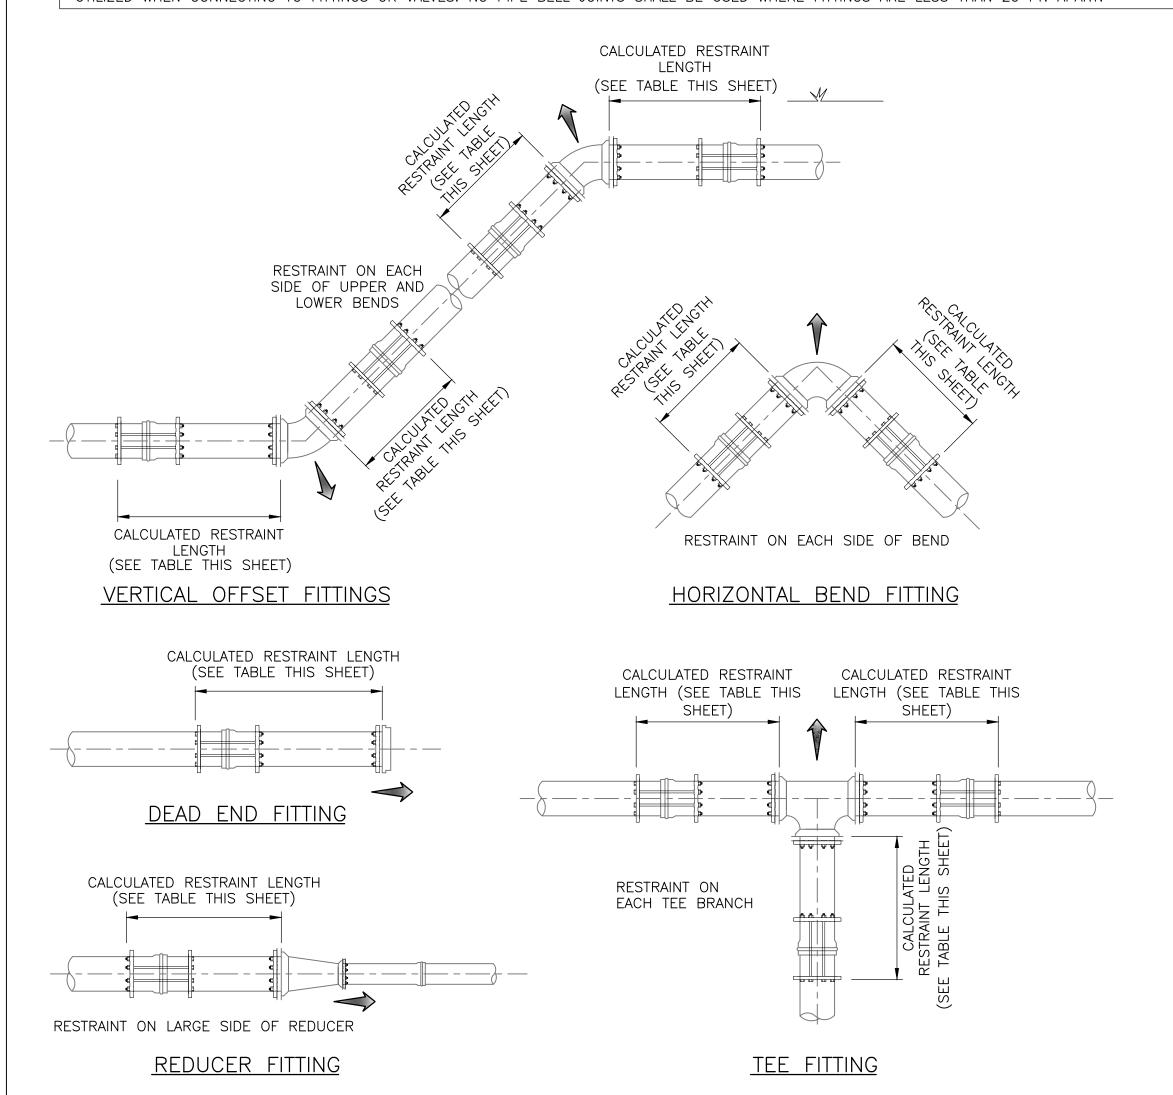


PIPE RESTRAINT REQUIREMENTS


SCALE: NONE

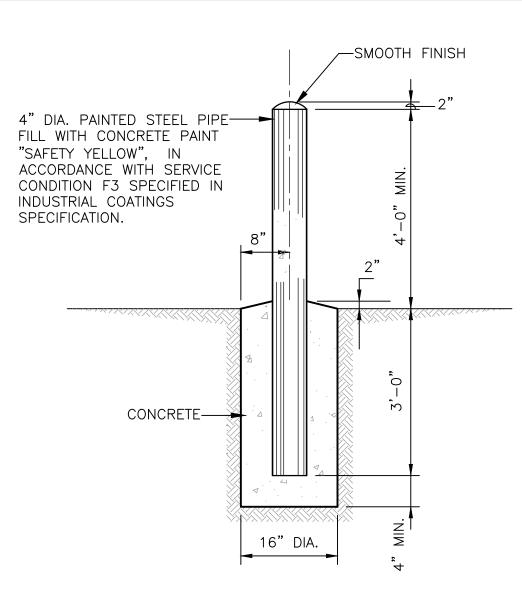



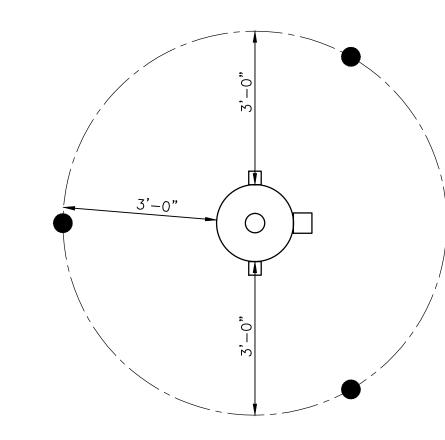

PIPE BOLLARD LAYOUT DETAIL

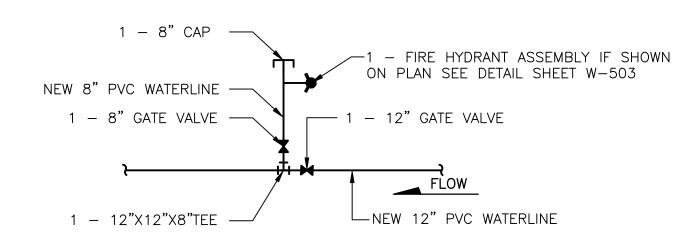

TYPICAL CONNECTION DETAIL SCALE: NONE REFER TO PLAN AND PROFILE SHEETS FOR STUBOUT LENGTHS AND ORIENTATION

CAUTION:
NOTE THAT SANITARY SEWER, GAS AND OTHER UTILITIES ARE NOT SHOWN. EXISTING SERVICE CONNECTIONS ARE NOT SHOWN. ANY EXISTING UTILITIES THAT ARE SHOWN ARE SHOWN IN APPROXIMATE LOCATION ONLY. IT SHALL BE THE RESPONSIBILITY OF THE CONTRACTOR TO CONTACT ALL THE UTILITY OWNERS AND TO CONDUCT ALL NECESSARY FIELD INVESTIGATIONS PRIOR TO ANY EXCAVATION TO DETERMINE THE ACTUAL LOCATION OF UTILITIES AND OTHER IMPROVEMENTS.

NOTE:

CONNECTION DETAILS ARE FOR GENERAL INFORMATION.
RESTRAIN ALL VALVES AND FITTINGS WITH JOINT
RESTRAINT DEVICES. SEE JOINT RESTRAINT
REQUIREMENTS THIS SHEET.



MOLZENCORBIN

2701 Miles Road SE

Albuquerque, New Mexico 87106 505 242 5700 office

505 242 0673 fax

MolzenCorbin.com

NOTICE OF EXTENDED PAYMENT PROVISION:
THIS CONTRACT ALLOWS THE OWNER TO MAKE
PAYMENT WITHIN 45 DAYS AFTER SUBMISSION

REVISION

OF AN UNDISPUTED REQUEST FOR PAYMENT

SYMBOL:	DATE:	BY:



PROJECT NAME:


OLD SANTA FE TRAIL ROAD IMPROVEMENTS AND WATERLINE TL2N


WATERLINE CONNECTION
& JOINT RESTRAINT DETAILS

APPROVED: R.GEORGE REVIEWED: SM

DATE: NOV., 2014 SHEET:

DRAWN BY: J.MARTINEZ W-505

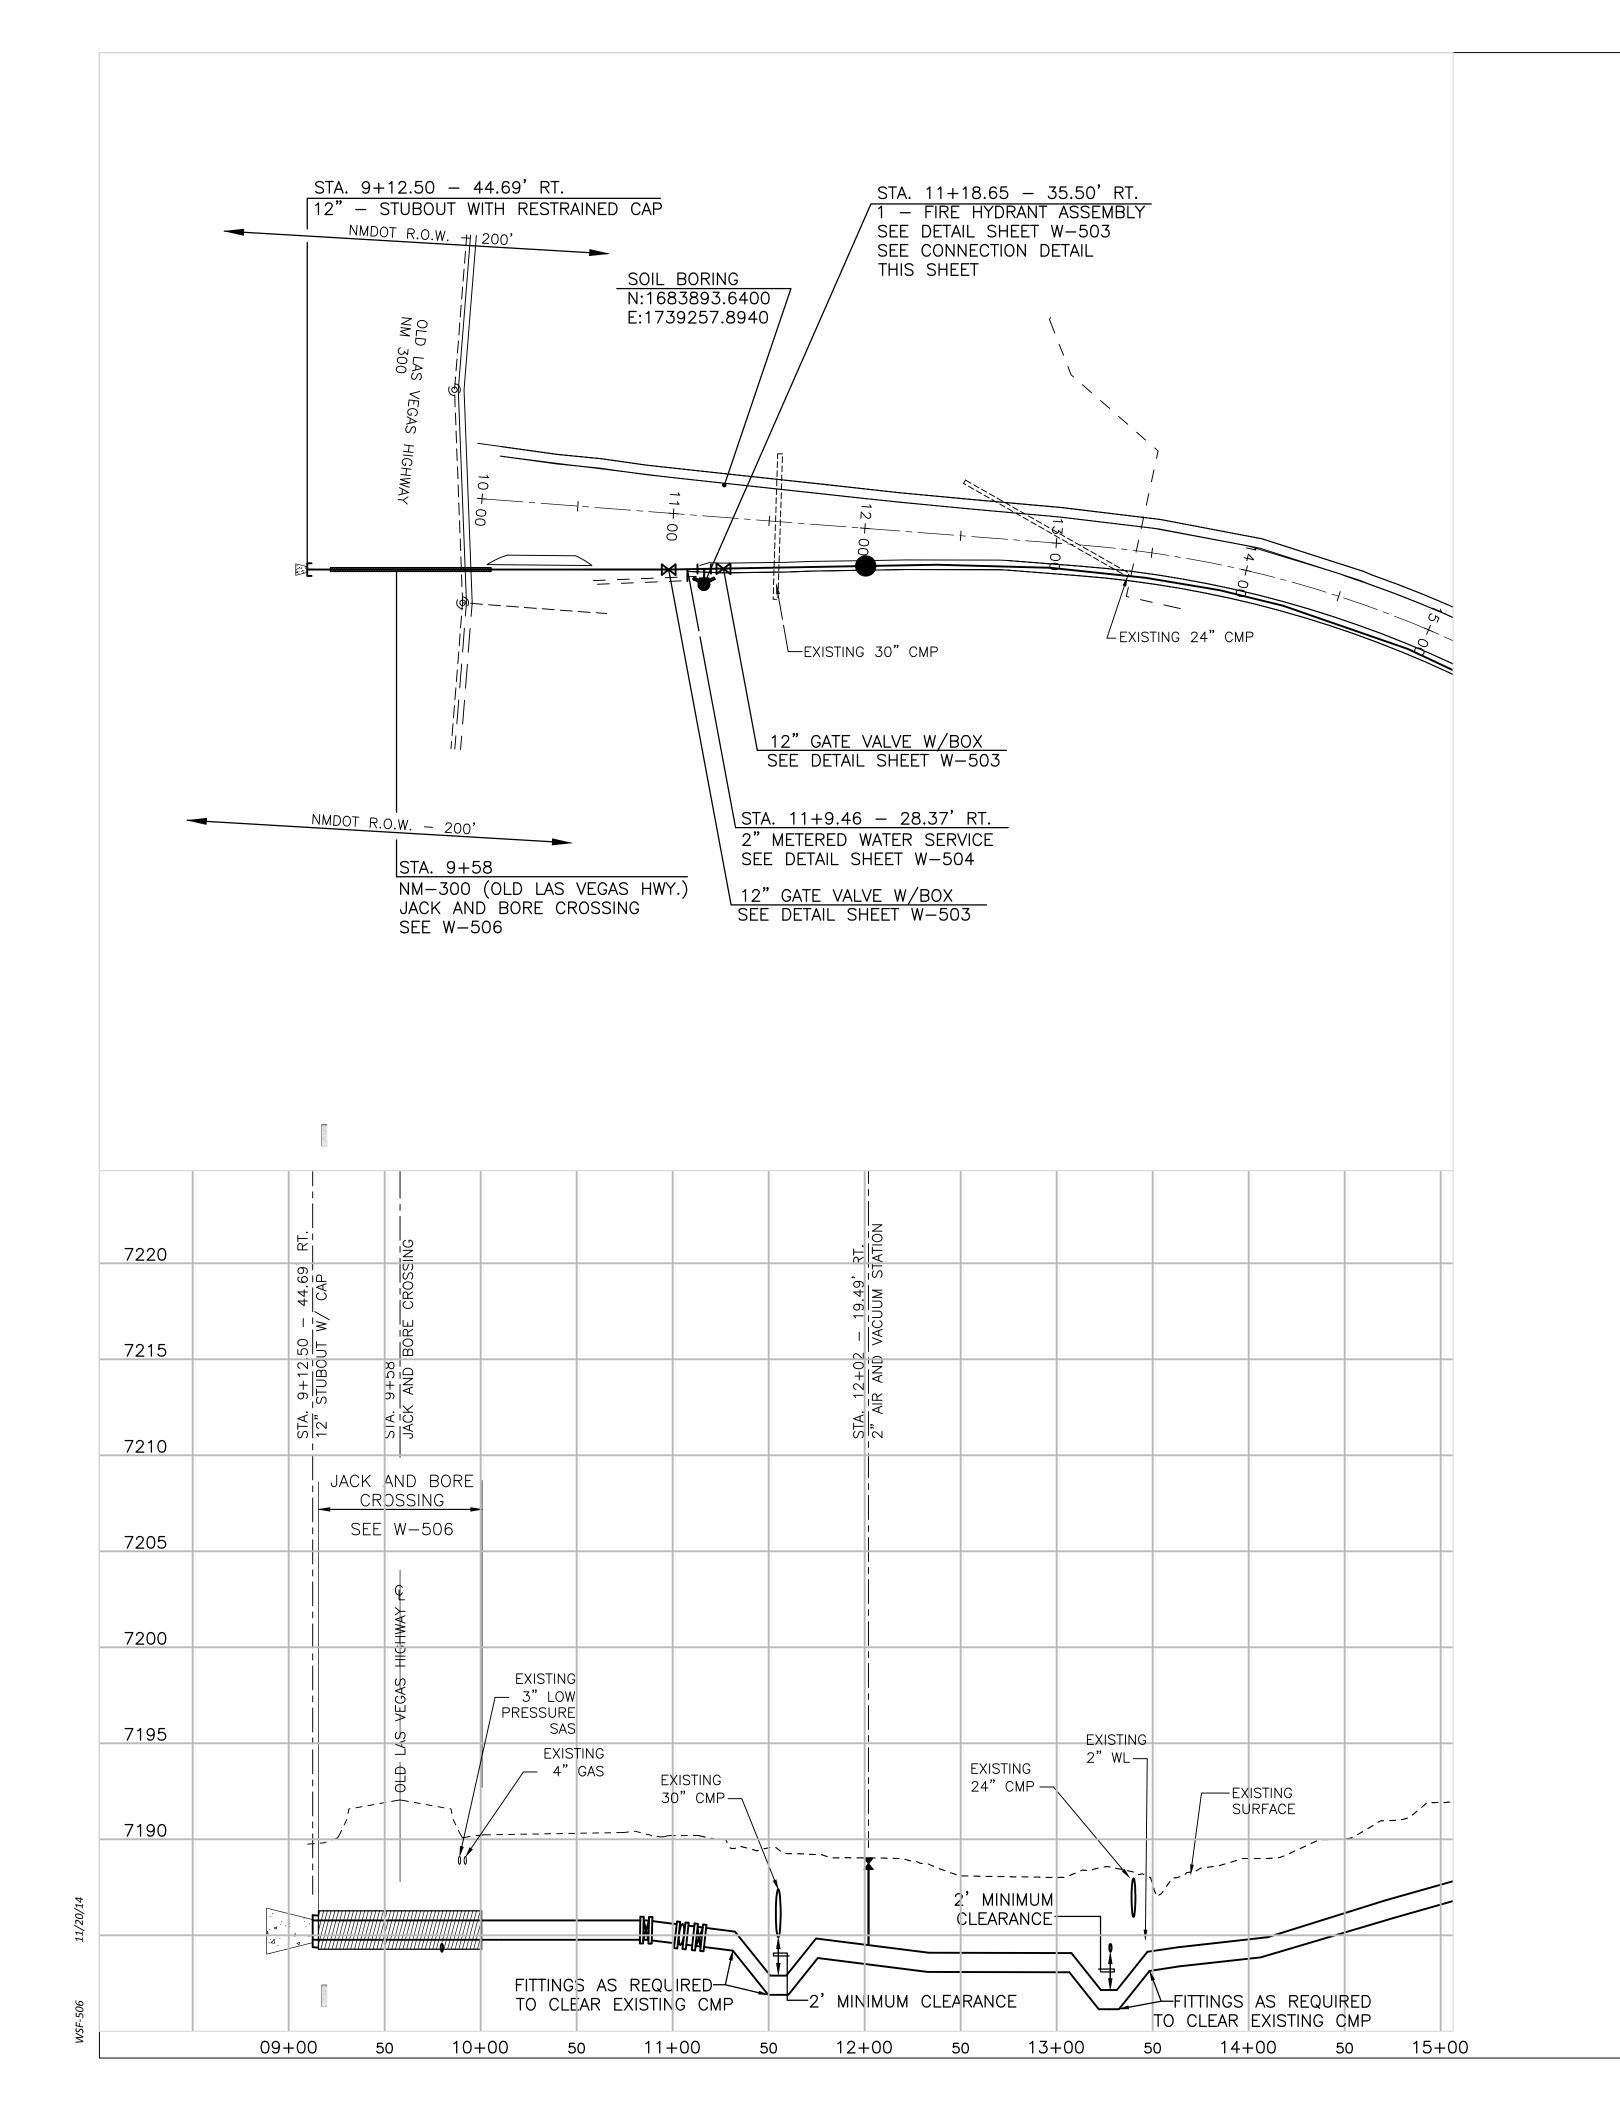

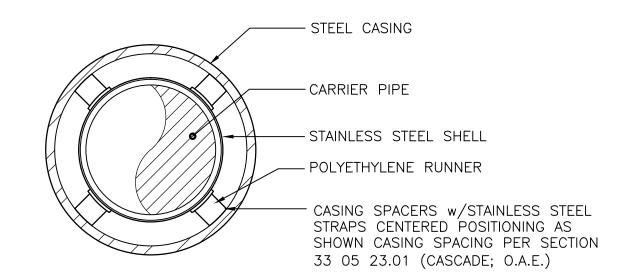


TYPICAL FOR ALL JACK AND BORE INSTALLATIONS

CASING SPACER DETAIL (SECTION THRU SPACER)

SCALE: NONE

REFER TO SECTION 33 05 23.01 - JACK AND BORING FOR REQUIREMENTS

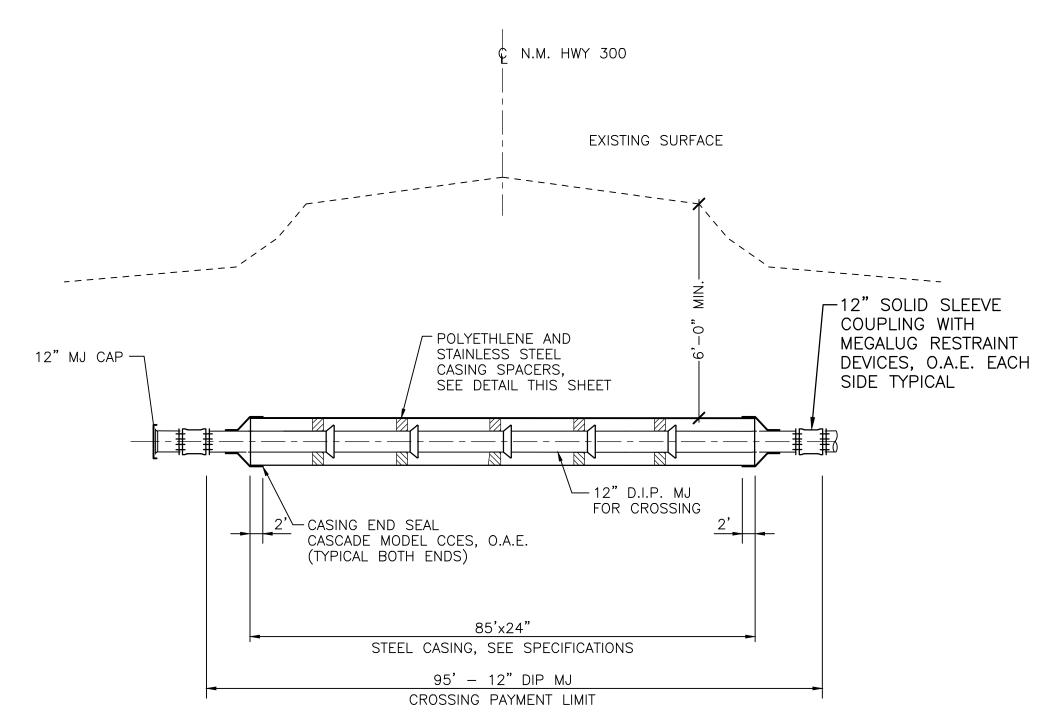

N.M. HIGHWAY 300 CROSSING
SCALE: NONE

MOLZENCORBIN

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Albuquerque, New Mexico 87106
505 242 5700 office
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SYMBOL:	DATE:	BY:	



PROJECT NAME:
OLD SANTA FE TRAIL

ROAD IMPROVEMENTS AND WATERLINE TL2N


NM-300 JACK AND BORE CROSSING DETAIL

APPROVED: R.GEORGE | REVIEWED: SM

DATE: NOV., 2014 | SHEET


DATE: NOV., 2014 SHEET:

DRAWN BY: J.MARTINEZ W-506

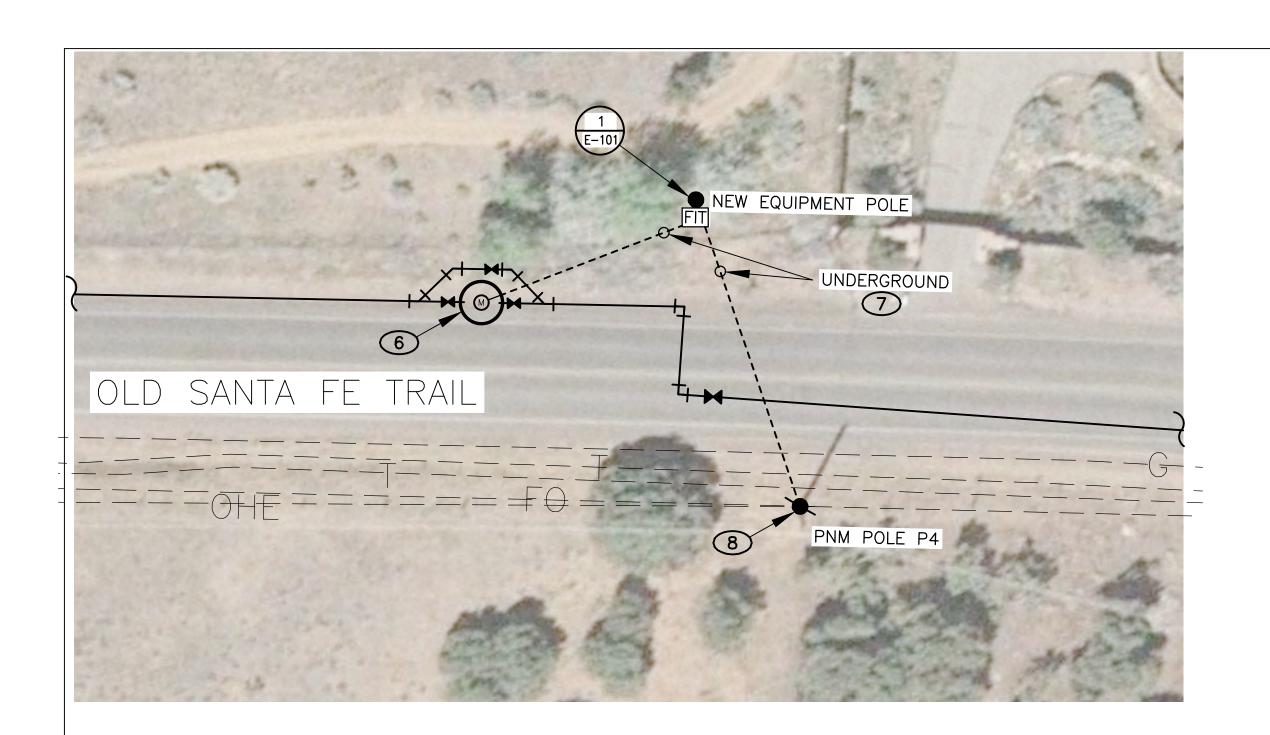

WELL SITE ELECTRICAL PLAN SCALE: N.T.S.



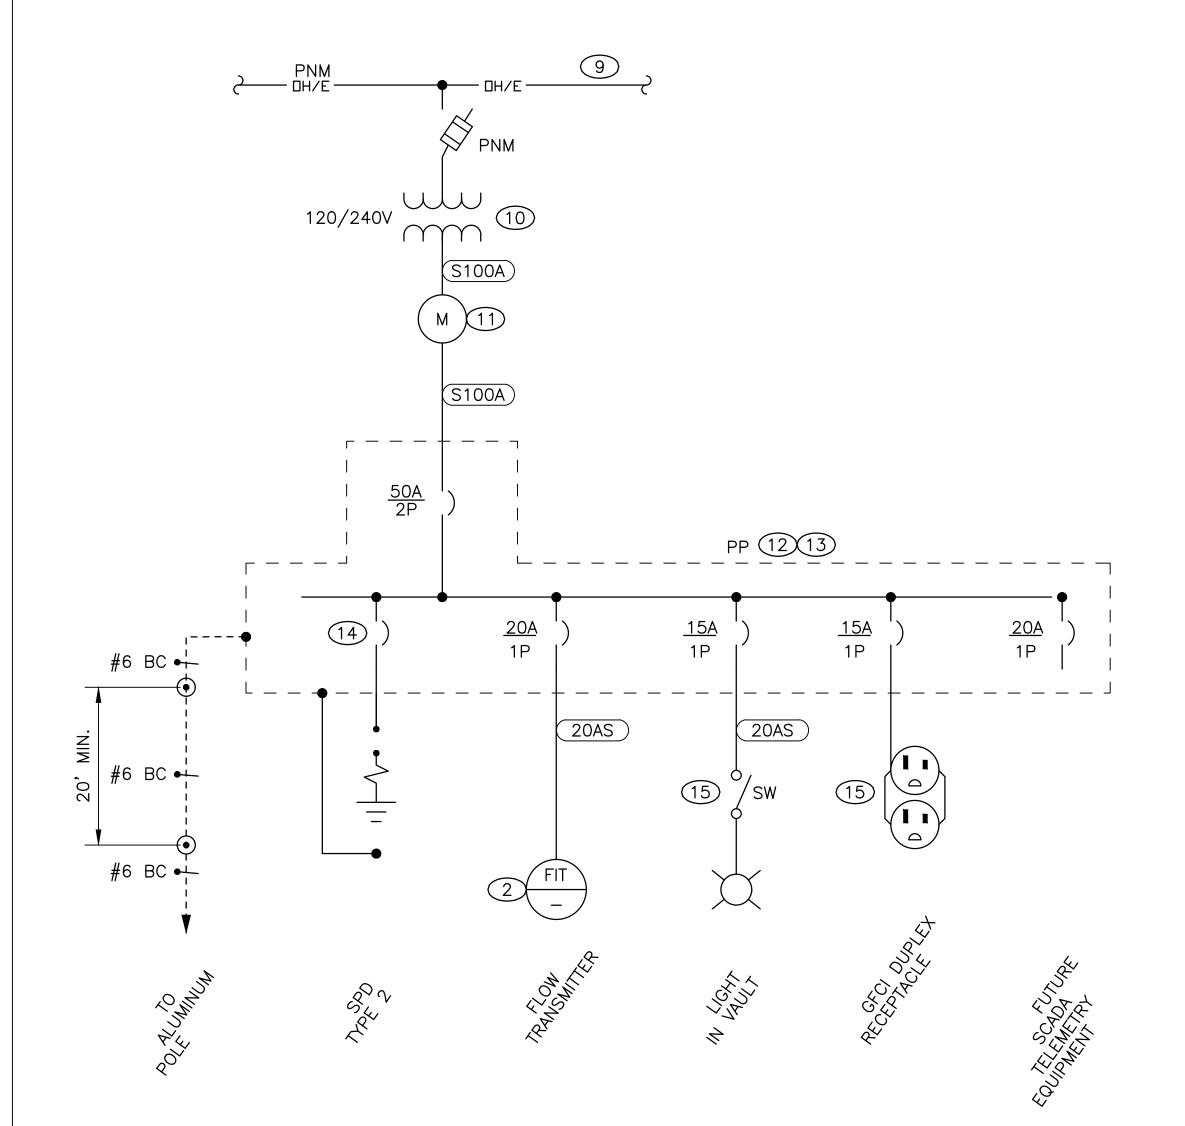

ONE-LINE DIAGRAM

SCALE: N.T.S.



-CAST ALUM. POLE CAP WITH STAINLESS STEEL SCREWS

-.188" WALL ALLOY 6063-T6

SATIN GROUND FINISH

-HANDHOLE WITH OUTLET

`----- TO PP

BOX OPTION (3)

∠ 6" BUTT DIA.

	TOWN		SCHEDULE
NIANAT	QTY OF	MINIMUM	CONDUCTORS, EACH
NAME	CONDUITS	CONDUIT	CONDUIT
	COMBOITS	SIZE	COMBOTT
20AS	1	3/4"	#12H, #12N, #12G
100WN	1	2"	3 - #1, #2N, #6G

4.5" TOP DIA.

2

4

SERVICE CONDUIT SCHEDULE			
NAME		MINIMUM CONDUIT SIZE	CONDUCTORS, EACH CONDUIT
S100A	1	2"	2 - #2, #2N

CONDUI	T MATRIX				
	RMC	RNC	EMT	FMC	LFMC
BELOW FINISHED GRADE (HORIZONTAL RUNS)	Υ	Υ			
BELOW FINISHED GRADE (VERTICAL AND 90°)	Υ	-			
EXTERIOR WHERE EXPOSED	Υ				
ALL OTHER WORK	Υ				
LEGEND:					
Y: CONDUIT TYPE ALLOWED					

CONNECTED LOAD	1	KVA
DEMAND LOAD	1	KVA
AVAILABLE FAULT	10	KVA

GENERAL NOTES

- REFER TO W-501 FOR ADDITIONAL METER VAULT DETAILS.
 - COORDINATE WITH PNM FOR NEW 120/240V SERVICE. USE PNM APPROVED EQUIPMENT. PERFORM ALL WORK IDENTIFIED AS THE CUSTOMERS RESPONSIBILITY.

MOLZENCORBIN

2701 Miles Road SE Albuquerque, New Mexico 87106 505 242 5700 office 505 242 0673 fax MolzenCorbin.com

KEYED NOTES

- ALUMINUM, DIRECT BURY POLE WITH BREAKAWAY OPTIONS ACCEPTED BY THE FEDERAL HIGHWAY ADMINISTRATION (FHWA). PROVIDE FEATURES AS IDENTIFIED ON THE DRAWING. HAPCO, ALUMINUM POLE PRODUCTS, OR ENGINEER REVIEWED EQUIVALENT. HANDHOLE TO FACE SOUTH. SHOWN HERE FOR DRAFTING PURPOSES. VERIFY LOCATION WITH ENGINEER IN FIELD PRIOR CONSTRUCTION. USED AS WIREWAY FOR CONDUCTORS AND CABLES.
- 2) FLOW TRANSMITTER TO BE MOUNTED ON NORTH SIDE OF THE POLE. MOUNT AT NOMINAL 36" TO AFG. INSTALL TRANSMITTER IN NEMA 3R HINGED LOCKABLE
- 3 OUTLET BOX PROVIDED BY POLE MANUFACTURE. ADD
- (4) GROUND TERMINAL PART OF POLE ASSEMBLY.
- 5 BOND GROUND ROD TO POLE WITH #6 BC.
- 6 PENETRATE VAULT FOR THE CONDUIT AND SEAL AROUND CONDUIT WITH NONMETALLIC GROUT. PULL FACTORY CABLE SUPPLIED WITH FLOW METER TO FLOW
- MINIMUM 36" DEPTH FOR UNDERGROUND CONDUITS PER PNM STANDARDS. UNDERGROUND CONDUIT ROUTING SHOWN IS ILLUSTRATIVE ONLY. SHOW ACTUAL ROUTING
- 8 CONSTRUCT SERVICE RISER IN ACCORDANCE WITH PNM
- (10) TRANSFORMER SUPPLIED AND INSTALLED BY PNM.
- (11) INSTALL METER ENCLOSURE WITH SOCKET. PROVIDE PNM
- 13 POWER PANEL IN NEMA 3R ENCLOSURE. 120/240V, 100A, 2P, 3 WIRE, WITH 22KAIC RATING. INSTALL NAMEPLATES NEXT TO CIRCUIT BREAKER TO IDENTIFY SPECIFIC UNIT SERVED.
- (14) SIZE CIRCUIT BREAKER AS RECOMMENDED BY SPD



NOTICE OF EXTENDED PAYMENT PROVISION: HIS CONTRACT ALLOWS THE OWNER TO MAKE PAYMENT WITHIN 45 DAYS AFTER SUBMISSION OF AN UNDISPUTED REQUEST FOR PAYMENT

REVISION

DATE:	BY:
	DATE:



PROJECT NAME:

DRAWN BY: NW

OLD SANTA FE TRAIL ROAD IMPROVEMENTS AND

ELECTRICAL SITE PLAN NEW MASTER METER VAULT

E-101

WATERLINE TL2N

APPROVED: R.RODKE | REVIEWED: DG DATE: NOV., 2014

ENCLOSURE.

BOX EXTENSION IF NECESSARY.

TRANSMITTER. CONNECT TO TRANSMITTER.

ON AS-BUILT DRAWINGS.

STANDARDS.

9 PNM PRIMARY OVERHEAD.

APPROVED MATERIAL.

(12) INSTALL METER AND POWER PANEL (PP) PER PNM STANDARD MS-5-3.0.

MANUFACTURER.

(15) LOCATED IN METER VAULT.