

SANTA FE RIVER **GREENWAY PROJECT** (SECTION B)

SANTA FE COUNTY

SANTA FE

150 Washington Avenue, Suite 201 Santa Fe, New Mexico 87501 T 505.855.7500

SUBCONSULTANTS

GEOTECHNICAL TERRACON T 505.797.4287

LANDSCAPE ARCHITECTURE DESIGN OFFICE T 505.983.1415

TOPOGRAPHIC MAPPING COOPER AERIAL SURVEYS CO. T 602.678.5111

SUBSURFACE UTILITY ENGINEERING COLLIERS ENGINEERING & DESIGN T 505.228.3154

REGISTRATION



ISSUE/REVISION

I/R DATE DESCRIPTION

KEY PLAN

PROJECT NUMBER

SHEET TITLE

RETAINING WALL 3 PLAN AND PROFILE


SHEET NUMBER

5 - 14

1				SCHEDUL	
MARK	SIZE	TYPE	LENGTH	No. REQ'D	REMARKS
	NO. 1 DRILLE				
#4DS1	4	6	10'-5"	190	TRANS. (95 EA. SHAFT)
#9DS2	9	1	47'-9"	32	LONG. (16 EA. SHAFT)
	NO. 1 CAP (1)				
#4AC1	4	1	18'-8"	6	LONG.
#4AC2	4	1	4'-6"	16	LONG.
#5AC3	5	4	15'-9"	20	TIES
#5AC4	5	7	7'-8"	20	TIES (a=1'-0", b=3'-4")
#7AC5	7	5	29'-0"	8	LONG. (a&c=1'-3", b=26'-6")
#8AC6	8	1	18'-8"	16	LONG. (8 TOP & BOT.)
ABUTMENT	NO.1 BACKV	VALL			
#4AB1	4	7	7'-8"	20	TIES (a=1'-0", b=3'-4")
#4AB2	4	1	24'-8"	7	LONG.
#7AB3	7	5	29'-0"	7	LONG. (a&c=1'-3", b=26'-6")
ABUTMENT	NO. 1 WINGW	ALLS			
#4WH1	4	3	5'-0"	30	COR. BARS (a=2'-6", b=2'-6
#4WH2	4	1	13'-8"	30	HOR. N.F. (15 PER WW)
#5WV1*	5	1	7'-3"	66	VERT. E.F. (33 PER WW)
#7WH3	7	3	15'-9"	30	HOR. F.F. (a=1'-3", b=14'-6"
ABUTMENT	NO. 2 DRILLE	D SHAFTS			
#4DS1	4	6	10'-5"	190	TRANS. (95 EA. SHAFT)
#9DS2	9	1	47'-9"	32	LONG. (16 EA. SHAFT)
ABUTMENT	NO. 2 CAP				
#4AC1	4	1	18'-8"	6	LONG.
#4AC2	4	1	4'-6"	16	LONG.
#5AC3	5	4	15'-9"	20	TIES
#5AC4	5	7	7'-8"	20	TIES (a=1'-0", b=3'-4")
#7AC7	7	7	27'-2"	8	LONG. (a&c=1'-3", b=24'-8"
#8AC6	8	1	18'-8"	16	LONG. (8 TOP & BOT.)
ABUTMENT	NO. 2 BACKV	VALL		'	
#4AB1	4	7	7'-8"	20	TIES (a=1'-0", b=3'-4")
#4AB2	4	1	24'-8"	7	LONG.
#7AB4	7	7	27'-2"	7	LONG. (a&c=1'-3", b=24'-8"
#7AB5	7	5	7'-6"	28	H. FILLET (a&c=1'-3", b=5'-0
ABUTMENT	NO. 2 WINGW	ALLS			· · · · · · · · · · · · · · · · · · ·
#4WH4	4	2	5'-0"	30	COR. BARS (a=2'-6", b=2'-6
#4WH2	4	1	13'-8"	30	HOR. N.F. (15 PER WW)
#5WV1*	5	1	7'-0"	64	VERT. E.F. (32 PER WW)
#7WF1	7	1	6'-6"	6	V. FILLET (3 PER WW)
#7WH5	7	2	15'-9"	30	HOR. F.F. (a=1'-3", b=14'-6"
DECK SLAB		_			
	4	1	11'-8"	214	DECK TRANS. @ 9" SPA.
#4DT1					

' = HEIGHT VARIES. BAR LENGTH SHOWN IS NOMINAL

BAR BENDING DIAGRAM

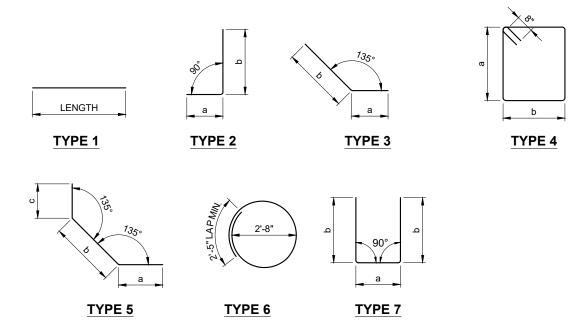

NOTES:

- 1. DIMENSIONS SHOWN ARE TO "OUT-TO-OUT" OF BARS.
- 2. ALL REBAR LAP SPLICES SHALL BE AS SHOWN BELOW UNLESS OTHERWISE NOTED.

3 KSI CONCRETE BLACK REINFORCEMENT LAP SPLICE TABLE

SIZE: BAR LAP:	
No. 4 2'-5"	
No. 5 3'-1"	
No. 6 3'-7"	
No. 7 4'-2"	
No. 8 5'-2"	
No. 9 6'-6"	
No. 10 8'-3"	

AECOM

PROJECT

SANTA FE RIVER **GREENWAY PROJECT** (SECTION B)

CLIENT

SANTA FE COUNTY

www.santafecountynm.gov

SANTA FE 100 Catron St. Santa Fe, New Mexico 87501 T 505.986.6200

ENGINEERING CONSULTANT

150 Washington Avenue, Suite 201 Santa Fe, New Mexico 87501 T 505.855.7500 www.aecom.com

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TOPOGRAPHIC MAPPING COOPER AERIAL SURVEYS CO. T 602.678.5111

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REGISTRATION



ISSUE/REVISION

I/R	DATE	DESCRIPTION

KEY PLAN

PROJECT NUMBER

357-7708

SHEET TITLE

BID ALT. #1 PEDESTRIAN BRIDGE REINFORCING BAR SCHEDULE

SUGGESTED SEQUENCE OF CONSTRUCTION

CONSTRUCTION NOTES:

- 1. THE CONTRACTOR SHALL MAINTAIN ACCESS TO PRIVATE PROPERTIES AT ALL TIMES.
- 2. THE CONTRACTOR SHALL CONSTRUCT PHASES II-A AND II-B SIMULTANEOUSLY, ALTERNATING FROM ONE SIDE TO THE OTHER, LIMITING THE VERTICAL DIFFERENCE BETWEEN EACH SIDE TO 8" MAXIMUM.
- 3. AT THE END OF EACH WORKDAY, TRAFFIC MUST BE OPENED TO TWO-WAY TRAFFIC ON ALL ROADWAYS INCLUDING PASADA SAN JUAN. THE CONTRACTOR SHALL ENSURE THAT THE FOLLOWING CONDITIONS ARE MET PRIOR TO OPENING THE ROADWAY TO TRAFFIC:
 - a. THE VERTICAL DIFFERENCE BETWEEN EACH SIDE IS NOT MORE THAN 3" OR,
 - b. IF THE VERTICAL DIFFERENCE IS GREATER THAN 3", A 3:1 TAPER IS CONSTRUCTED BETWEEN THE TWO SIDES. THE MAXIMUM TAPER WIDTH

PHASE I:

TRAFFIC:

INSTALL TRAFFIC CONTROL DEVICES AND SIGNAGE FOR SHOULDER OPERATIONS ALONG SAN YSIDRO CROSSING, CAMINO DOS ANTONIOS, VER SAN ANTONIO, AND SILER ROAD PER SHEETS 6-2 THRU 6-5. MAINTAIN TRAFFIC CONTROL DEVICES AND SIGNAGE THROUGHOUT PHASES II AND III.

PHASE II:

CONSTRUCT PASADA SAN JUAN TO FINAL GRADE, UTILIZING A ONE LANE CLOSURE OPERATION, ALTERNATING LEFT AND RIGHT SIDES FOR 8" MAX DROP OFF. COMPLY WITH PAVEMENT DROP OFF GUIDELINES PRIOR TO OPENING THE ROADWAY TO TRAFFIC. COMPLETE ALL SUBGRADE CONSTRUCTION BEFORE PROCEEDING WITH BASE COURSE. COMPLETE ALL BASE COURSE CONSTRUCTION BEFORE PROCEEDING WITH ASPHALT PAVEMENT.

PHASE II-A (LEFT SIDE):

DURING CONSTRUCTION HOURS, MAINTAIN 1-LANE, 2-WAY TRAFFIC IN THE EASTBOUND LANE USING FLAGGER OPERATIONS TO REGULATE TRAFFIC. AT THE END OF EACH WORKDAY, OPEN ROADWAY TO 2-LANE, 2-WAY TRAFFIC USING THE NON-CONSTRUCTION HOURS TRAFFIC CONTROL PLAN.

CONSTRUCT THE PASADA SAN JUAN WESTBOUND LANE. BUILD ROADWAY SUBGRADE TO FINAL GRADE. BUILD ROADWAY BASE COURSE TO FINAL GRADE. BUILD HEADER CURB. BUILD ASPHALT PAVEMENT TO FINAL GRADE.

PHASE II-B (RIGHT SIDE):

DURING CONSTRUCTION HOURS, MAINTAIN 1-LANE, 2-WAY TRAFFIC IN THE WESTBOUND LANE USING FLAGGER OPERATIONS TO REGULATE TRAFFIC. AT THE END OF EACH WORKDAY, OPEN ROADWAY TO 2-LANE, 2-WAY TRAFFIC USING THE NON-CONSTRUCTION HOURS TRAFFIC CONTROL PLAN.

CONSTRUCT THE PASADA SAN JUAN EASTBOUND LANE. BUILD ROADWAY SUBGRADE TO FINAL GRADE. BUILD ROADWAY BASE COURSE TO FINAL GRADE. BUILD CURB AND GUTTER. BUILD ASPHALT PAVEMENT TO FINAL GRADE.

PHASE III:

TRAFFIC:

INSTALL TRAFFIC CONTROL DEVICES ALONG SOUTH SIDE OF NEWLY CONSTRUCTED PASADA SAN JUAN FOR A SHOULDER OPERATION. PERMANENTLY CLOSE TWO LOW WATER CROSSINGS AT CAMINO DOS ANTONIOS AND VER SAN ANTONIO.

CONSTRUCT RIVER GRADING AND BOULDER STRUCTURES. CONSTRUCT THE SANTA FE RIVER TRAIL BETWEEN SAN YSIDRO CROSSING AND SILER ROAD. CONSTRUCT TRAILHEAD PARKING, AND ANY REMAINING PORTIONS OF PROJECT BETWEEN SAN YSIDRO CROSSING AND SILER ROAD.

PHASE IV:

TRAFFIC:

UTILIZING PHASE II TRAFFIC CONTROL PLAN. DURING CONSTRUCTION HOURS, MAINTAIN 1-LANE, 2-WAY TRAFFIC USING FLAGGER OPERATIONS TO REGULATE TRAFFIC. AT THE END OF EACH WORKDAY, OPEN ROADWAY TO 2-LANE, 2-WAY TRAFFIC USING THE NON-CONSTRUCTION HOURS TRAFFIC CONTROL PLAN.

CONSTRUCTION:

CONSTRUCT CURB & GUTTER AND ASPHALT PAVEMENT ALONG SAN YSIDRO CROSSING.

PHASE V:

INSTALL TRAFFIC CONTROL DEVICES AND SIGNAGE FOR SHOULDER OPERATIONS AS APPROPRIATE.

CONSTRUCTION:

INSTALL PERMANENT SIGNING AND STRIPING.

TRAFFIC CONTROL INDEX OF SHEETS

SHEET No.	DESCRIPTION
6-1	TRAFFIC CONTROL SUGGESTED SEQUENCE OF CONSTRUCTION
6-2 to 6-3	TRAFFIC CONTROL QUANTITIES
6-4	TRAFFIC CONTROL SAN YSIDRO CROSSING
6-5	TRAFFIC CONTROL AGUA FRIA STREET
6-6 to 6-7	TRAFFIC CONTROL SILER ROAD
6-8	TRAFFIC CONTROL PHASE II-A LEFT LANE CLOSURE
6-9	TRAFFIC CONTROL PHASE II-B RIGHT LANE CLOSURE
6-10	TRAFFIC CONTROL PHASE III

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KEY PLAN

PROJECT NUMBER

357-7708

SHEET TITLE

TRAFFIC CONTROL SUGGESTED SEQUENCE OF CONSTRUCTION

SUMMARY OF QUANTITIES TRAFFIC CONTROL ITEMS

ITEM No.	DESCRIPTION	UNITS	PHASEI	PHASE II	PHASEIII	USE
618000	TRAFFIC CONTROL MANAGEMENT	LS	L.S.	L.S.	L.S.	LS
702810	TRAFFIC CONTROL DEVICES FOR CONSTRUCTION	LS	L.S.	L.S.	L.S.	LS

ITEM No. 702810

ITEMIZED LIST OF TRAFFIC CONTROL DEVICES FOR CONSTRUCTION

ITEM No.	BID ITEM	UNITS	PHASE I SAN YSIDRO CROSSING	PHASE I AGUA FRIA STREET	PHASE I SILER ROAD	PHASE II-A CONSTR.	PHASE II-A NON- CONSTR.	PHASE II-B CONSTR.		PHASE III RIVER TRAIL & STRUCTS.	CONSTR	PHASE IV-A NON- CONSTR.	PHASE IV-B CONSTR.	PHASE IV-B NON- CONSTR.	USE
*	CONSTRUCTION SIGNING	S.F.	54	61	67	101	41	(101)	(99)	45	(101)	(99)	(101)	(99)	369
*	STEEL POSTS AND BASE POSTS FOR CONSTRUCTION SIGNING	L.F.	54	69	87	0	0	0	0	0	0	0	0	0	209
*	PORTABLE SIGN SUPPORT	EACH	0	0	0	12	8	(12)	(14)	5	(12)	(14)	(12)	(14)	25
*	BARRICADE TYPE II 3'	EACH	0	2	2	0	0	0	0	0	0	0	0	0	4
*	BARRICADE TYPE III 8'	EACH	0	0	0	1	0	(1)	0	0	(1)	0	(1)	0	1
*	CHANNELIZATION DEVICE, TYPE DRUM	EACH	28	9	22	62	0	(62)	0	(51)	(62)	0	(62)	0	121
*	VERTICAL PANEL, TYPE BACK TO BACK	EACH	0	0	0	0	78	0	(78)	(51)	0	(78)	0	(78)	78

^{*} FOR CONTRACTOR INFORMATION ONLY

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TRAFFIC CONTROL QUANTITIES

						MOU	NTING REQ	UIREMEN'	TS			CHANNELIZAT	TION DEVI	CES
	SIGN	NO. OF	TOTAL		PC	OST		BASE	POST	PORTABLE				VERTICAL
SIGN CODE	SIZE	SIGNS	SIGN AREA	LEFT	CENTER	RIGHT	TOTAL LENGTH	NO.	TOTAL LENGTH	SIGN SUPPORT	BARRICADE, TYPE II-36"	BARRICADE, TYPE III-96"	DRUMS	PANEL, TYPE BACK TO BACK
	S.F.	EACH	S.F.	L.F.	L.F.	L.F.	L.F.	EACH	L.F.	EACH	EACH	EACH	EACH	EACH
	PHASE I - SAN YSIDRO CROSSING													
CHANNELIZATION W20-1-36	DEVICE	2	18		11		11	2	7				28	
W24-NM-17-36	9	2	18		11		11	2	7	-				
W21-5-36	9	2	18		11		11	2	7					
SUBTOTAL:			54				33		21	0	0	0	28	0
PHASE I - AGUA FI	RIA STRE	ET												
CHANNELIZATION											2		9	
W20-1-36	9	3	27		11		11	3	11					
W24-NM-17-36 W21-5-36	9	2	18 9		11 11		11	2	7					
R9-11R-24	3	1	3		11		11	1	4					
R9-9-24	2	2	4		RICADE, T		0	0	0					
SUBTOTAL:			61				44		25	0	2	0	9	0
PHASE I - SILER R														
CHANNELIZATION											2		22	
W20-1-36	9	2	18		11		11	2	7					
W24-NM-17-36	9	2	18		11		11	2	7					1
W21-5-36 R9-11R-24	9	2	18 3		11		11	2	7					
R9-11R-24 R9-11L-24	3	2	6		11		11	2	7					1
R9-9-24	2	2	4		RICADE, T	YPE II	0	0	0					
SUBTOTAL:			67				55		32	0	2	0	22	0
PHASE II-A - LEFT			CONSTRU	ICTION H	ours									
CHANNELIZATION										T		1	62	
R2-1-24-25	5	4	20							4				
W20-4-36-1000 W3-4-36	9	2	18							2				
W3-4-36 W20-7-36	9	2	18 18							2				
G20-2-36	5	2	9		-					2				
R11-NM-2-48	10	1	10	BARR	RICADE, T	YPE III	**		**	-				
W1-6L-48	8	1	8	BARR	RICADE, T	YPE III	**		**					
SUBTOTAL:			101				0		0	12	0	1	62	0
PHASE II-A - LEFT			NON-CON	STRUCTI	ON HOUR	S					1	Ι		I
CHANNELIZATION R2-1-24-25	5	(4)	(20)							(4)				78
W20-1-36-750	9	2	18							2				
W8-3-36	9	2	18							2				
W8-15P-24	3	2	6	MOU	NT w/ W8	-3-36	**		**					
W6-3-36	9	2	18							2				
R4-7a-24	5	2	10							2				
G20-2-36	5	(2)	(9)							(2)				
SUBTOTAL: PHASE II-B - RIGH		LOSURF -	41 CONSTR	UCTION	HOURS		0		0	8	0	0	0	78
CHANNELIZATION					3.1.3							(1)	(62)	
R2-1-24-25	5	(4)	(20)							(4)		\·/	()	1
W20-4-36-1000	9	(2)	(18)			-				(2)				
W3-4-36	9	(2)	(18)							(2)				
W20-7-36	9	(2)	(18)							(2)				
G20-2-36	5	(2)	(9)	 BARE	CICADE, T	VDE III	**		**	(2)				
R11-NM-2-48 W1-6L-48	10 8	(1)	(10) (8)		RICADE, T		**		**					
SUBTOTAL:		<u> </u>	(101)	D/MKIN	,, 1	=	0		0	(12)	0	(1)	(62)	0
PHASE II-B - RIGH		LOSURE -		NSTRUC	TION HOU	RS				·		(*)	,,	
CHANNELIZATION	DEVICE	S												(78)
R2-1-24-25	5	(4)	(20)							(4)				
W20-1-36-750	9	(2)	(18)							(2)				
W8-3-36	9	(2)	(18)				**		**	(2)				
W8-15P-24	3 9	(2)	(6)		NT w/ W8 I					(2)				
W6-3-36 R4-7a-24	5	(2)	(18) (10)							(2)				
G20-2-36	5	(2)	(9)							(2)				
SUBTOTAL:		i (=)	(99)				0	I	0	(14)	0	0	0	(78)
			1-7/				-			1-7	-	-		· · · · ·

						MOU	INTING REQ	UIREMEN	rs		CHANNELIZATION DEVICES			
	SIGN	NO. OF	TOTAL		P/	OST		BAS	E POST	DODTARI E	'			VEDTICAL
SIGN CODE			SIGN AREA	LEFT	CENTER		TOTAL LENGTH	NO.	TOTAL LENGTH	PORTABLE SIGN SUPPORT	BARRICADE, TYPE II-36"	TYPE III-96"	DRUMS	VERTICAL PANEL, TYPE BACK TO BACK
	S.F.	EACH	S.F.	L.F.	L.F.	L.F.	L.F.	EACH	L.F.	EACH	EACH	EACH	EACH	EACH
PHASE III - RIVER			, RIVER S	TRUCTUE	RES									
CHANNELIZATION													(51)	
W21-5-36	9	5	45							5				
SUBTOTAL:			45				0		0	5	0	0	(51)	0
PHASE IV-A - LEFT LANE CLOSURE - CONSTRUCTION HOURS														
CHANNELIZATION						т	т			-	<u> </u>	(1)	(62)	
R2-1-24-25	5	(4)	(20)					 -	<u> </u>	(4)	<u> </u>	<u> </u>		<u> </u>
W20-4-36-1000	9	(2)	(18)					-		(2)	<u> </u>			
W3-4-36	9	(2)	(18)							(2)	<u> </u>	<u> </u>	↓	
W20-7-36	9	(2)	(18)					-		(2)	<u> </u>			
G20-2-36	5	(2)	(9)					-	-	(2)	<u> </u>			
R11-NM-2-48	10	(1)	(10)		RICADE, T		**	-	**		<u> </u>			<u> </u>
W1-6L-48	8	(1)	(8)	BARK	RICADE, T	YPE III	**		**		'			
SUBTOTAL:		· acupe	(101)	- io - Dulo'			0		0	(12)	0	(1)	(62)	0
PHASE IV-A - LEFT			NON-CO	NSTRUCI	ION HOU	RS								
CHANNELIZATION			- (20)						т—	T (4)	<u> </u>	1		(78)
R2-1-24-25	5	(4)	(20)					-		(4)	<u> </u>		 	
W20-1-36-750	9	(2)	(18)							(2)	<u> </u>	1		_
W8-3-36	9	(2)	(18)		UM		**		**	(2)	<u> </u>	1		
W8-15P-24	3	(2)	(6)		JNT w/W8-	1					<u> </u>	1		
W6-3-36	9	(2)	(18)							(2)	 '			
R4-7a-24	5	(2)	(10)					-		(2)	<u> </u>	1		
G20-2-36	5	(2)	(9)							(2)	'			170
SUBTOTAL:		C' OCUPE	(99)	TO LOTION	· · · · · · · · · · · · · · · · · · ·		0		0	(14)	0	0	0	(78)
PHASE IV-B - RIGH			- CONSTI	RUCTION	HOURS						_	T (4)	T (CO)	
CHANNELIZATION			(00)						т	T (4)	 '	(1)	(62)	
R2-1-24-25	5	(4)	(20)					-	-	(4)	<u> </u>			
W20-4-36-1000	9	(2)	(18)							(2)	<u> </u>			
W3-4-36	9	(2)	(18)					-	-	(2)	 '		+	
W20-7-36 G20-2-36	5	(2)	(18)					-		(2)	 '		+	
	10	(2)	(9)	BADE	RICADE, T	VDE III	**		**	(2)	 '		+	
R11-NM-2-48	8	(1)	(10)		RICADE, T		**	-	**		 '		+	
W1-6L-48 SUBTOTAL:	8	(1)	(8)	DAKK	ICADE, I	YPE III	0		0	(12)	0		(6.3)	0
PHASE IV-B - RIGH	T I ANE	CLOSTIBE	(101)	ONSTRUC	CTION HO	IIDS				(12)		(1)	(62)	
CHANNELIZATION			- 11011-00	- JNO I RUG	TION FICE						Т	Т		(78)
R2-1-24-25	5	(4)	(20)	T	T 1		T	T	T	(4)		1	+	(10)
W20-1-36-750	9	(2)	(18)							(2)	+	1	+	+
W8-3-36	9	(2)	(18)							(2)	 	1	+	+
W8-15P-24	3	(2)	(6)		 JNT w/ W8-		**		**					+
W6-3-36	9	(2)	(18)			-5-55				(2)		1	+	+
R4-7a-24	5	(2)	(10)							(2)	+		+	+
G20-2-36	5	(2)	(9)							(2)		1	+	
			, (3)	1		1 '	1	1 '	1 '	(2)	1 '	1		

(#) SIGN QUANTIFIED IN A PREVIOUS PHASE OR EXISTING.

** NO POSTS REQUIRED, SIGN TO BE MOUNTED ON POSTS WITH ANOTHER SIGN.

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SUBCONSULTANTS


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LANDSCAPE ARCHITECTURE **DESIGN OFFICE** T 505.983.1415

TOPOGRAPHIC MAPPING COOPER AERIAL SURVEYS CO. T 602.678.5111

SUBSURFACE UTILITY ENGINEERING COLLIERS ENGINEERING & DESIGN T 505.228.3154

REGISTRATION

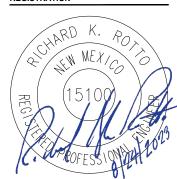

ISSUE/REVISION

I/R	DATE	DESCRIPTION
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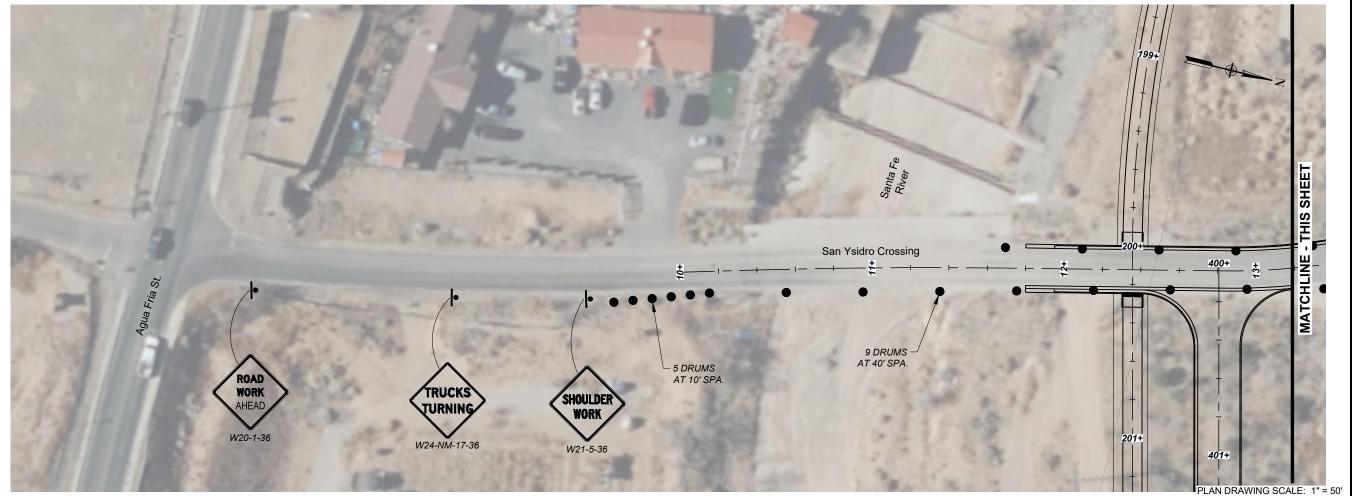
KEY PLAN

PROJECT NUMBER

357-7708

SHEET TITLE

TRAFFIC CONTROL QUANTITIES





PROJECT

SANTA FE RIVER **GREENWAY PROJECT** (SECTION B)

CLIENT

SANTA FE COUNTY

SANTA FE

100 Catron St. Santa Fe, New Mexico 87501 T 505.986.6200 www.santafecountynm.gov

ENGINEERING CONSULTANT

150 Washington Avenue, Suite 201 Santa Fe, New Mexico 87501 T 505.855.7500 www.aecom.com

SUBCONSULTANTS

GEOTECHNICAL TERRACON T 505.797.4287

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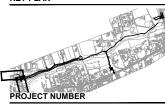
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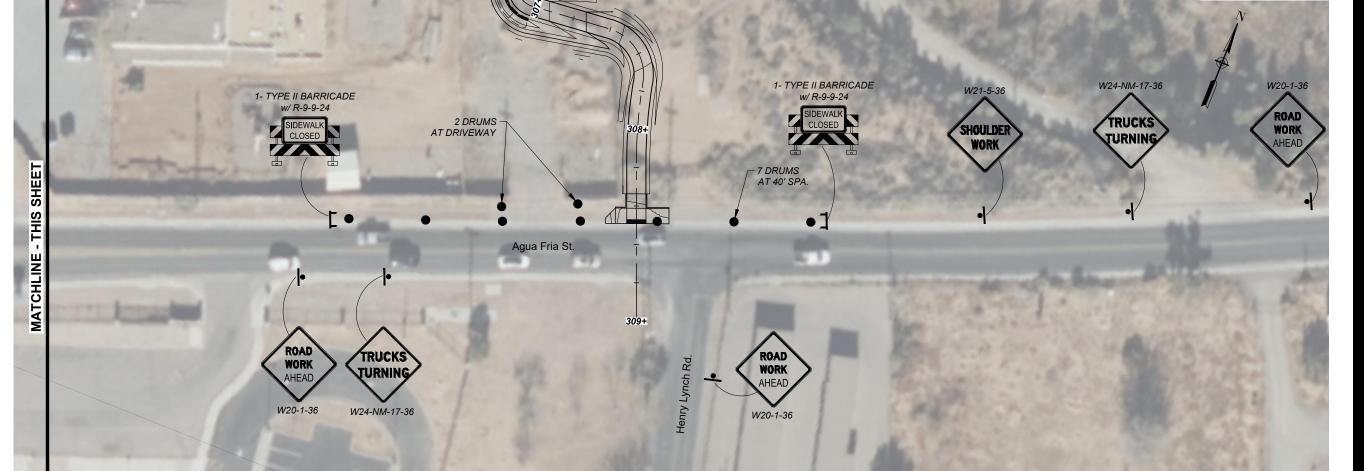
KEY PLAN



SHEET TITLE

TRAFFIC CONTROL SAN YSIDRO CROSSING





PROJECT

SANTA FE RIVER **GREENWAY PROJECT** (SECTION B)

CLIENT

SANTA FE COUNTY

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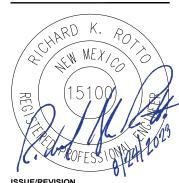
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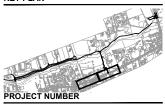
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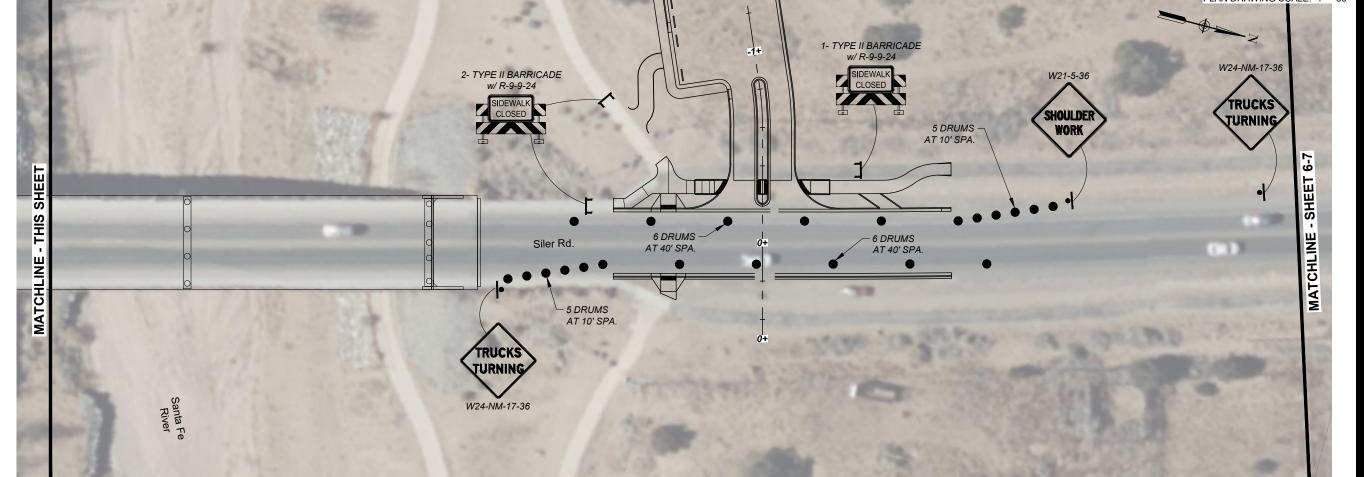
KEY PLAN



SHEET TITLE

TRAFFIC CONTROL AGUA FRIA STREET





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SANTA FE RIVER **GREENWAY PROJECT** (SECTION B)

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SANTA FE COUNTY



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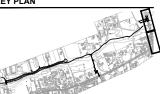
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KEY PLAN



PROJECT NUMBER

SHEET TITLE

TRAFFIC CONTROL SILER ROAD



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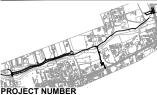
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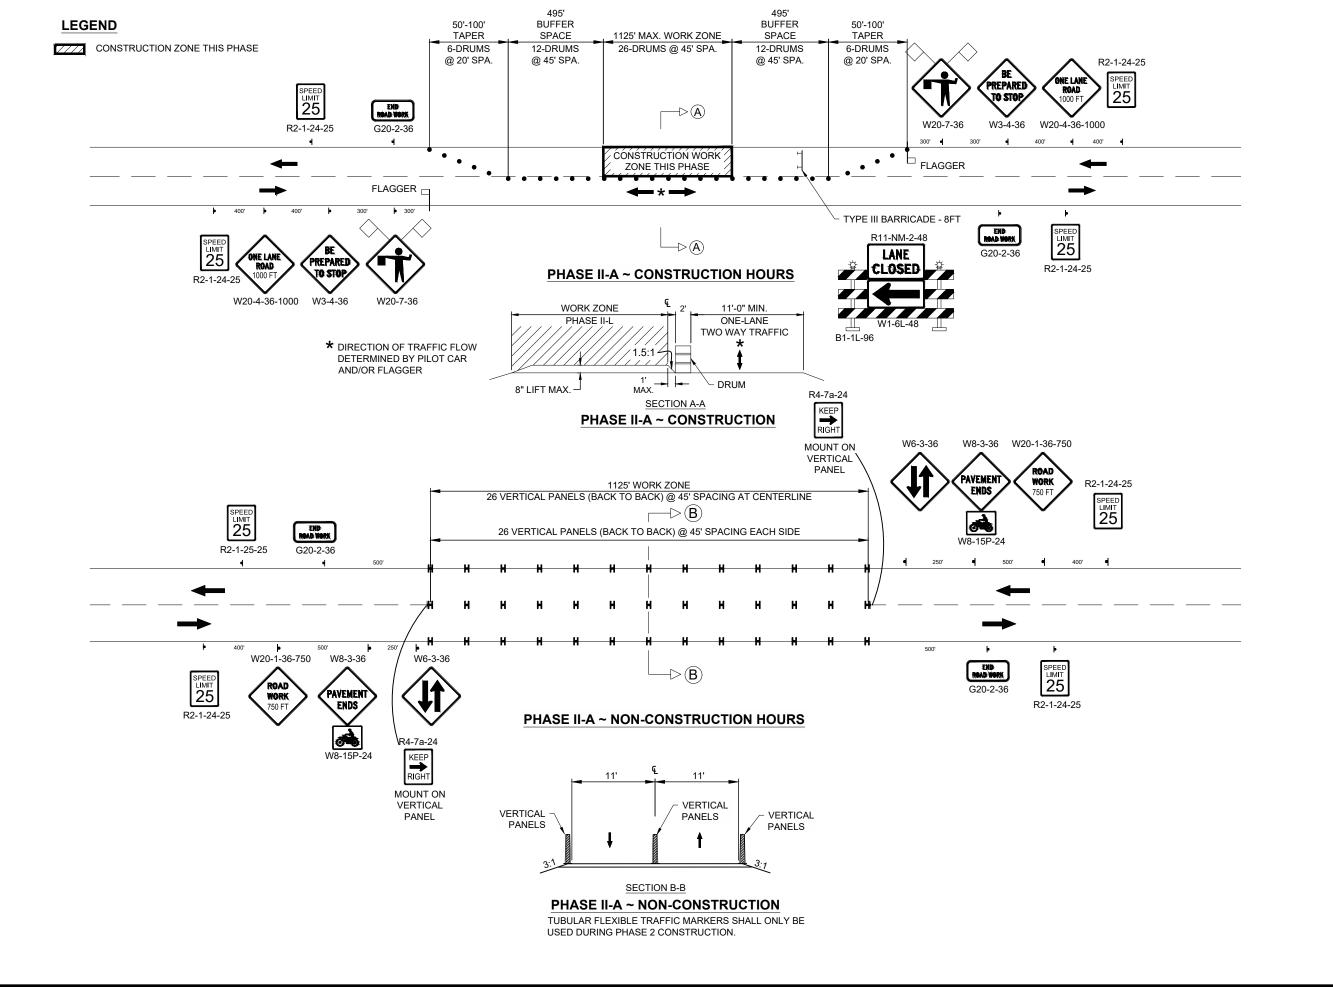
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TRAFFIC CONTROL SILER ROAD







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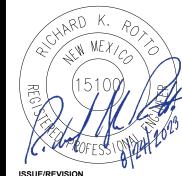
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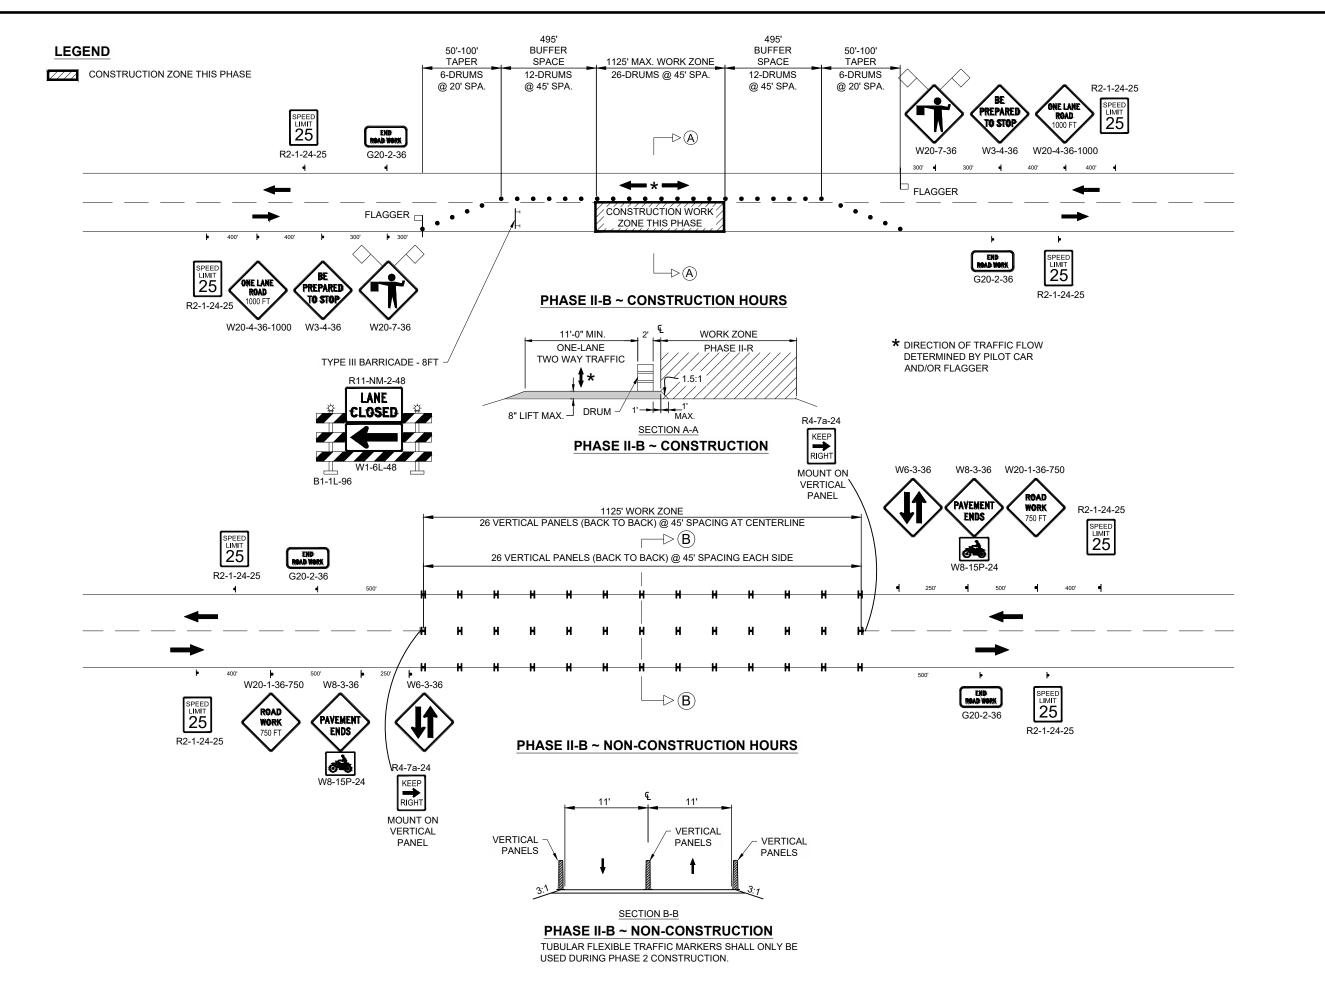
PROJECT NUMBER

357-7708

SHEET TITLE

TRAFFIC CONTROL PHASE II-A LEFT LANE CLOSURE







PROJECT

SANTA FE RIVER **GREENWAY PROJECT** (SECTION B)

CLIENT

SANTA FE COUNTY



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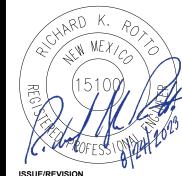
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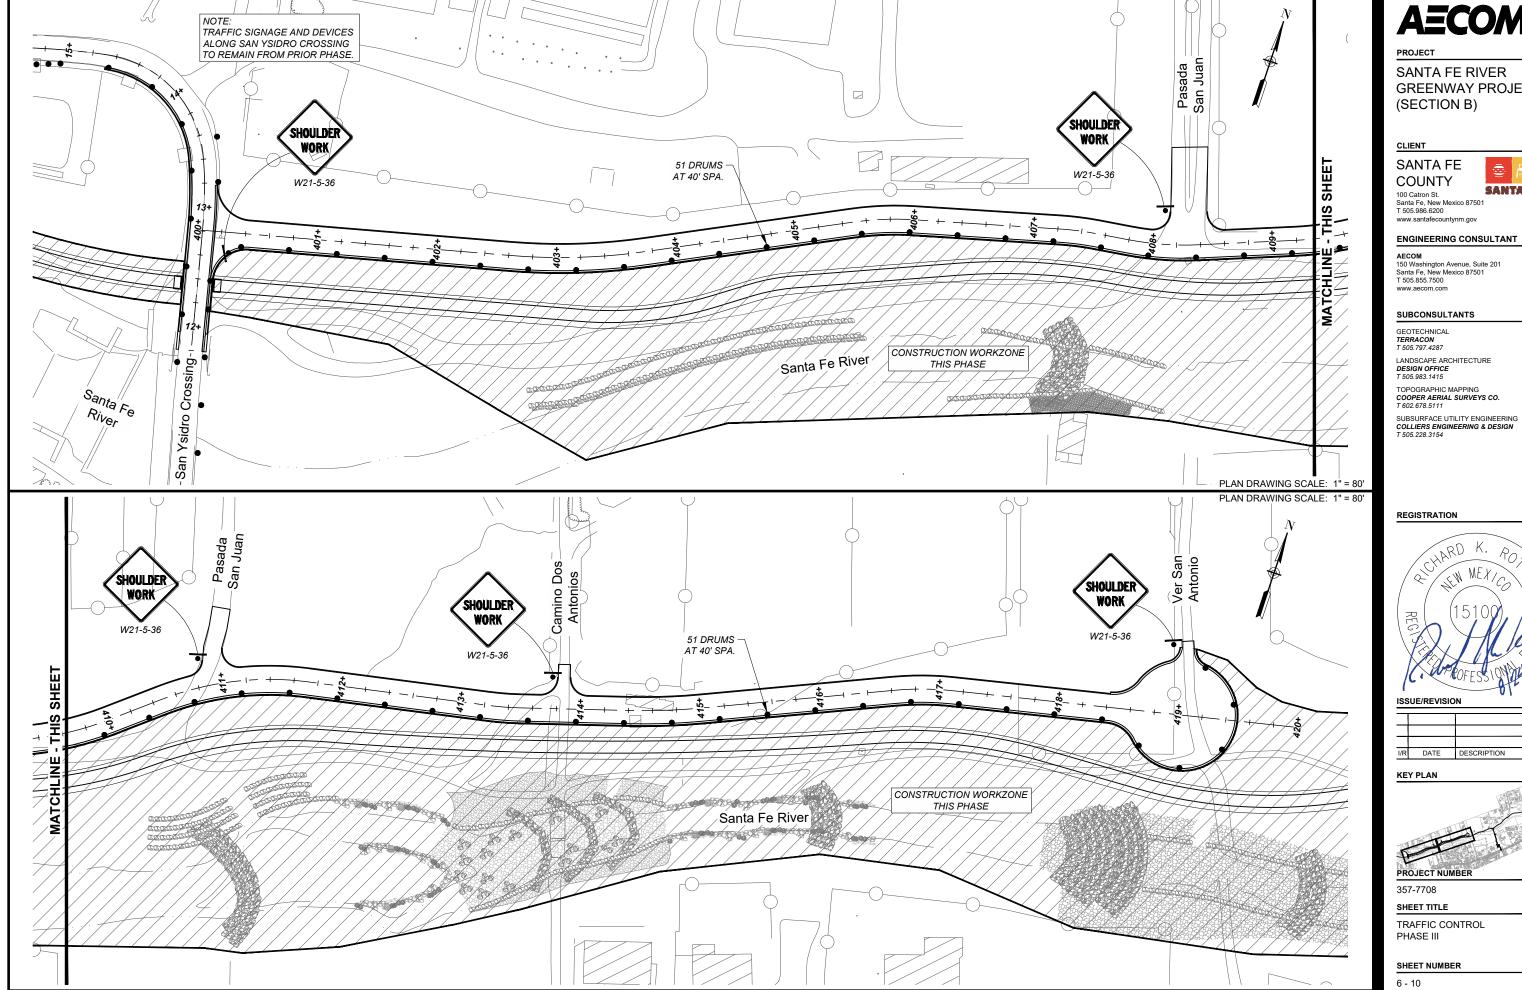
KEY PLAN

PROJECT NUMBER

357-7708

SHEET TITLE

TRAFFIC CONTROL PHASE II-B RIGHT LANE CLOSURE




SANTA FE RIVER **GREENWAY PROJECT**

SANTA FE



I/R	DATE	DESCRIPTION

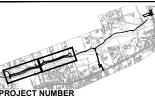

PERMANENT SIGNING NOTES:

- THE CONTRACTOR SHALL STAKE OUT ALL NEW SIGN LOCATIONS FOR APPROVAL BY THE SANTA FE COUNTY PROJECT MANAGER PRIOR TO INSTALLATION. THIS LAYOUT WILL BE CONSIDERED AS INCIDENTAL TO ITEM 701000, PANEL SIGNS. NO SEPARATE PAYMENT WILL BE MADE.
- 2. STEEL POST FOR PANEL SIGNS SHALL BE 2.25 X 2.25.


PERMANENT STRIPING AND MARKING NOTES:

 THE CONTRACTOR SHALL MARK THE LAYOUT OF ALL STRIPING AND PAVEMENT MARKINGS AND SHALL OBTAIN CONCURRENCE FROM THE SANTA FE COUNTY PROJECT MANAGER BEFORE APPLYING THE FINAL STRIPING AND MARKINGS. THIS LAYOUT WILL BE CONSIDERED AS INCIDENTAL TO THE COST OF EACH SPECIFIC PAVEMENT MARKING AS APPROPRIATE. NO SEPARATE PAYMENT WILL BE MADE.

LIST OF INCIDENTAL ITEMS:

- STAKE OUT OF SIGN LOCATIONS.
- LAYOUT OF STRIPING AND PAVEMENT MARKINGS.

SIGNFACE DETAILS

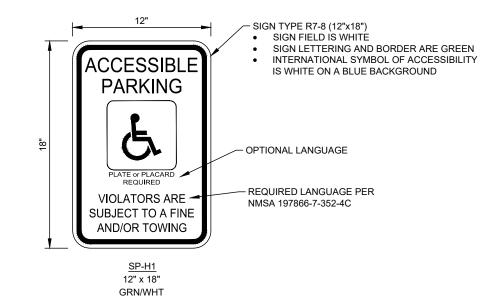

AECOM

PROJECT

SANTA FE RIVER GREENWAY PROJECT (SECTION B)

CLIENT

SANTA FE COUNTY

NTY

SANTA FE

New Mexico 87501

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Santa Fe, New Mexico 87501
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KEY PLAN

PROJECT NUMBER

357-7708

SHEET TITLE

PERMANENT SIGNING AND STRIPING NOTES

SHEET NUMBER

7 1

BASE BID - SUMMARY OF QUANTITIES PERMANENT SIGNING AND STRIPING ITEMS

ITEM No.	DESCRIPTION	UNITS	USE
701000	PANEL SIGNS	S.F.	110
701100	STEEL POST AND BASE POST FOR ALUMINUM PANEL SIGNS	L.F.	325
704000	RETROREFLECTORIZED PAINTED MARKINGS 4"	L.F.	8460
704704	HOT THERMOPLASTIC PAVEMENT MARKING 24"	L.F.	154
704724	HOT THERMOPLASTIC PAVEMENT MARKING WORD (XING)	EACH	4
704732	HOT THERMOPLASTIC PAVEMENT MARKING BIKE SYMBOL (BIKEWAY)	EACH	4
704733	HOT THERMOPLASTIC PAVEMENT MARKING HANDICAPPED SYMBOL	EACH	2

BID ALT. #1 - SUMMARY OF QUANTITIES PERMANENT SIGNING AND STRIPING ITEMS

ITEM No.	DESCRIPTION	UNITS	USE
701000	PANEL SIGNS	S.F.	20
701100	STEEL POST AND BASE POST FOR ALUMINUM PANEL SIGNS	L.F.	60
704706	HOT THERMOPLASTIC PAVEMENT MARKINGS 12"	L.F.	134
704704	HOT THERMOPLASTIC PAVEMENT MARKING 24"	L.F.	22

BASE BID - PERMANENT SIGN INSTALLATION SCHEDULE

		COLOR 7010			701000 -	- PANEL SIGNS						701100 - STEEL POST AND BASE POST FOR ALUMINUM PANEL SIGNS						
SIGN	DIRECTION			NO. OF		SIGN DI	MENSIONS		SIGN	TOTAL SIGN	SIGN POST LENGTHS				BASE	POSTS	TOTAL	INSTALLATION NOTES
CODE	DIRECTION	LEGEND	BACKGND.	SIGNS	WIDTH	HEIGHT	OCTAGON	DIAMOND	AREA	AREA	LEFT CENTER		RIGHT	TOTAL	QTY.	LENGTH	LENGTH	
				EACH	IN.	IN.	IN.	IN.	S.F.	S.F.	L.F.	L.F.	L.F.	L.F.	EACH	L.F.	L.F.	
R1-1-30	FATD	WHITE	RED	5			30		4.91	24.54		11.00		11.00	5	3.00	70.00	TRAFFIC SIDE: RIGHT
R1-1-18	FATD	WHITE	RED	2			18		1.77	3.53		11.00		11.00	2	3.00	28.00	RIVER TRAIL, SAN YSIDRO
R4-7	FATD	BLACK	WHITE	2	24	30			5.00	10.00		11.00		11.00	2	3.00	28.00	FACING APPROACH TRAFFIC
R5-3	FATD	BLACK	WHITE	2	24	24			4.00	8.00		11.00		11.00	2	3.00	28.00	FACING EAST
OM4-2	FATD	RED	BLACK	6				18	2.25	13.50		11.00		11.00	6	3.00	84.00	FACING SOUTH
R7-8a	FATD	GREEN	WHITE	2	12	6			0.50	1.00				0.00			0.00	MOUNT WITH SP-H1 (BELOW)
SP-H1	FATD	GREEN	WHITE	2	12	18			1.50	3.00		11.00		11.00	2	3.00	28.00	HANDICAP PARKING
W14-1-30	FATD	BLACK	YELLOW	2				30	6.25	12.50				0.00			0.00	MOUNT BELOW EXIST. STREET SIGN
W11-15	FATD	BLACK	YELLOW	4				30	6.25	25.00		11.00		11.00	4	3.00	56.00	FACING APPROACH TRAFFIC
W16-7P	FATD	BLACK	YELLOW	4	24	12			2.00	8.00				0.00			0.00	MOUNT WITH W11-15 (BELOW)
					-	-	BASEB	ID TOTAL		109.10						-	322.00	
							BASI	BID USE		110							325	

FATD = FACING APPROACH TRAFFIC DIRECTION; FDTD = FACING DEPARTURE TRAFFIC DIRECTION; FSTD = FACING SIDE TRAFFIC DIRECTION

BID ALT. #1 - PERMANENT SIGN INSTALLATION SCHEDULE

	COLOR				OR 701000 - PANEL SIGNS								ST AND BA	SIGNS				
SIGN	DIRECTION	a.T.O.U		NO. OF	SIGN DIMENSIONS				SIGN	SIGN TOTAL SIGN	SIGN POST LENGTHS			;	BASE POSTS		TOTAL	INSTALLATION NOTES
CODE	DIRECTION	LEGEND	BACKGND.	SIGNS	WIDTH	HEIGHT	OCTAGON	DIAMOND	AREA	AREA	LEFT	CENTER	RIGHT	TOTAL	QTY.	LENGTH	LENGTH	
				EACH	IN.	IN.	IN.	IN.	S.F.	S.F.	L.F.	L.F.	L.F.	L.F.	EACH	L.F.	L.F.	
R1-1-18	FATD	WHITE	RED	1			18		1.77	1.77		11.00		11.00	1	3.00	14.00	RIVER TRAIL SIDE: RIGHT
R1-1-30	FATD	WHITE	RED	3			30		4.91	14.73		11.00		11.00	3	3.00	42.00	TRAFFIC SIDE: RIGHT
R1-3P	FATD	WHITE	RED	4	18	6			0.75	3.00				0.00			0.00	MOUNT BELOW R1-1
	BASE BID TOTAL						19.50							56.00				
				BASE BID USE					20							60		

FATD = FACING APPROACH TRAFFIC DIRECTION; FDTD = FACING DEPARTURE TRAFFIC DIRECTION; FSTD = FACING SIDE TRAFFIC DIRECTION

AECOM

PROJECT

SANTA FE RIVER GREENWAY PROJECT (SECTION B)

CLIE

SANTA FE COUNTY



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REGISTRATION



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I/R	DATE	DESCRIPTION

KEY PLAN

PROJECT NUMBER

357-7708

SHEET TITLE

PERMANENT SIGNING AND STRIPING QUANTITIES

BASE BID - ITEM No. 704000

RETROREFLECTORIZED PAINTED MARKINGS 4"

ALIGNMENT	STATION TO STATION			LOCATION	L.F.	REMARKS
CL PASADA SAN JUAN	400+44.91	-	418+42.11	CENTER	3,594	SOLID DOUBLE YELLOW
CL TRAILHEAD	TRAILHEAD		PARKING	633	SOLID WHITE (PARKING LANES)	
	BASE BID SUB-TOTAL					
	X2 APPLICATIONS				8,455.30	
	BASE BID USE			SE BID USE	8,460	

BASE BID - ITEM No. 704704

HOT THERMOPLASTIC PAVEMENT MARKING 24"

ALIGNMENT	STATION	LOCATION	L.F.	REMARKS
CL PASADA SAN JUAN	400+44.91	LT	11	STOP BAR, TO SAN YSIDRO
CL RIVER TRAIL	200+15.00	CL	50	CROSSWALK, 5 @ 10' ACROSS SAN YSIDRO
CL TRAILHEAD	-00+29.00	CL	42	CROSSWALK, 6 @ 7'
CL TRAILHEAD	00+00.00	RT	40	CROSSWALK, 5 @ 8' ACROSS SILER
CL TRAILHEAD	-0+36.00;	RT	11	STOP BAR, TO SILER
	BASE BID SUB-TOTAL			
	BASE BID USE			

BASE BID - ITEM No. 704733

HOT THERMOPLASTIC PAVEMENT MARKING HANDICAPPED SYMBOL

ALIGNMENT	STATION TO STATION	LOCATION	EACH	REMARKS		
TRAILHEAD	TRAILHEAD	PARKING	2	HANDICAP SYMBOL		
	BASE BID SUB-TOTAL					
	BASE BID USE					

BASE BID - ITEM No. 704724

HOT THERMOPLASTIC PAVEMENT MARKING WORD (XING)

ALIGNMENT	STATION	LOCATION	EACH	REMARKS		
SAN YSIDRO CR	11+26.50; 5'RT	NB	1	NORTHBOUND SAN YSIDRO CR.		
SAN YSIDRO CR	13+44.75; 5' LT	SB	1	SOUTHBOUND SAN YSIDRO CR.		
TRAILHEAD	0+05.50; 157' RT	NB	1	NORTHBOUND SILER RD.		
TRAILHEAD	-0+05.50; 59' LT	SB	1	SOUTHBOUND SILER RD.		
	BASE BID SUB-TOTAL 4					
	BASE BID USE 4					

BASE BID - ITEM No. 704731

HOT THERMOPLASTIC MARKING LANE SYMBOL (BIKEWAY)

ALIGNMENT	STATION	LOCATION	EACH	REMARKS
SAN YSIDRO CR	10+86.50: 5' RT	NB	1	NORTHBOUND SAN YSIDRO CR.
SAN YSIDRO CR	13+84.75; 5' LT	SB	1	SOUTHBOUND SAN YSIDRO CR.
TRAILHEAD	0+05.50; 197' RT	NB	1	NORTHBOUND SILER RD.
TRAILHEAD	-0+05.50; 99' LT	SB	1	SOUTHBOUND SILER RD.
	BASE BID	SUB-TOTAL	4	
	BASE BID USE			

BID ALT. #1 - ITEM No. 704706

HOT THERMOPLASTIC PAVEMENT MARKINGS 12"

ALIGNMENT	STATION	LOCATION	L.F.	REMARKS
CL CONNECTOR TRAIL	308+62.00	RT	23	CROSSWALK ACROSS AGUA FRIA ST
CL CONNECTOR TRAIL	308+62.00	LT	24	CROSSWALK ACROSS AGUA FRIA ST
CL CONNECTOR TRAIL	308+74.00	LT	50	CROSSWALK ACROSS AGUA FRIA ST
CL CONNECTOR TRAIL	308+81.00	LT	37	CROSSWALK ACROSS AGUA FRIA ST
BID ALT. #1 SUB-TOTAL			134.00	
	BID ALT. #1 USE			

BID ALT. #1 - ITEM No. 704704

HOT THERMOPLASTIC PAVEMENT MARKING 24"

ALIGNMENT	STATION	LOCATION	L.F.	REMARKS
CL CONNECTOR TRAIL	308+67.00	RT	11	STOP BAR, AT AGUA FRIA ST.
CL CONNECTOR TRAIL	308+87.00	LT	11	STOP BAR, AT AGUA FRIA ST.
BID ALT. #1 SUB-TOTAL			22.00	
	BID A	ALT. #1 USE	22	

AECOM

PROJECT

SANTA FE RIVER GREENWAY PROJECT (SECTION B)

CLIENT

SANTA FE COUNTY



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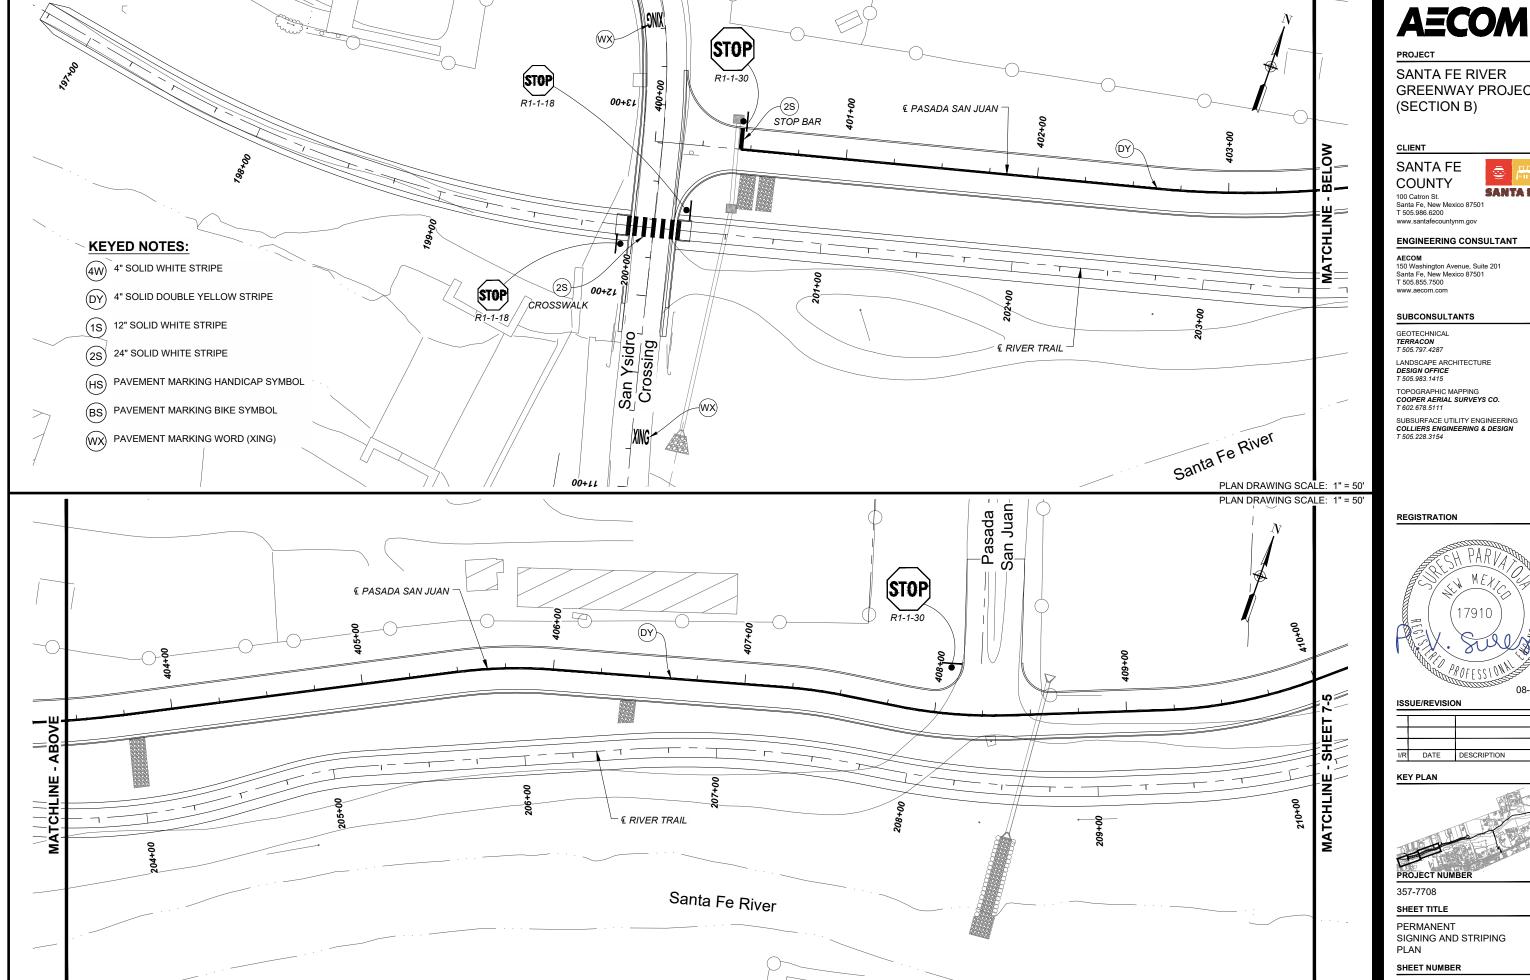
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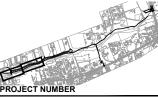



GREENWAY PROJECT

SANTA FE





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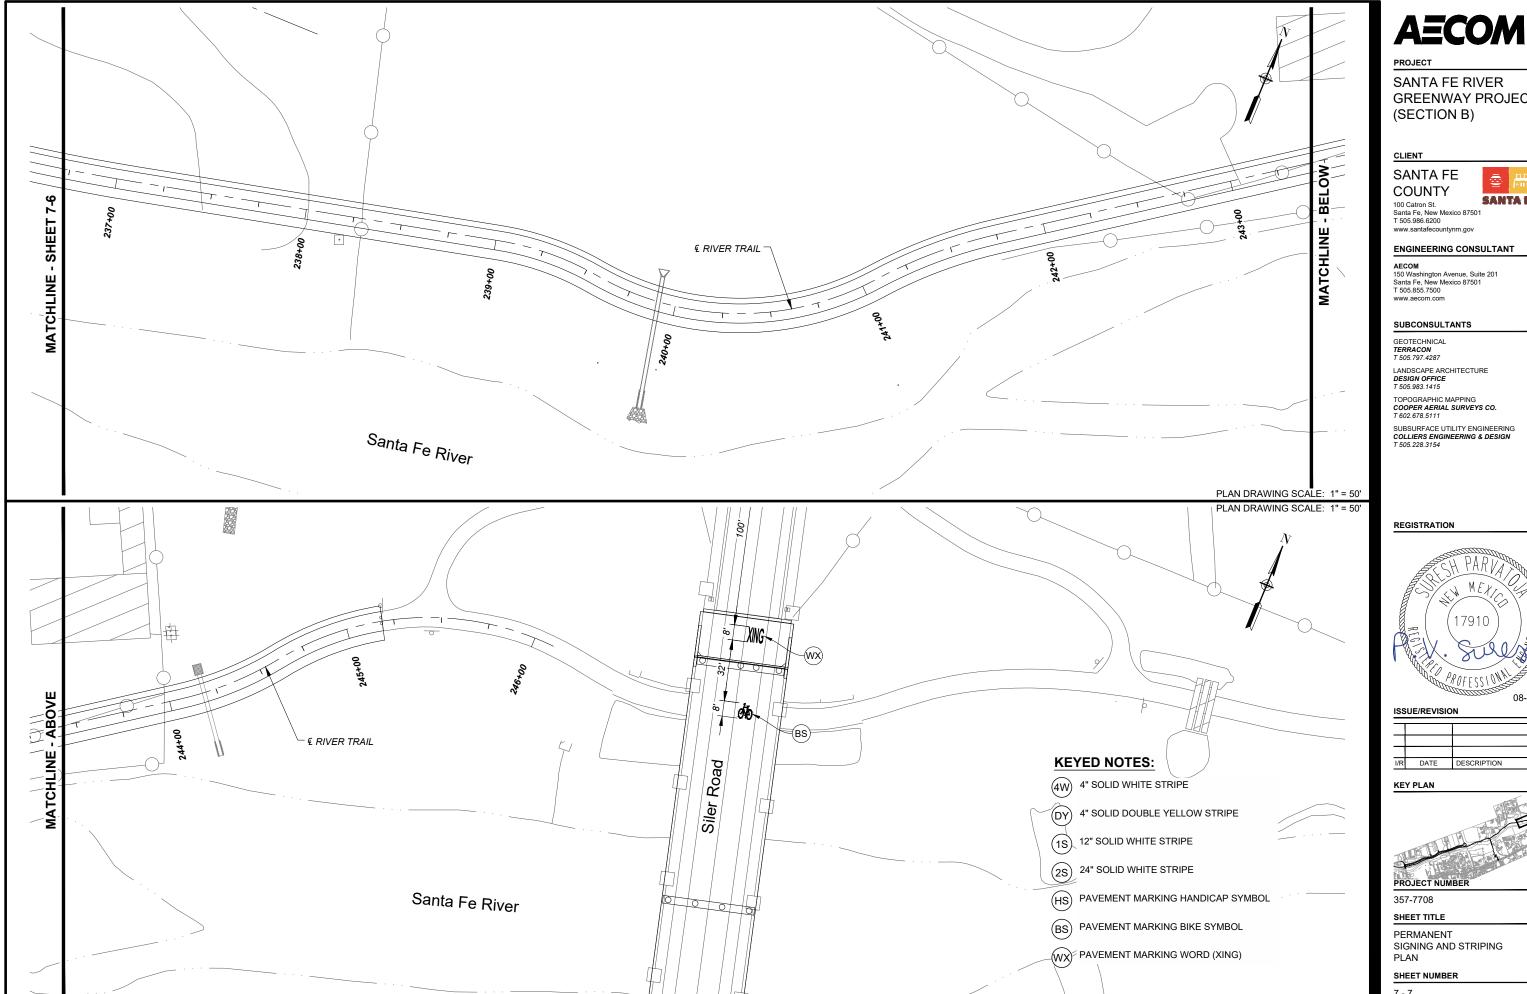




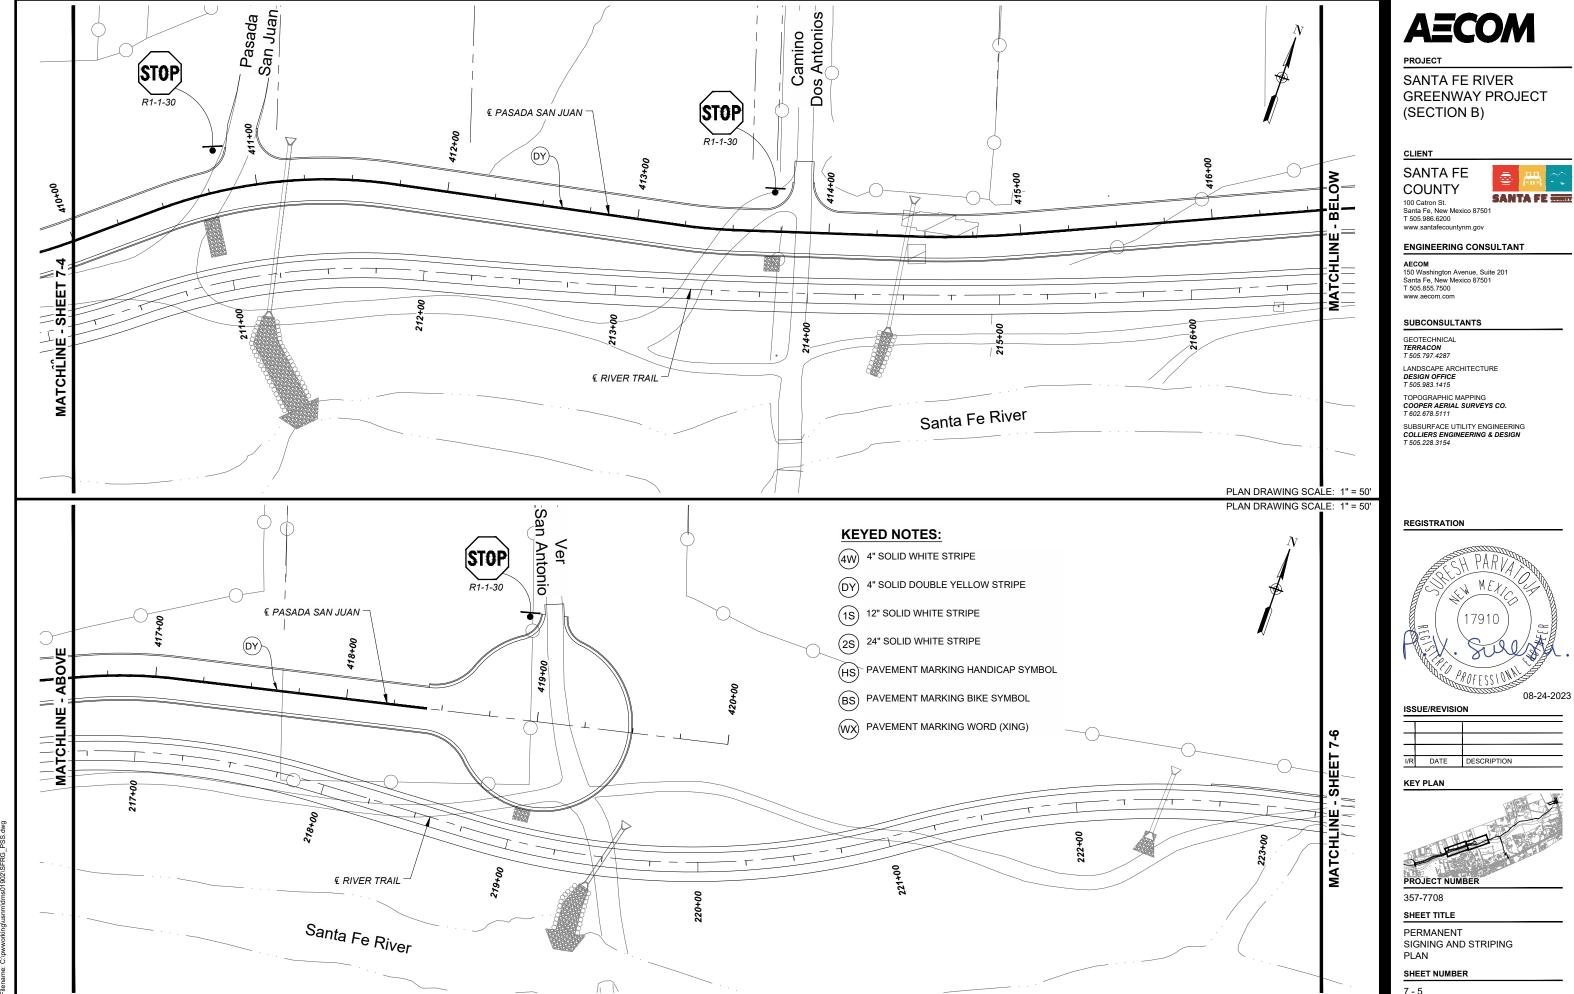



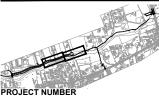

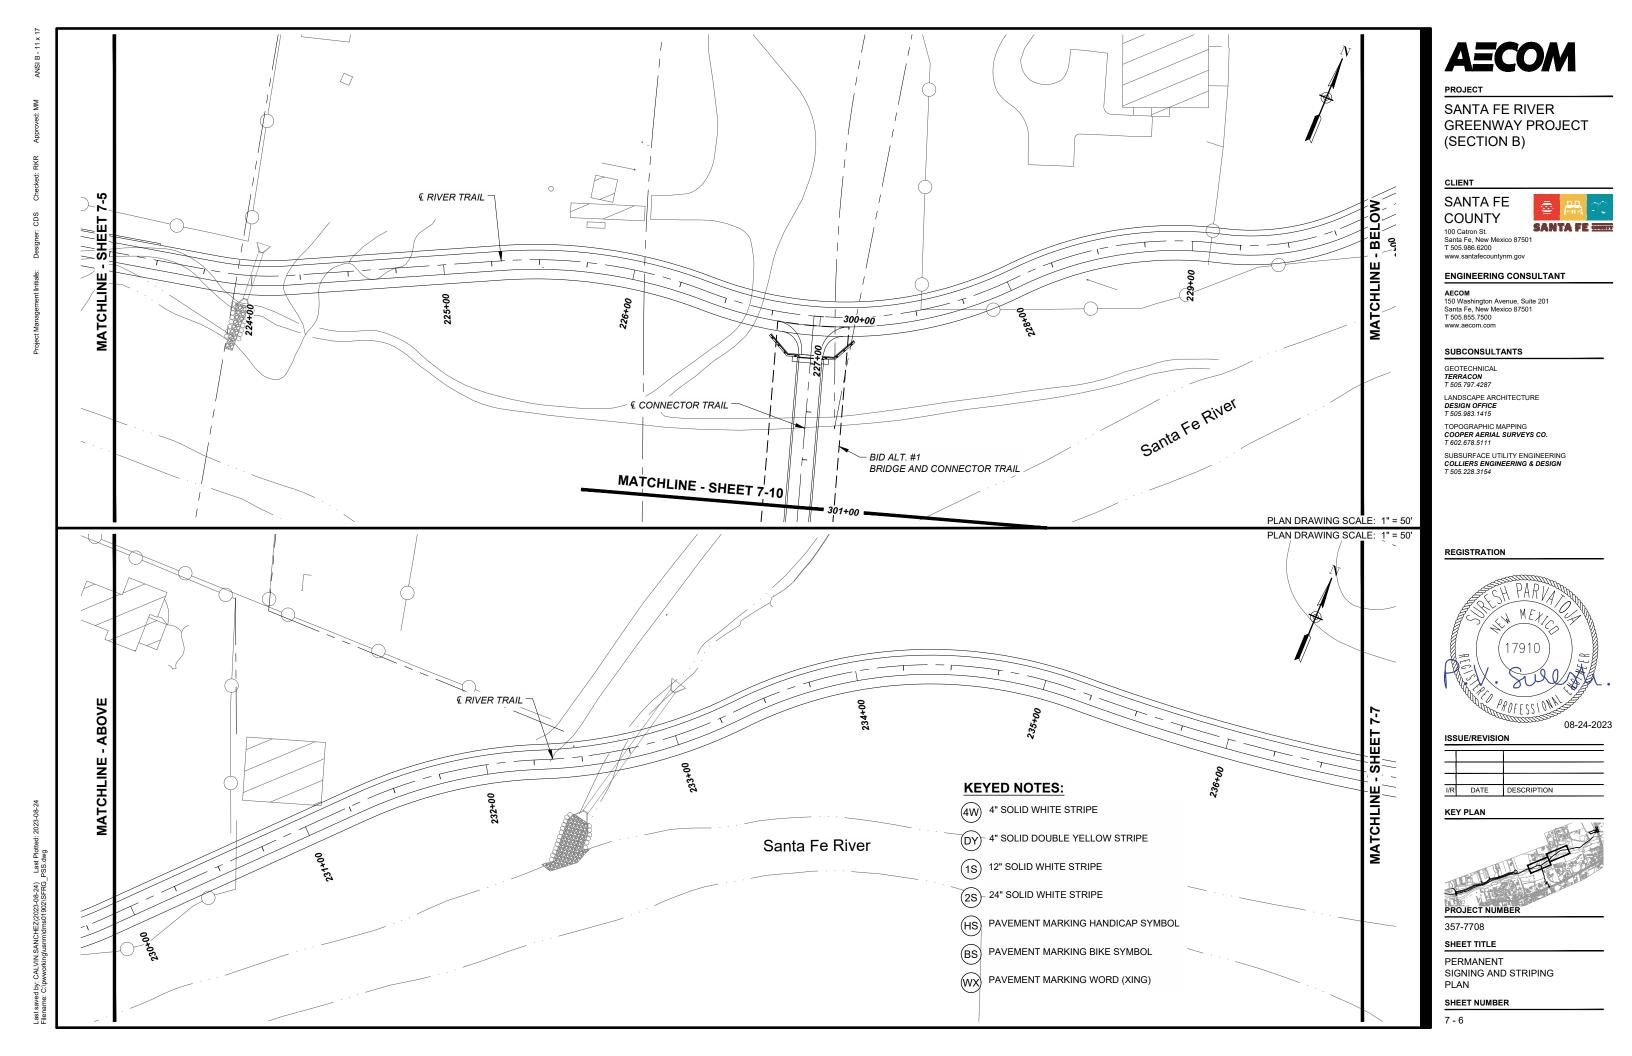

SANTA FE RIVER **GREENWAY PROJECT**

SANTA FE


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SIGNING AND STRIPING



SANTA FE RIVER **GREENWAY PROJECT** (SECTION B)

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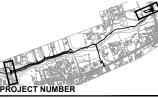
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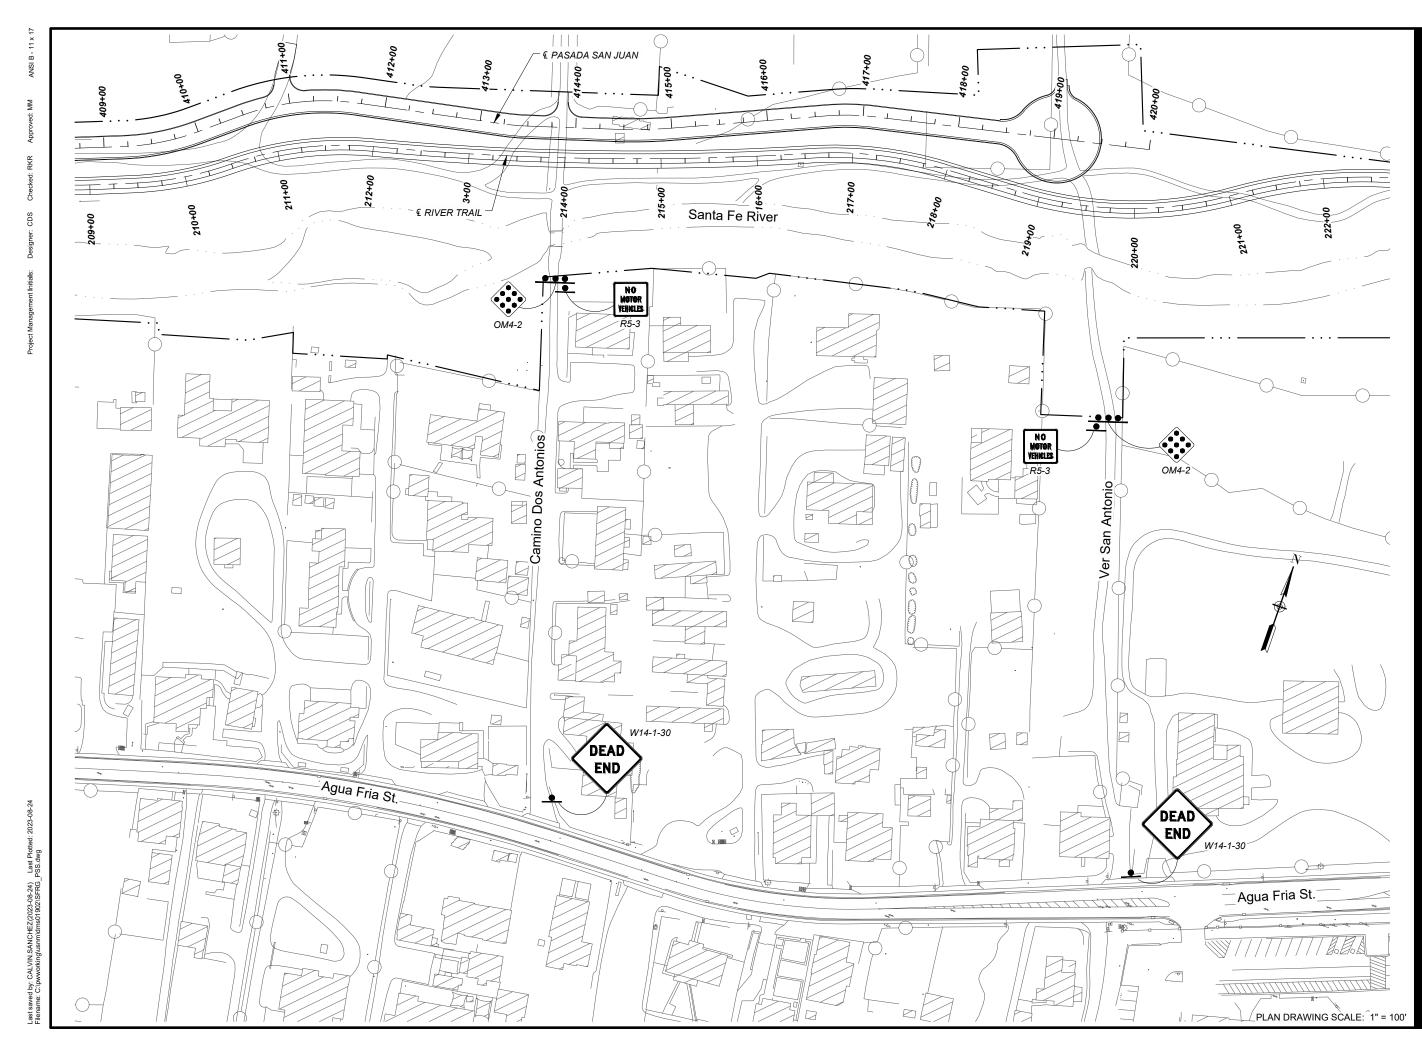
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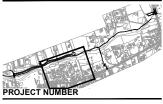
REGISTRATION

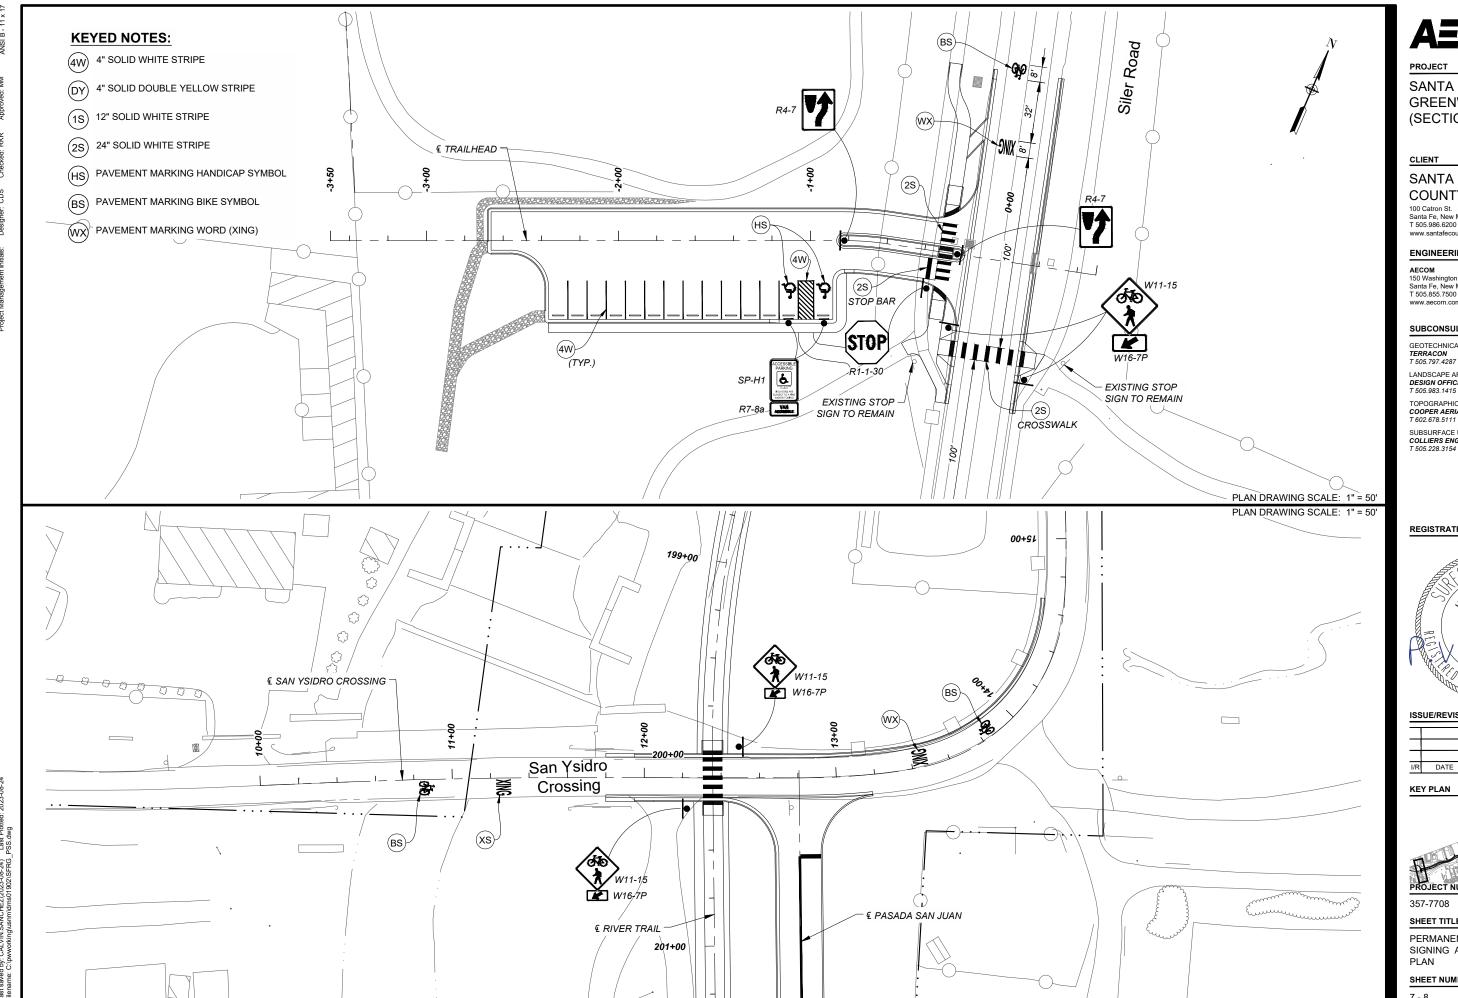

ISSUE/REVISION

I/R	DATE	DESCRIPTION

KEY PLAN




357-7708

SHEET TITLE

PERMANENT SIGNING AND STRIPING PLAN

SHEET NUMBER

7 0

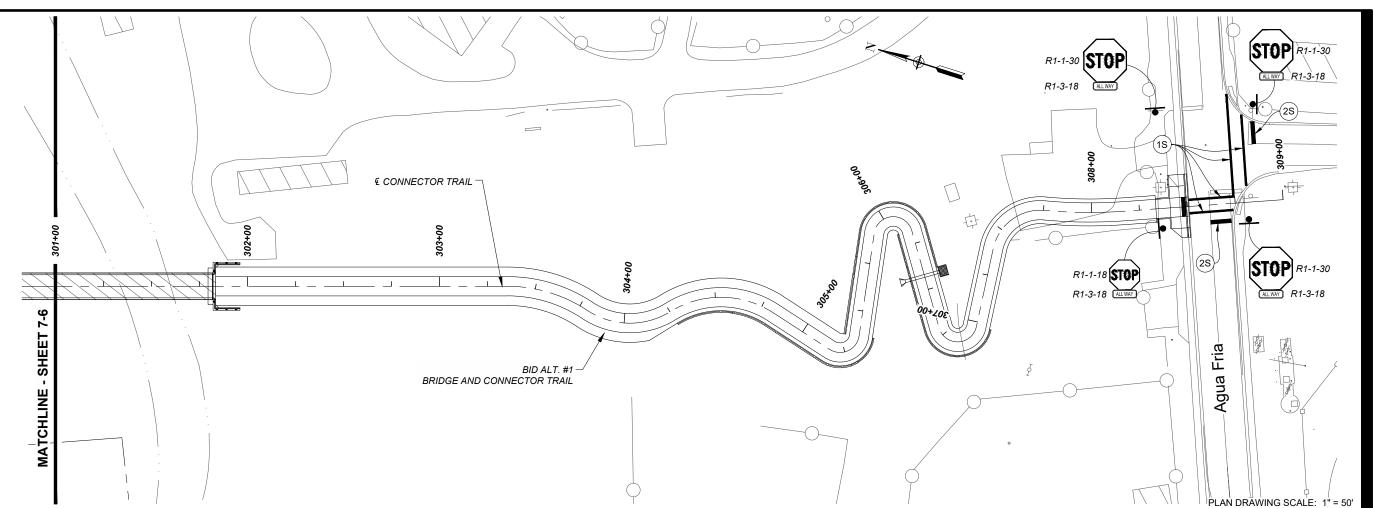

KEYED NOTES:

- 4" SOLID WHITE STRIPE
- (DY) 4" SOLID DOUBLE YELLOW STRIPE
- 1S) 12" SOLID WHITE STRIPE
- 2S) 24" SOLID WHITE STRIPE
- (HS) PAVEMENT MARKING HANDICAP SYMBOL
- BS PAVEMENT MARKING BIKE SYMBOL
- (WX) PAVEMENT MARKING WORD (XING)

AECOM

PROJECT

SANTA FE RIVER **GREENWAY PROJECT** (SECTION B)

SANTA FE COUNTY

SANTA FE

100 Catron St. Santa Fe, New Mexico 87501 T 505.986.6200 www.santafecountynm.gov

ENGINEERING CONSULTANT

150 Washington Avenue, Suite 201 Santa Fe, New Mexico 87501 T 505.855.7500

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GEOTECHNICAL TERRACON T 505.797.4287

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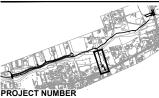
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ISSUE/REVISION

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KEY PLAN





SHEET TITLE

PERMANENT SIGNING AND STRIPING PLAN (BID ALT. #1)

SHEET NUMBER

7 - 10

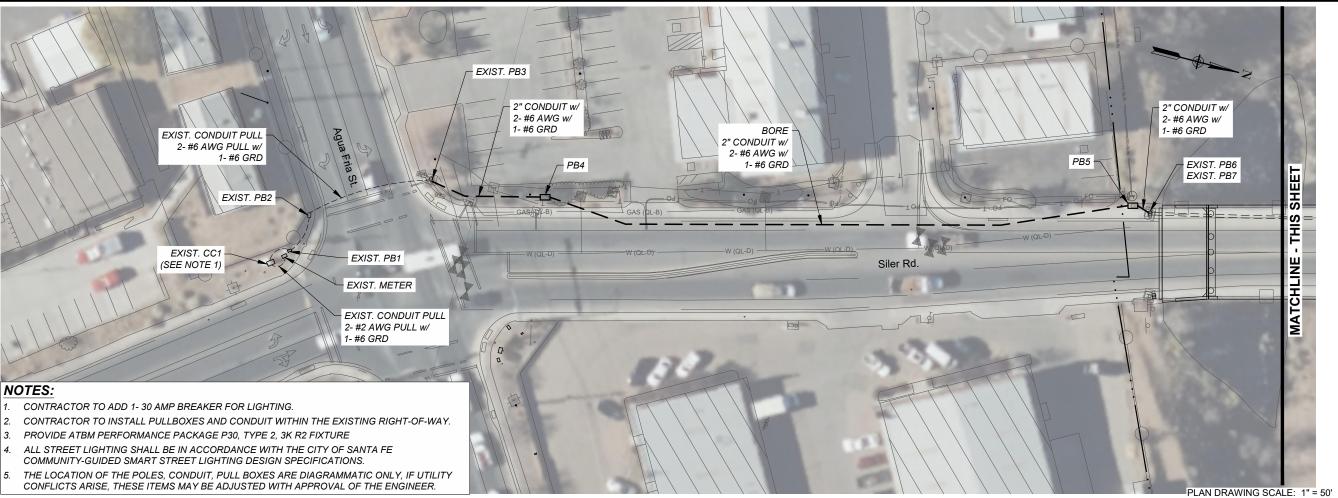

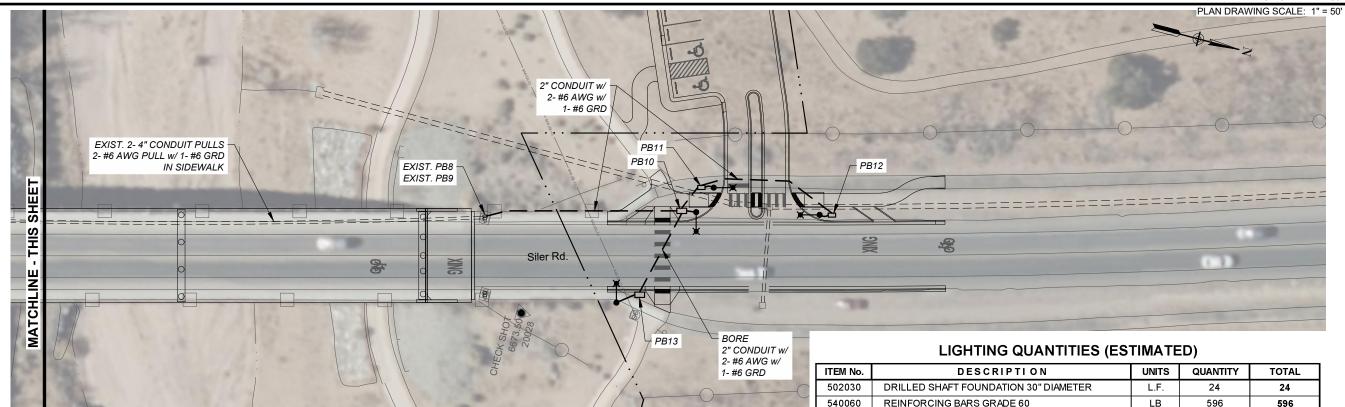

707530

709020

710000

711106

716701

TYPE V STANDARD, 30'

SINGLE CONDUCTOR 6

LED ROADWAY LUMINAIRE

RIGID ELECTRICAL CONDUIT 2" (DIA.)

ELECTRICAL PULL BOX (STANDARD)

EACH

L.F.

EACH

L.F.

EACH

650

3300

650

3300

4

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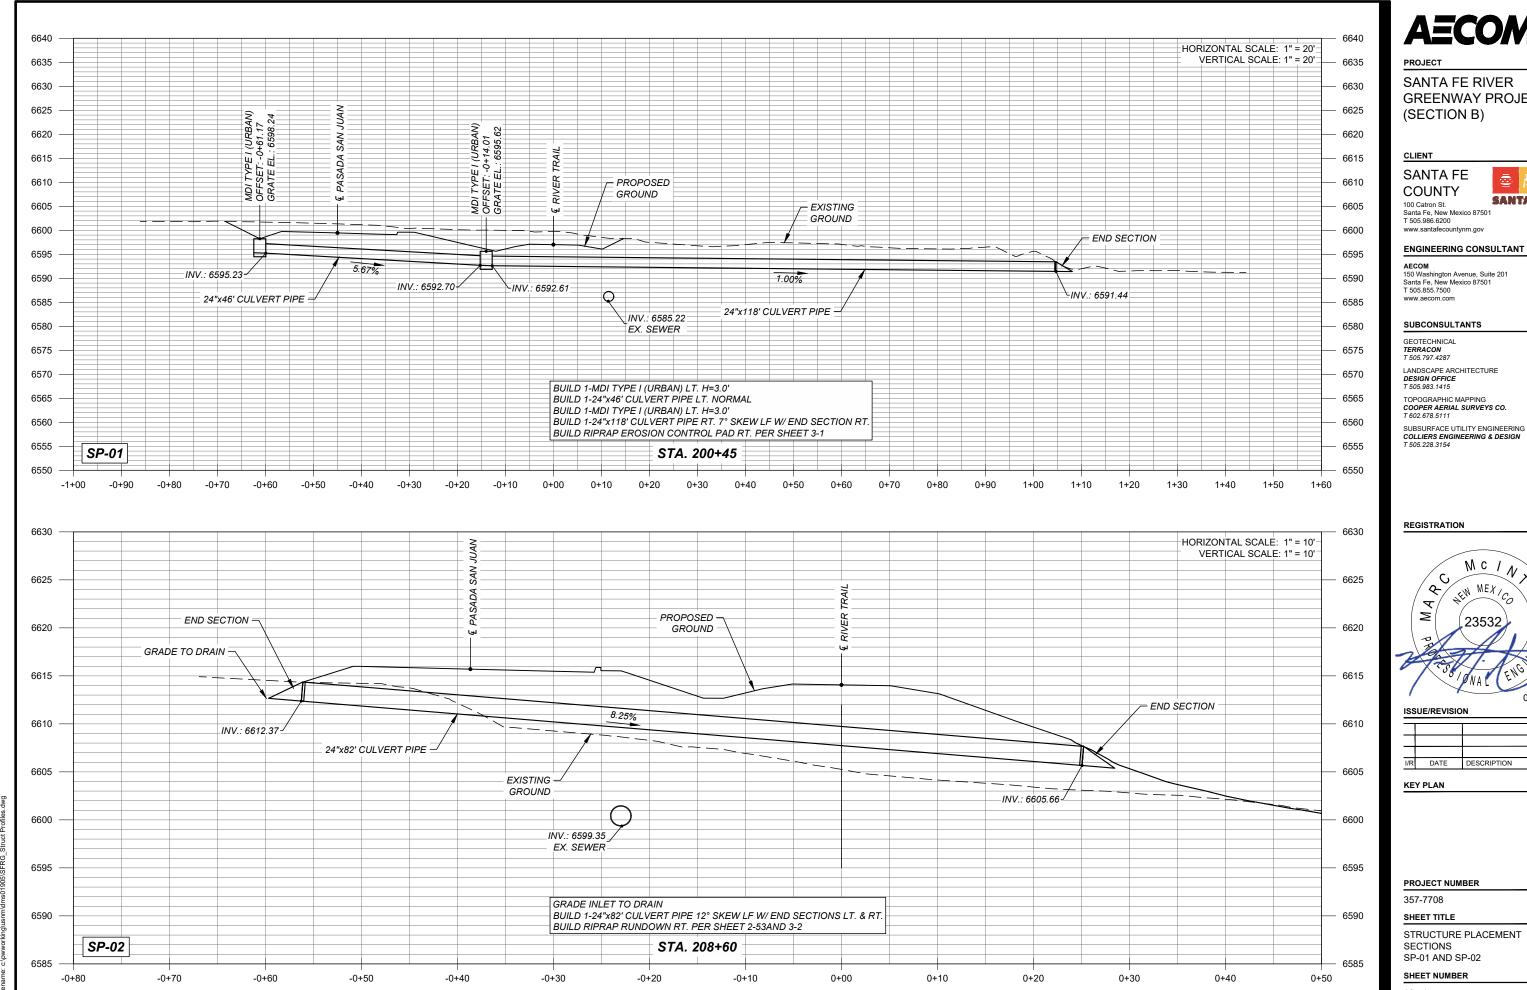
I/R	DATE	DESCRIPTION

KEY PLAN



SHEET TITLE

SILER ROAD LIGHTING PLAN



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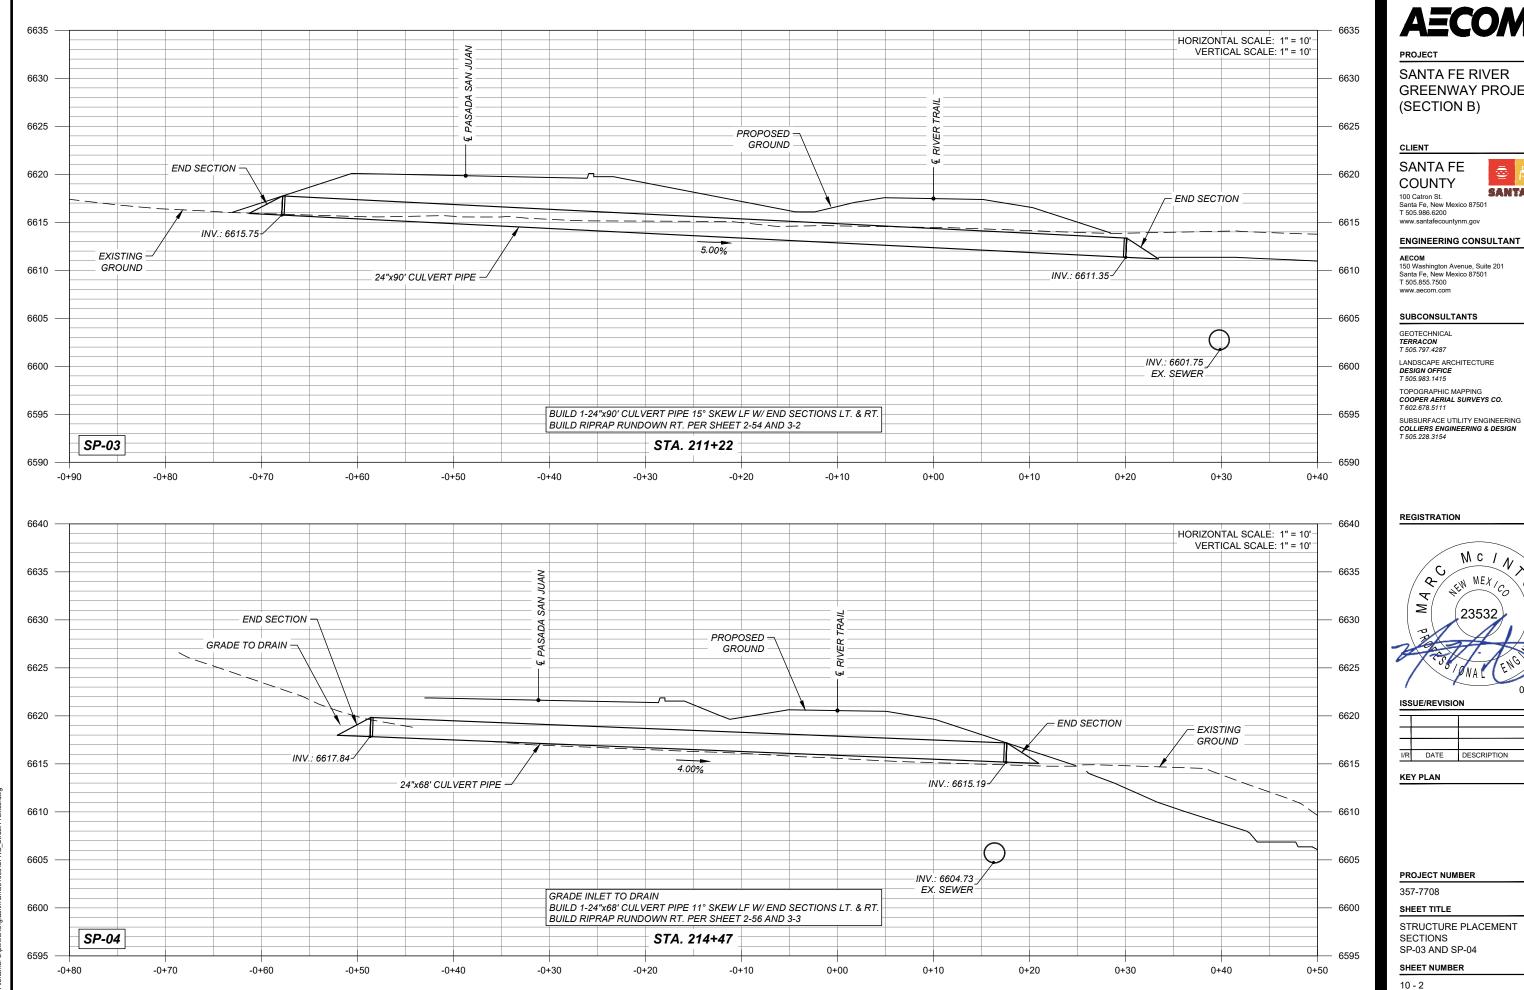
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STRUCTURE PLACEMENT

10 - 1



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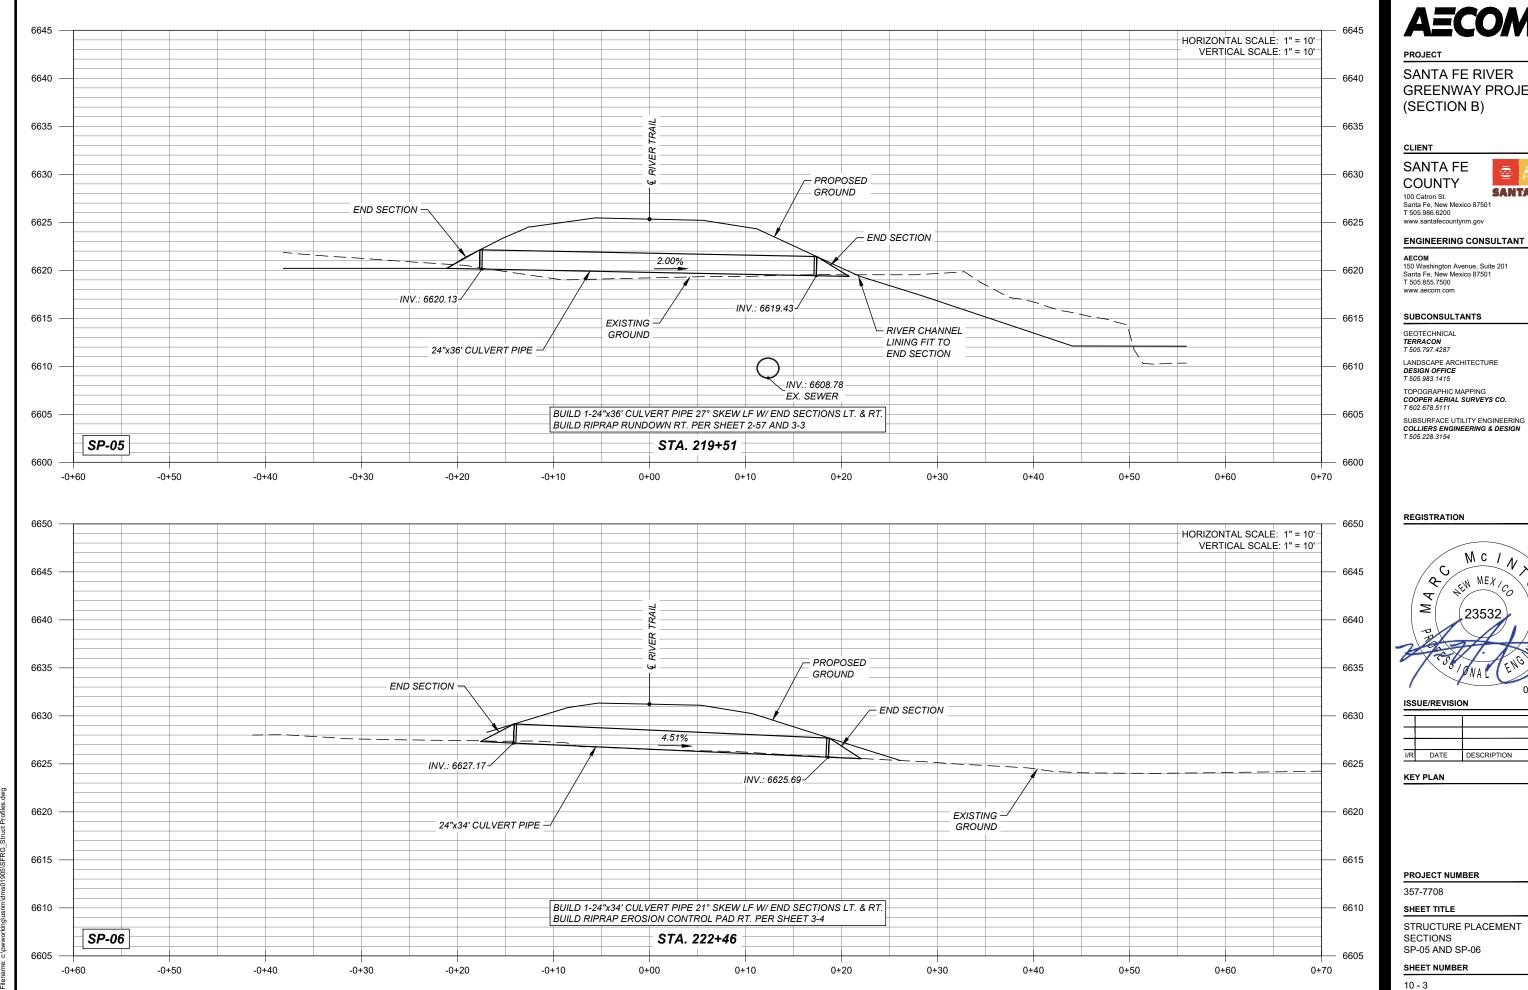
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I/R DATE DESCRIPTION

STRUCTURE PLACEMENT




GREENWAY PROJECT

SANTA FE





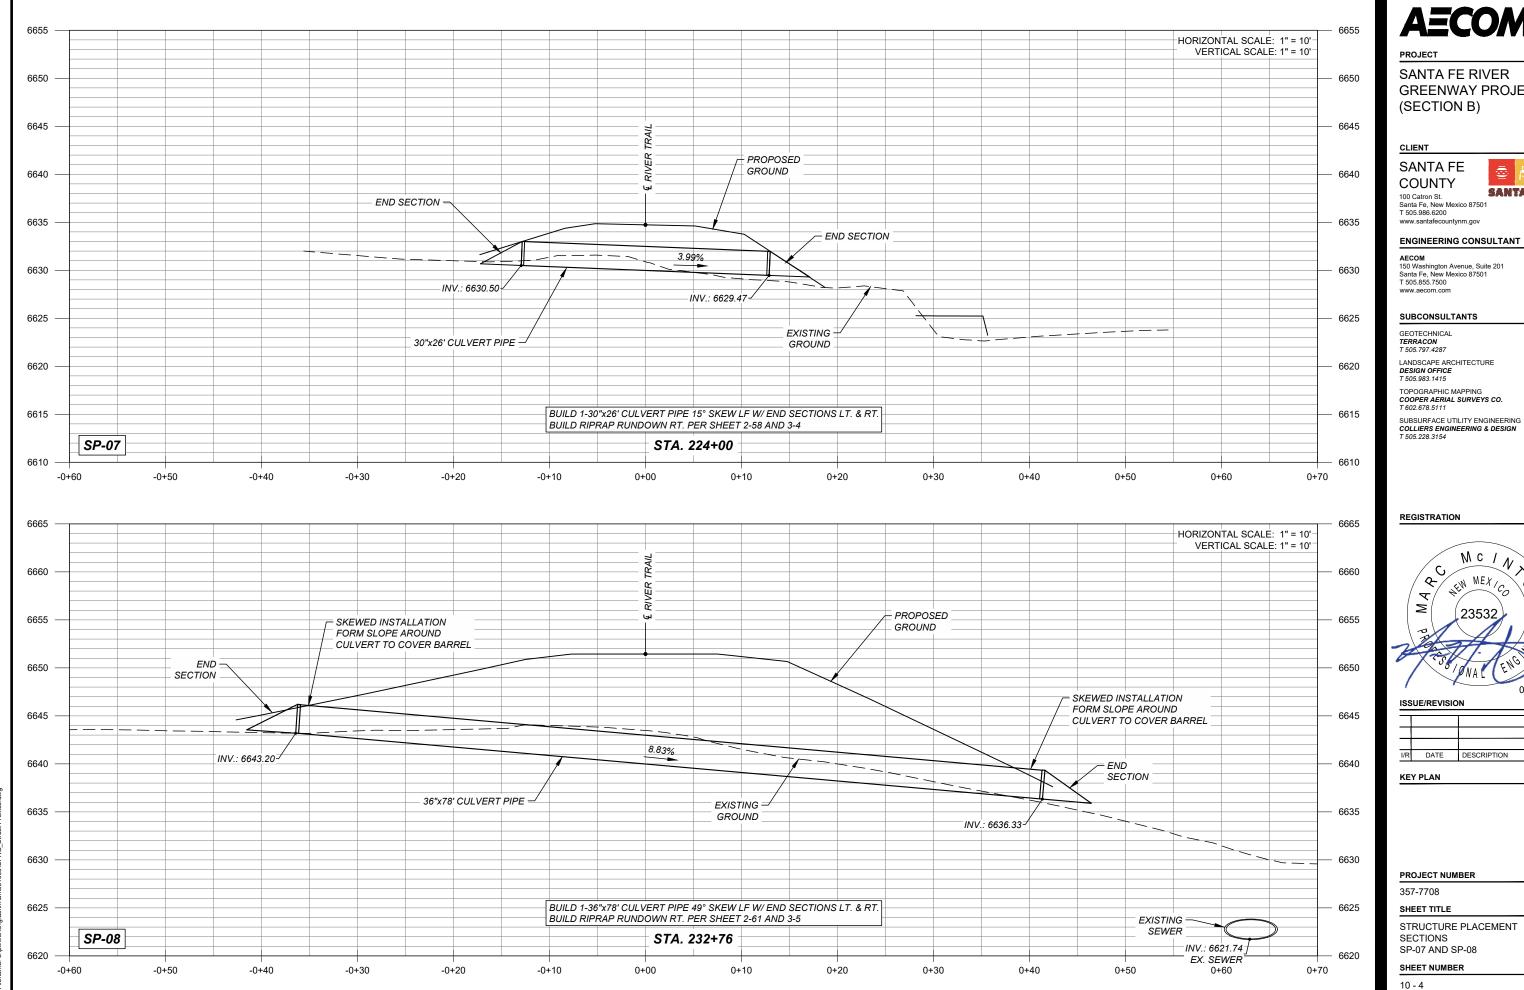

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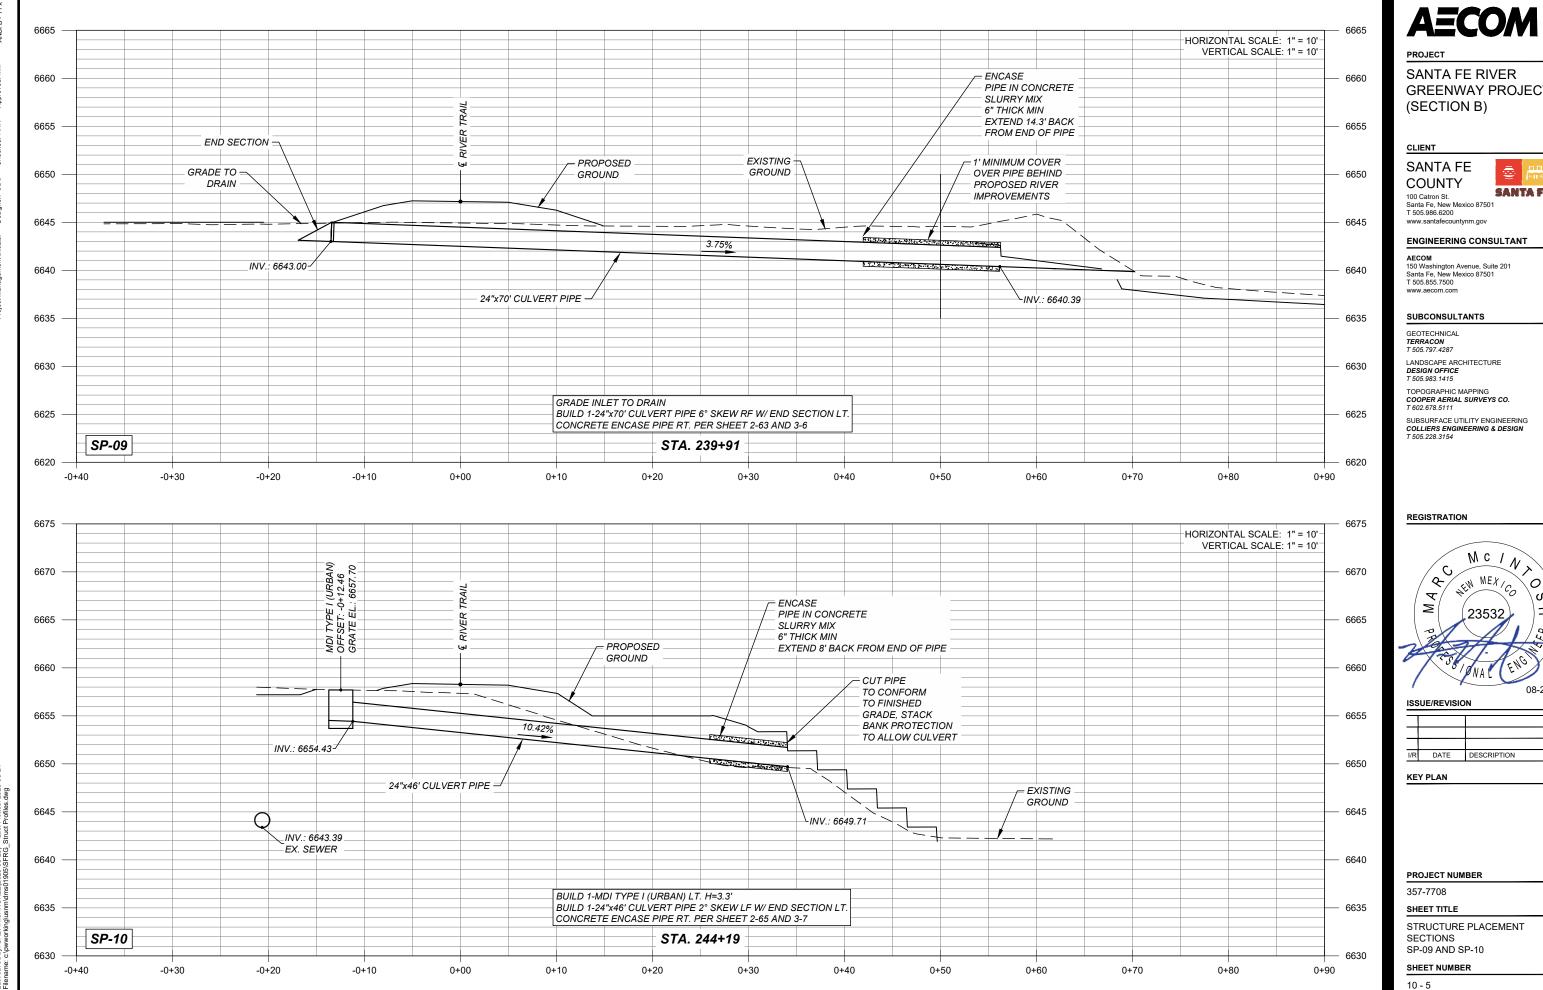
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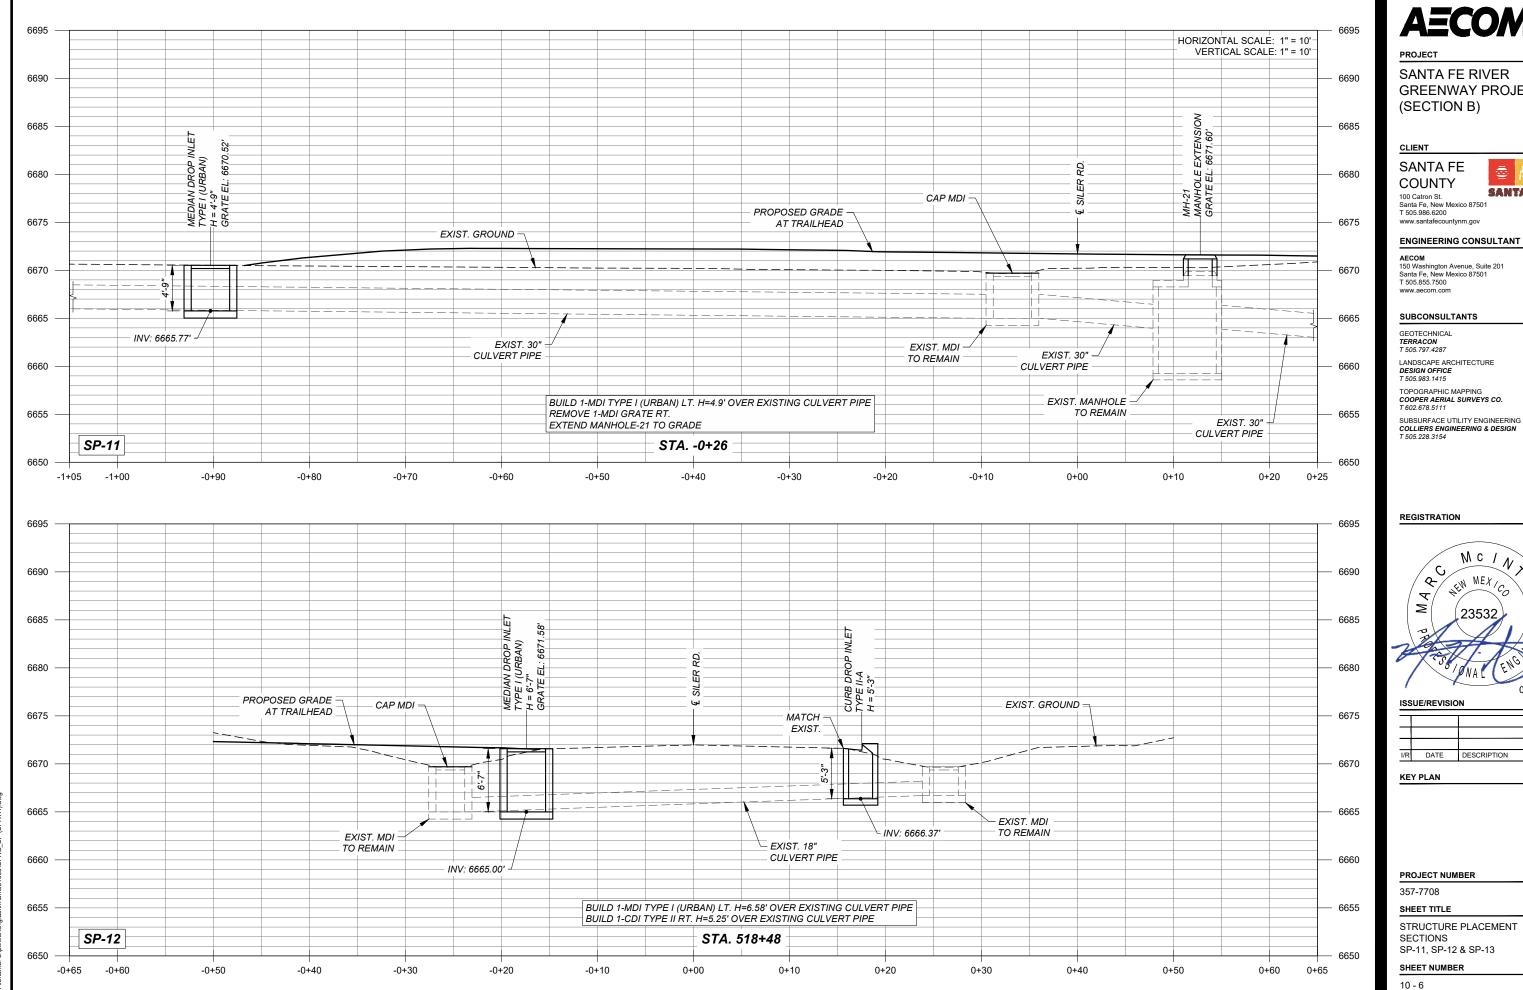
STRUCTURE PLACEMENT



GREENWAY PROJECT

SANTA FE






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PROJECT

SANTA FE RIVER **GREENWAY PROJECT** (SECTION B)

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KEY PLAN

PROJECT NUMBER

357-7708

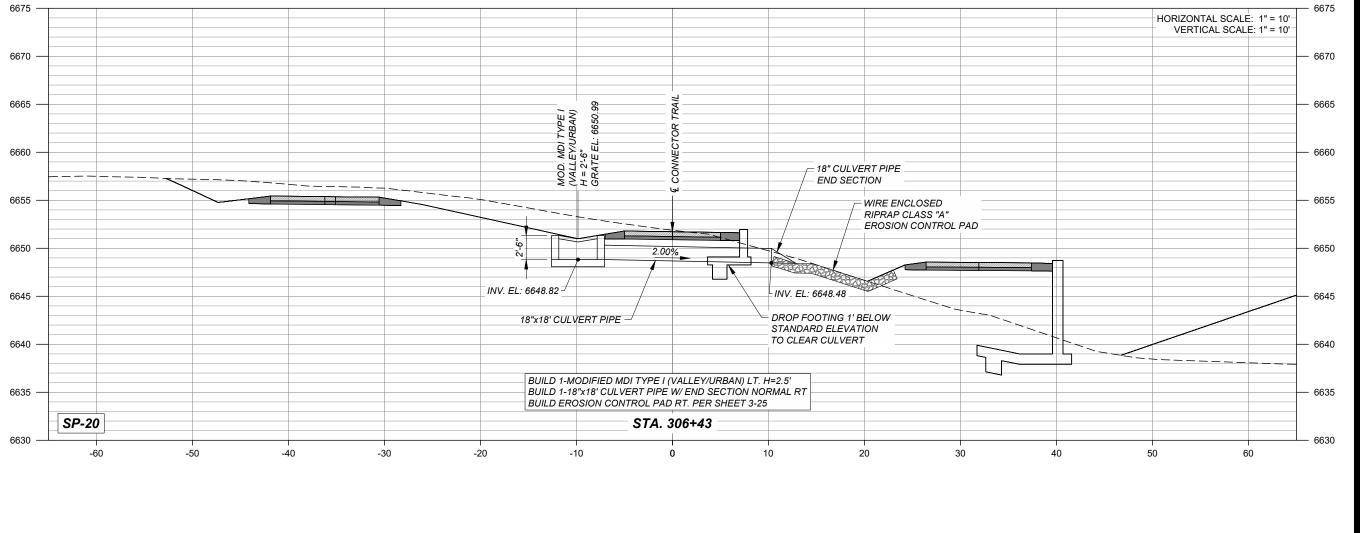SHEET TITLE

STRUCTURE PLACEMENT SECTION (BID ALT. #1) SP-20

SHEET NUMBER

10 - 7

DRAWING SCALE: 1" = 60'



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UTILITY NOTES:

- ALL MANHOLE ADJUSTMENTS SHALL BE CONSTRUCTED IN ACCORDANCE WITH THE
 "SANITART SEWER STANDARD CONSTRUCTION DETAILS" SHOWN ON THE CITY STANDARD
 DRAWINGS.
- A COPY OF THE APPROVED PLANS SHALL BE AVAILABLE AT THE CONSTRUCTION SITE AT ALL TIMES DURING WORKING HOURS.
- 3. ALL MODIFICATIONS TO THE SANITARY SEWER PLANS MUST BE REVIEWED AND APPROVED BY THE CITY'S WASTEWATER MANAGEMENT DIVISION PRIOR TO CONSTRUCTION.
- 4. ADDITIONAL GENERAL NOTES ARE CONTAINED IN THE STANDARD CITY DETAIL SHEETS FOR SANITARY SEWER CONSTRUCTION.
- 5. NO CONCRETE ENCASEMENT OF NEW OR EXISTING PUBLIC SEWER PIPE WILL BE ALLOWED UNLESS APPROVED BY THE CITY OF SANTA FE WASTEWATER MANAGEMENT DIVISION.
- 6. FOR POST CONTRUCTION DRAWINGS, TIE MANHOLE TO A CITY OF SANTA FE SURVEY MONUMENT AS PART OF THE FINAL RECORD DRAWINGS. SHOW CORRECTED AS-BUILT BEARING AND DISTANCES, SLOPES, RIM AND INVERT ELEVATIONS AND SEWER SERVICES ALONG THE HORIZONTAL ALIGNMENT OF THE SANITARY SEWER.
- 7. THE CONTRACTOR SHALL CALL THE WASTEWATER MANAGEMENT DIVISION FOR A FINAL MANHOLE INSPECTION. THIS INSPECTION WILL BE ISOLATED TO THE MANHOLES.

SANTA FE RIVER GREENWAY - SAS MANHOLE LOCATIONS

MANHOLE NUMBER		R TRAIL N - OFFSE	т	EXISTING RIM ELEVATION	PROPOSED RIM ELEVATION	HEIGHT DIFFERENCE	REMARKS	
MH-1	200+27.24;	12.89'	RT.	6595.30'			NO ADJUSTMENT	
MH-2	204+73.63;	12.13'	RT.	6606.18'	6607.32'	1.14'	ONE 1'-0" RISER SECTION AND ONE RISER RING	
MH-3	208+42.19;	22.23'	LT.	6608.58'	6615.00'	6.42'	TWO 3'-0" RISER SECTIONS AND TWO RISER RINGS	
MH-4	210+47.35;	8.90'	RT.	6613.37'	6616.00'	2.63'	ONE 2'-0" RISER SECTION AND FOUR RISER RINGS	
MH-5	212+56.63;	34.31'	RT.	6614.13'			NO ADJUSTMENT	
MH-6	213+83.02;	20.31'	RT.	6616.52'			NO ADJUSTMENT	
MH-7	216+44.83;	10.63'	RT.	6616.95'	6620.50'	3.55'	ONE 3'-0" RISER SECTION AND THREE RISER RINGS	
MH-8	219+89.77;	15.92'	RT.	6619.35'	6623.50'	4.15'	ONE 4'-0" RISER SECTION AND ONE RISER RING	
MH-9	219+91.47;	122.42'	RT.	6622.05'			NO ADJUSTMENT	
MH-10	221+35.01;	208.26'	RT.	6624.15'			NO ADJUSTMENT	
MH-11	223+08.84;	209.28'	RT.	6625.45'			NO ADJUSTMENT	
MH-12	223+96.75;	206.48'	RT.	6627.46'			NO ADJUSTMENT	
MH-13	227+25.21;	194.91'	RT.	6631.92'			NO ADJUSTMENT	
MH-14	229+86.71;	170.74'	RT.	6638.12'			NO ADJUSTMENT	
MH-15	232+81.34;	10.42'	RT.	6643.41'	6650.00'	6.59'	TWO 3'-0" RISER SECTIONS AND FOUR RISER RINGS	
MH-16	234+52.28;	14.22'	RT.	6646.48'			NO ADJUSTMENT	
MH-17	238+19.38;	12.61'	RT.	6648.96'			NO ADJUSTMENT	
MH-18	242+59.95;	9.47'	LT.	6652.24'	6652.50'	0.26'	TWO RISER RINGS	
MH-19	244+04.71;	20.23'	LT.	6657.48'			NO ADJUSTMENT	
MH-20	517+80.11;	30.93'	RT.	6672.05'			NO ADJUSTMENT	
MH-21	518+30.54;	27.08'	LT.	6669.85'	6671.60'	1.75'	ONE 1'-0" RISER SECTION AND 5 RISER RINGS	

BASE BID - ITEM No. 662300 MANHOLE EXTENSION

	III III III OLE EXTENSION						
MANHOLE	ALIGNMENT	STATION	EACH	REMARKS			
MH-02	CL RIVER TRAIL	204+73.63; 12.1' RT	1	MANHOLE			
MH-03	CL RIVER TRAIL	208+42.19; 22.2' LT	1	MANHOLE			
MH-04	CL RIVER TRAIL	210+47.35; 8.9' RT	1	MANHOLE			
MH-07	CL RIVER TRAIL	216+44.83; 10.6' RT	1	MANHOLE			
MH-08	CL RIVER TRAIL	219+89.77; 15.9' RT	1	MANHOLE			
MH-15	CL RIVER TRAIL	232+81.34; 10.4' RT	1	MANHOLE			
MH-18	CL RIVER TRAIL	242+59.95; 9.5' LT	1	MANHOLE			
MH-21	CL SILER RD.	518+30.54; 30.5' LT	1	MANHOLE			
	_	BASE BID TOTAL	8				
		BASE BID USE	8				

UTILITY INFORMATION

UTILITY TYPE	UTILITY OWNER	CONTACT NAME	CONTACT PHONE
SEWER	CITY OF SANTA FE	STAN HOLLAND	(505) 955-4637
GAS	NEW MEXICO GAS COMPANY	FRANK ARAGON	(505) 470-0688
OVERHEAD ELECTRIC	PUBLIC SERVICE COMPANY OF NEW MEXICO	JERROLD ORTEGA	(505) 241-3654
FIBER OPTIC	CENTURYLINK	DOUG DALE	(505) 490-5884

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PROJECT

SANTA FE RIVER GREENWAY PROJECT (SECTION B)

CLIENT

SANTA FE COUNTY



100 Catron St. Santa Fe, New Mexico 87501 T 505.986.6200 www.santafecountynm.gov

ENGINEERING CONSULTANT

AECOM

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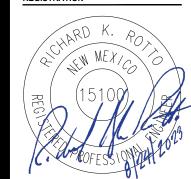
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REGISTRATION



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KEY PLAN


PROJECT NUMBER

357-7708

SHEET TITLE

SANITARY SEWER NOTES AND SCHEDULES

SHEET NUMBER

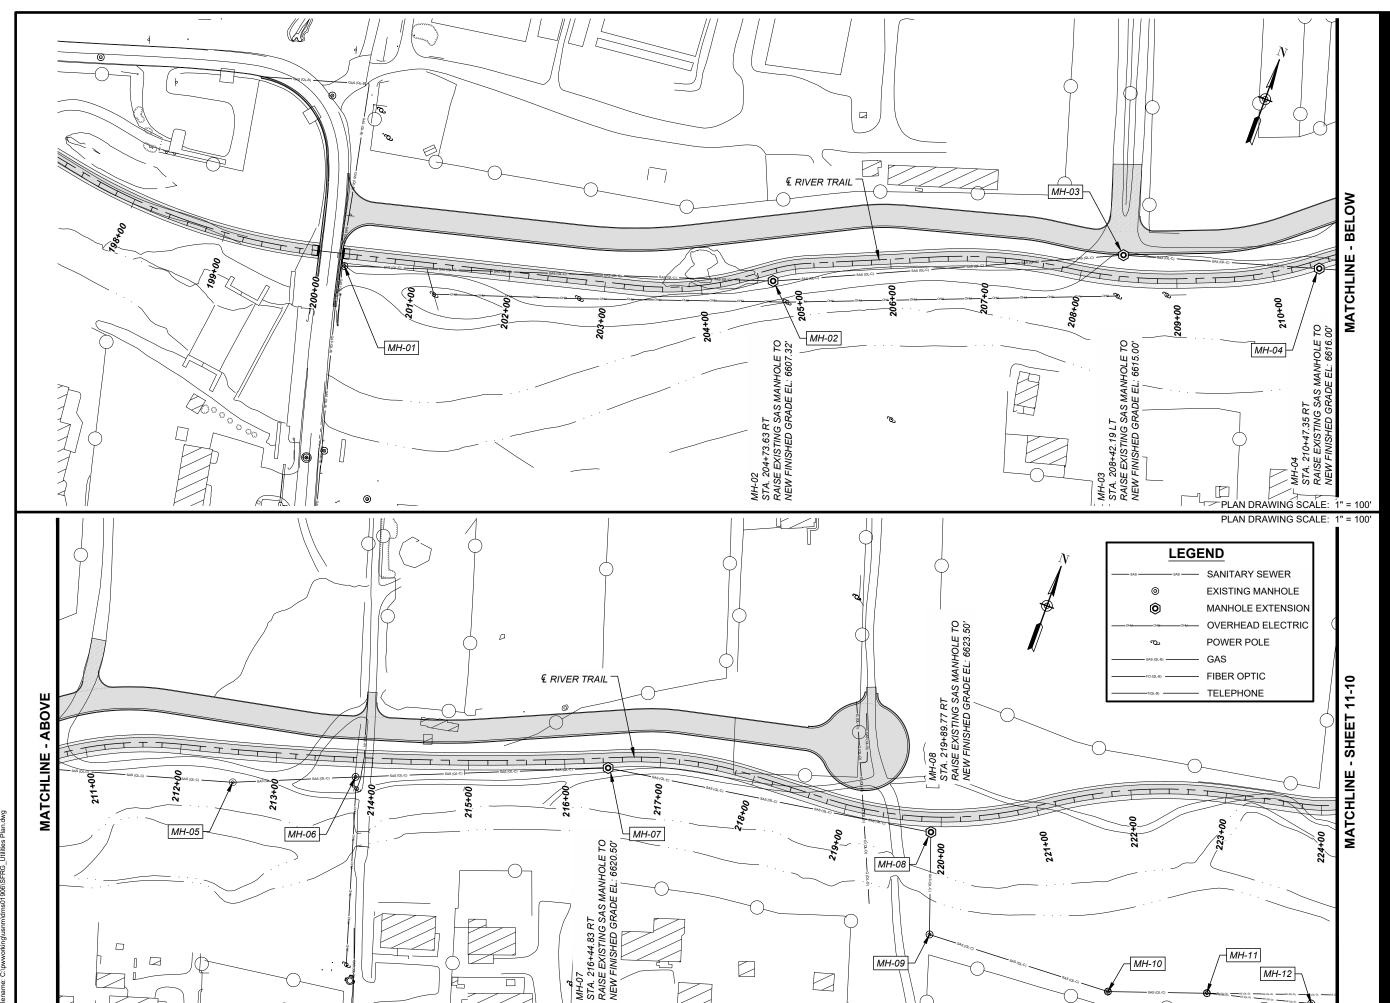

PROJECT

SANTA FE RIVER GREENWAY PROJECT (SECTION B)

CLIEN

SANTA FE COUNTY

SANTA FE

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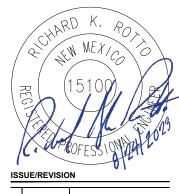
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I/R	DATE	DESCRIPTION

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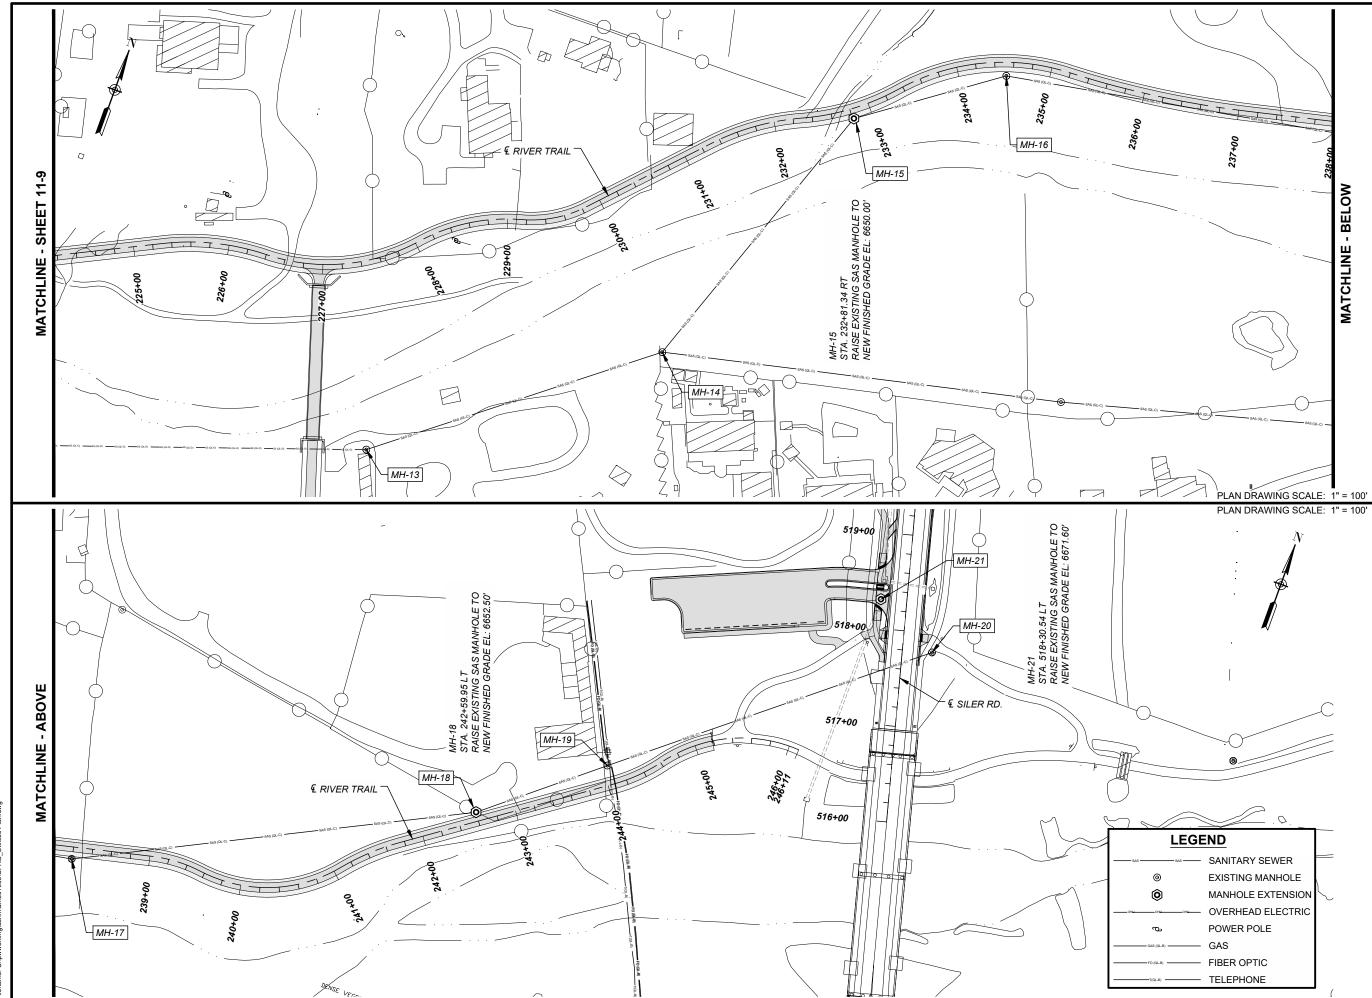
SANITARY SEWER PLAN

SHEET NUMBER









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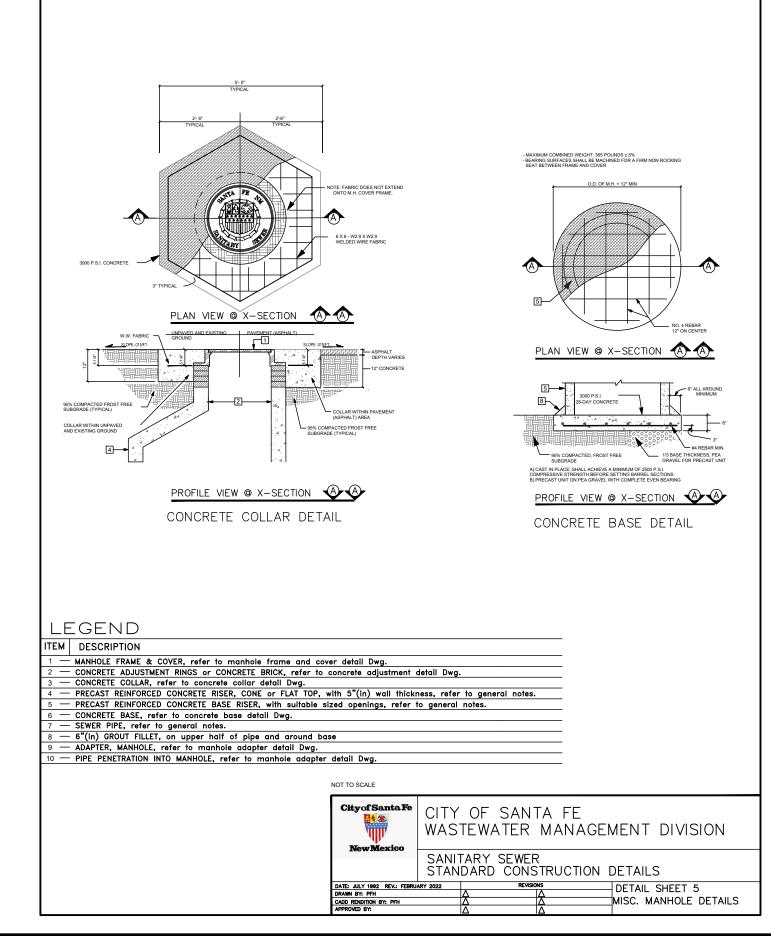
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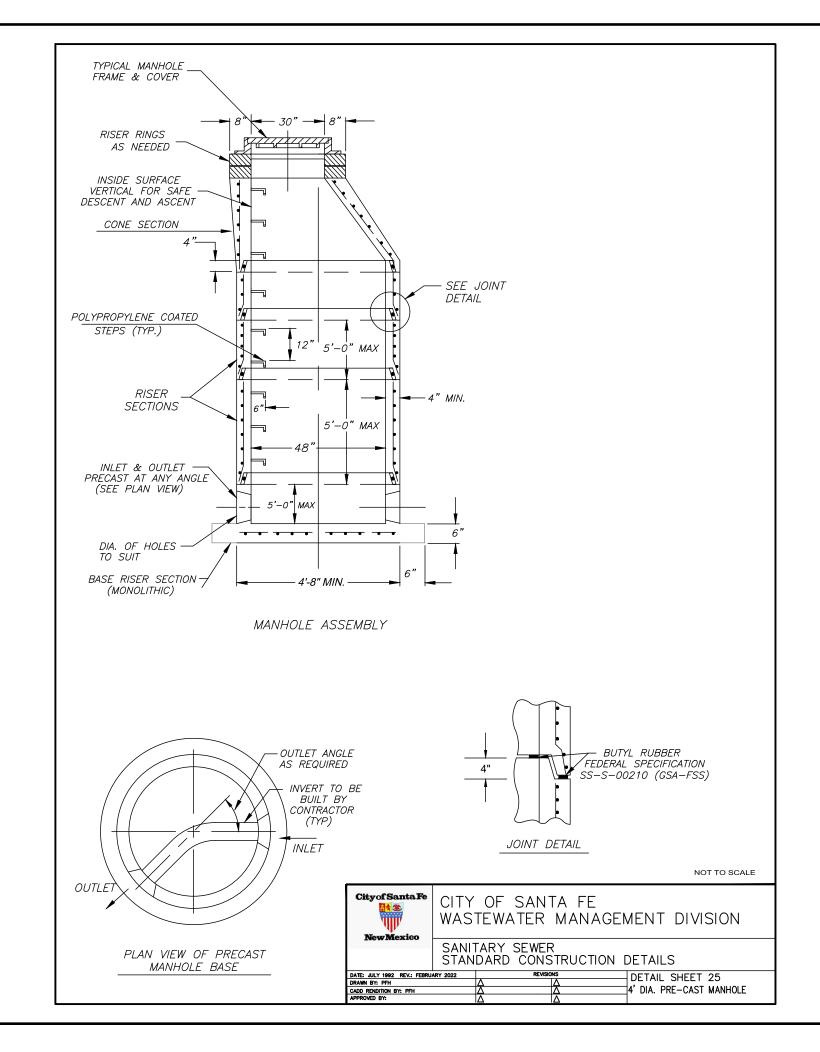
PROJECT NUMBER

357-7708

SHEET TITLE

CITY OF SANTA FE SANITARY SEWER STANDARD CONSTRUCTION DETAILS

SHEET NUMBER



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CLIENT

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357-7708

SHEET TITLE

CITY OF SANTA FE SANITARY SEWER STANDARD CONSTRUCTION DETAILS

SHEET NUMBER

GENERAL CONDITIONS NOTES

- 1. Work performed shall comply with the following:
- A. These General Notes, Construction Documents and Specifications.
 All applicable local, state, and federal codes, ordinances and regulations. All codes listed in Specifications and Drawings shall be inclusive of all codes, regulations and requirements adopted by the State of New Mexico, including all Amendments.
- Source of base information is AECOM and is assumed to be correct. Report any discrepancies immediately to the Owner's representative.
- Verify locations of pertinent site improvements installed under other contracts. If any part of this plan cannot be followed due to site conditions, contact owner's representative for instructions prior to commencing work.
- 4. Contact local underground utility services for utility location and identification, prior to commencing work
- 5. Perform excavation in the vicinity of underground utilities with care and by hand, if necessary. The contractor bears full responsibility for this work and disruption or damage to utilities shall be repaired immediately and at no expense to the owner. No additional compensation or time extension for delays, inconveniences, or damages sustained will be made to contractor due to interferences from utility appurtenances or the operation of moving them resulting from contractor's negligence.
- Field verify all elevations, dimensions, and right-of-way prior to the beginning of construction. The contractor shall limit all work on this project within the existing right-of-way or public easement.

TREE PRESERVATION NOTES

- 1. All existing trees and vegetation stands to be preserved as indicated on the Preservation Plan shall be protected by fence as indicated. The fence shall be firmly anchored into the ground and shall remain upright and intact until all construction activity is complete. Construction activities or material storage shall not occur within these protected areas. Prior to commencing construction, the Contractor shall stake the protective fencing locations in the field and review with the Engineer and Landscape Architect for contractibility. Adjustments to the tree protection as necessary will be made in the field at that time. The location of the protective fencing shall be approved onsite by the Landscape Architect prior to the start of any site work.
- When excavation near a tree to be protected must be carried out, damage can be limited by root pruning. Root pruning shall be completed before grading is started and shall occur beneath the protective fencing as shown on the plan.
- 4. When a tree identified for preservation is damaged or removed due to construction it is the contractor's responsibility to replace the tree with the same species, 8' min height.

SOIL PREPARATION

- Remove existing topsoil with native seed bank from locations designated in the drawings and stockpile on site for future spreading as part of reclamation / reseeding activities. Redistribute topsoil in locations and thickness per landscape plans.
- Prior to the installation of the landscape, contractor to conduct soil test (soil composition / nutrients) of native soils, prepare soil, and add amendments as recommended by testing lab and approved by Landscape Architect to ensure a proper environment for plant root development.
- Contractor to de-compact soils in designated planting areas by roto-tilling, disking or ripping to a depth of 6" minimum.
- 4. After initial soil de-compaction procedures are performed, soil amendments to be added and be mixed thoroughly with existing soil. The addition of soil amendments is determined from soil tests conducted prior to work commencing. Soil amendments may include inorganic material such as sand, silt or clay, which help improve soil texture. Organic material such as compost or manure may also be used and help improve soil structure. Other amendments such as fertilizer improve nutrient content and sulfur adjusts the soil PH level.
- 5. During the landscape installation, various areas of the site may be re-compacted due to the use of equipment and vehicles. This compaction is typically limited to the upper 4-6" of the soil. Prior to the installation of plant material in these areas, the compaction shall be reduced to 80% or less using previously described methods.

LANDSCAPE PLANTING NOTES

- Verify locations of pertinent site improvements installed under other sections. If any part of this plar cannot be followed due to site conditions, contact Landscape Architect for instructions prior to commercian work.
- Exact locations of plant materials to be approved by the Landscape Architect in the field prior to installation. Landscape Architect reserves the right to adjust plants to exact location in field.
- Verify plant counts and square footages: Quantities are provided as Owner information only. If quantities on plant list differ from graphic indications, then graphics shall prevail.
- 4. Contact the local underground utility services for utility location and identification. Perform excavation in the vicinity of underground utilities with care and if necessary, by hand. The Contractor bears full responsibility for this work and disruption or damage to utilities shall be repaired immediately at no expense to the Owner.
- 5. Trees shall bear same relation to finished grade as it bore to existing or specified otherwise
- Trees to be planted a minimum of 4 feet from face of building, or pavement, except as approved by Landscape Architect.
- 7. Provide matching forms and sizes for plant materials within each species and size designated on the drawings.
- Align and equally space in all directions trees and shrubs so designated per these notes and drawings.
- Landscape Architect to review plant materials at source or by photographs prior to digging or shipping of plant materials.
- 10. Revegetate all areas disturbed due to construction activities as outlined in the contract documents Review extent of areas to be revegetated with Landscape Architect prior to commencing work.

POLE + WHIP PLANTING NOTES

Description

- A. Work consists of furnishing and installing all live cuttings (also called poles + whips) for the Planting Zones as specified in the Contract, or as directed by the Contracting Officer.
 B. Prior to the start of work on this item, the Contractor shall submit a proposed construction schedule, including source
- B. Prior to the start of work on this item, the Contractor shall submit a proposed construction schedule, including source of supply of live cuttings, to the Contracting Officer for review and approval. No work shall be performed until this schedule is approved by the Contracting Officer. Installation shall take place when plants are dormant or as soon as possible once they are out of dormancy, no later than May 1.

Materials

A. Live Stakes

- A.1. Live cuttings for live stakes shall be ½ to ¾ inches (½ ¾") in diameter and at least three feet (3') in length. Side branches shall be removed and the bark left intact prior to installation.
- A.2. Live stake cuttings shall consist of a mix of the species indicated in the plant composition schedules. Any one species no more than 50% of the mix.

3. Construction / Installation

A. Preparation

- A.1. The source of all live cuttings shall be from within twenty-five (25) miles of the project site. As possible, cuttings shall be harvested from locations along the Santa Fe River or another riparian corridor within Santa Fe County ownership. Obtain approval for harvesting from the Owner. Harvested material should be limited to no more than 20% of the original plant.
- A.2. It is preferred that live materials are installed the same day that they are harvested. If installation of live materials cannot be accomplished on the same day and storage is required, live materials shall be stored for a period no longer than two (2) days. Any storage of live materials must be approved by the Contracting Officer prior to storing.
- A.3. Live materials must be protected against drying out and overheating before/during transport (e.g., they shall be covered, transported in unheated vehicles, moistened, kept in soak pits and/or buckets with water) and on-site prior to installation (e.g., by storing in controlled conditions, storing in shade, covering with evergreen branches or plastic, placing in moist soil). Live materials shall receive continuous shade, shall be sheltered from the wind, and shall be continuously protected from drying. Where water is available, live branch cuttings shall be sprayed or immersed with water. Warm water (over 150/C) stimulates growth and should be used only upon the approval of the Contracting Officer.

B. Installation

- B.1. Use a rod to create a pilot hole into which the live stake will be installed. It is preferable that the pilot hole diameter be slightly smaller than the diameter of the live stake being installed. A dead-pan hammer may facilitate creation of the hole.
- 3.2. Buds on the stakes shall be oriented in an upward position prior to placing in the pilot hole. The downward end shall be trimmed at a diagonal or tapered to a point to facilitate insertion into the soil.
- B.3. Drive live stakes into the pilot hole so that sixty percent (60%) of the stake is below the ground surface. One live stake should be inserted into each pilot hole.
- Tamp the soil around the stake to increase soil-plant contact and ensure plant growth
- B.5. Trim the emerging aboveground part of the live stake to 6-8" using a horizontal blunt cut. The portion that is trimmed can be installed similarly in another pilot hole.

REVEGETATION SEEDING NOTES

- Erodible Surface Area: All requirements outlined in the Federal Environmental Protection Agency (EPA) National Pollutant Discharge Elimination System (NPDES) and the New Mexico Clean Water Act shall be strictly adhered to during the course of constructing this project. Exposed areas of disturbance shall be kept to a minimum to perform project construction and shall be protected by the application of tackifier as stated below and any other sediment control devices required until permanent measures are applied.
- Prior to commencing the seeding operation, the Project Manager, Landscape Architect, and Seeding Contractor's
 Representative shall review areas to be treated to determine the appropriate class of seeding and to ensure that slopes have
 been constructed properly. Seeding equipment shall also be inspected during this period to ensure proper operation. Any
 work done prior to this inspection shall be rejected. All areas to be seeded shall be as directed by the Project Manager and /
 or the Landscape Architect.
- Areas 4:1 or flatter shall be treated with NMDOT Class "A" seeding techniques; areas with slopes 3:1 or steeper requiring revegetation shall be treated with NMDOT Class "C" seeding techniques. See Landscape Drawings for Revegetation Seeding Class designations to be installed per NMDOT Specification 632 Revegetation.
- 4. Seed mixes shall be as follows:

SEED MIX C: Native Grass seed mix shall be as follows:

Botanical Name	Common Name	Rate
Boutelua gracilis "Hatchila"	Blue Grama	7.0 lb. live seed/Acre
Oryzopsis hymenoides	Indian Ricegrass	2.0 lb. live seed/Acre
Bouteloua curtipendula "Niner"	Sideoats Grama	4.0 lb. live seed/Acre
Hilaria jamesii	Galleta	2.0 lb. live seed/Acre
Buchloe dactyloides	Buffalograss	2.0 lb. live seed/Acre
Sporobolus airoides	Alkali Sacaton	2.0 lb. live seed/Acre
Agropyron scoparium	Little Bluestem	2.0 lb. live seed/Acre

SEED MIX B: Native Grass and Shrub seed mix

Mix shrub seed mix (below) with SEED MIX C (above) for rain gardens, swales, and bio-swale as follows:

Botanical Name_	Common Name	<u>Rate</u>
(rasheninnikovia lanata	Winterfat	0.25 lb. live seed/Acre
allugia paradoxa	Apache Plume	0.125 lb. live seed/Acr
/ucca glauca	Narrowleaf Yucca	0.25 lb. live seed/Acre

SEED MIX A: Native Grass and Wildflower seed mix:

Mix SEED MIX C (above) with wildflower seed 'High Plains Seed Mix' by Plants of the Southwest 3095 Agua Fria St. Santa Fe, NM 87507. Phone: (505)438-888, or approved equal. Seed mix rate: 1.0 lb/6400 SF. Distribute in designated areas prior to installing mulch. Confirm wildflower seeding areas prior to ordering seed.

Botanical Name	Common Name	Botanical Name	Common Name
Liatris punctata	Spotted Gayfeather	Mirabilis multiflora	Desert 4 O'Clock
Coreopsis lanceolata	Lanceleaf Coreopsis	Antirrhinum majus	Pink Wild Snapdragon
Eschsholzia californica	California Poppy	Penstemon strictus	Rocky Mt. Penstemon
Gaillardia pulchella	Firewheel	Ratibida columnifera	Mexican Hat
Ipomopsis aggregata	Skyrocket	Ratibida pinnata	Yellow Prairie Coneflowe
Iris missouriensis	Western Blue Flag	Berlandiera lyrata	Chocolate Flower
Linum lewisii	Blue Flax	Cleome serrulata	Rocky Mountain Beeplan

LANDSCAPE SCHEDULE

ITEM No. 664000 - LANDSCAPE COMPLETE BASE BID

LINE ITEM	DESCRIPTION	UNIT	ESTIMATED QUANTITY
1	TREE PRESERVATION FENCING	LF	3,000
2	PLANT SALVAGING	LS	LS
3	TOP SOIL STOCKPILING / REDISTRIBUTION	CY	1,400
4	WILLOW CUTTINGS- BANK PROTECTION (8' LENGTH IN 8" DIA SONOTUBE, 3 CUTTINGS PER HOLE)	EA	160
5	SHRUBS, CONTAINER (1 GAL)	EA	250
6	TREES, CONTAINER (15 GAL)	EA	80
7	WHIPS (8' LENGTH)	EA	360
9	POLES (12'-16' LENGTH)	EA	150
10	AMENDED BACKFILL (ORGANIC MULCH / SAND, 18" DEPTH)	CY	140
11	COBBLE, MULCH 4"-8" ANGULAR	CY	450
12	GRAVEL, MULCH 1" ANGULAR	CY	90
13	CHECK DAM, DRY STACKED STONE	EA	6
14	BOULDERS	EA	20
15	MISC. GRADING	LS	LS
16	CLASS 'A' SEEDING - SEED MIX A	AC	4.00
17	CLASS 'A' SEEDING - SEED MIX B	AC	1.00
18	CLASS 'C' SEEDING - SEED MIX C	AC	5.00
19	LANDSCAPE GRADING	LS	LS
20	WATERING, ESTABLISHMENT, AND MAINTENANCE	LS	LS
21	WAYFINDING SIGNAGE	LS	LS

ITEM No. 664000 - LANDSCAPE COMPLETE ADD ALT 1

LINE	DESCRIPTION	UNIT	ESTIMATED QUANTITY
1	TREE PRESERVATION FENCING	LF	250
2	TOP SOIL STOCKPILING / REDISTRIBUTION	CY	160
3	BOULDERS	EA	6
4	CLASS 'A' SEEDING - SEED MIX A	AC	0.15
5	CLASS 'C' SEEDING - SEED MIX C	AC	0.50
6	WATERING, ESTABLISHMENT, AND MAINTENANCE	LS	LS
7	WAYFINDING SIGNAGE	LS	LS

NOTE:

ALL LABOR, MATERIALS, EQUIPMENT, AND OTHER INCIDENTALS NECESSARY TO COMPLETE THE WORK LISTED ABOVE AND DETAILS IN THE LANDSCAPE PLANS SHALL BE CONSIDERED AS INCLUDED IN THE UNIT BID PRICE FOR ITEM No. 664000 - LANDSCAPE COMPLETE AND NO SEPARATE MEASUREMENT OR PAYMENT WILL BE MADE.

A=COM

PROJECT

SANTA FE RIVER GREENWAY PROJECT (SECTION B)

CLIENT

SANTA FE COUNTY



Santa Fe, New Mexico 87501 T 505.986.6200 www.santafecountynm.gov

ENGINEERING CONSULTANT

AECOM

150 Washington Avenue, Suite 201 Santa Fe, New Mexico 87501 T 505.855.7500 www.aecom.com

SUBCONSULTANTS

GEOTECHNICAL TERRACON T 505.797.4287

LANDSCAPE ARCHITECTURE DESIGN OFFICE T 505.983.1415

TOPOGRAPHIC MAPPING
COOPER AERIAL SURVEYS CO.
T. 602 678 5411

SUBSURFACE UTILITY ENGINEERING COLLIERS ENGINEERING & DESIGN T 505.228.3154

REGISTRATION



ISSUE/REVISION

I/R	DATE	DESCRIPTION

KEY PLAN

PROJECT NUMBER

357-7708

SHEET TITLE


GENERAL NOTES + LANDSCAPE SCHEDULE

SHEET NUMBER







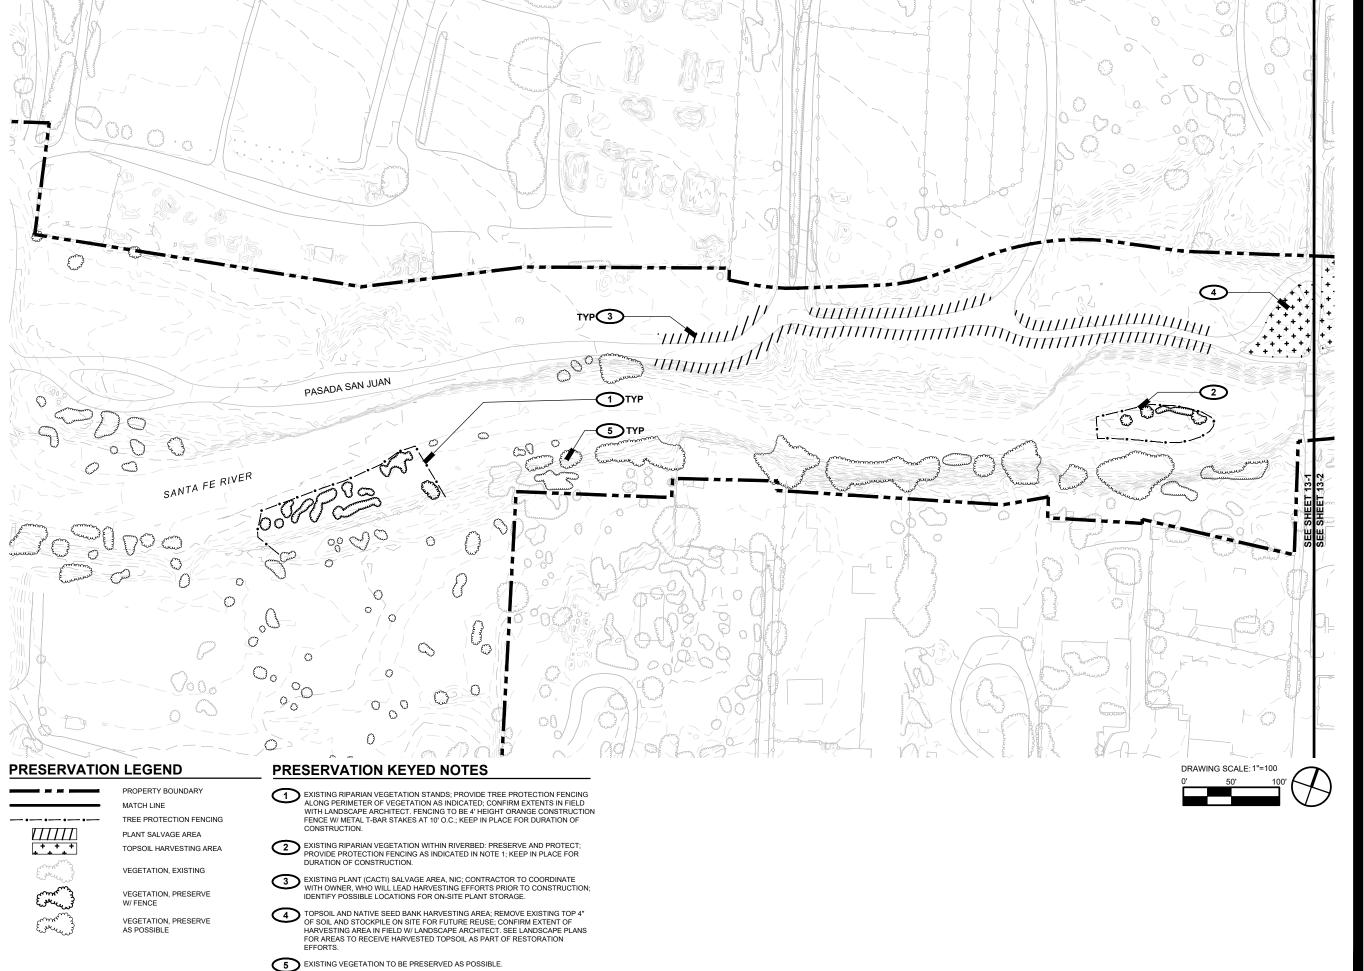



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CLIENT

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GEOTECHNICAL TERRACON

T 505.797.4287 LANDSCAPE ARCHITECTURE

DESIGN OFFICET 505.983.1415

TOPOGRAPHIC MAPPING COOPER AERIAL SURVEYS CO. T 602.678.5111

SUBSURFACE UTILITY ENGINEERING COLLIERS ENGINEERING & DESIGN T 505.228.3154

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I/R	DATE	DESCRIPTION

KEY PLAN



PROJECT NUMBER

357-7708

SHEET TITLE

LANDSCAPE PRESERVATION PLAN


SHEET NUMBER



VEGETATION, EXISTING

VEGETATION, PRESERVE

VEGETATION, PRESERVE

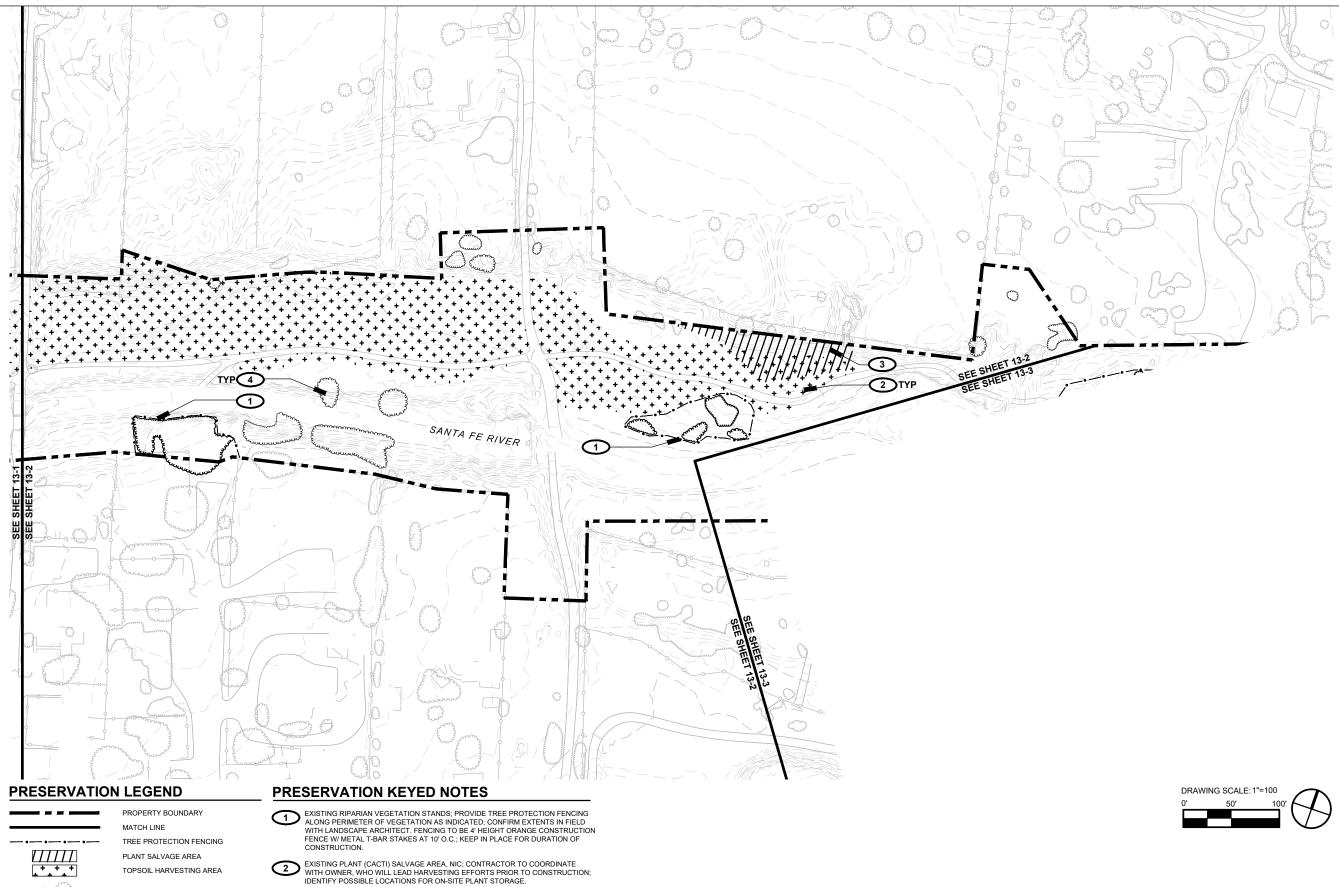

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SANTA FE COUNTY



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	I/R	DATE	DESCRIPTION

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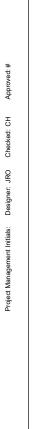
357-7708


SHEET TITLE

LANDSCAPE PRESERVATION

SHEET NUMBER

- TOPSOIL AND NATIVE SEED BANK HARVESTING AREA; REMOVE EXISTING TOP 4"
 OF SOIL AND STOCKPILE ON SITE FOR FUTURE REUSE; CONFIRM EXTENT OF
 HARVESTING AREA IN FIELD W/LANDSCAPE ARCHITECT. SEE LANDSCAPE PLANS
 FOR AREAS TO RECEIVE HARVESTED TOPSOIL AS PART OF RESTORATION
- 4 EXISTING VEGETATION TO BE PRESERVED AS POSSIBLE.



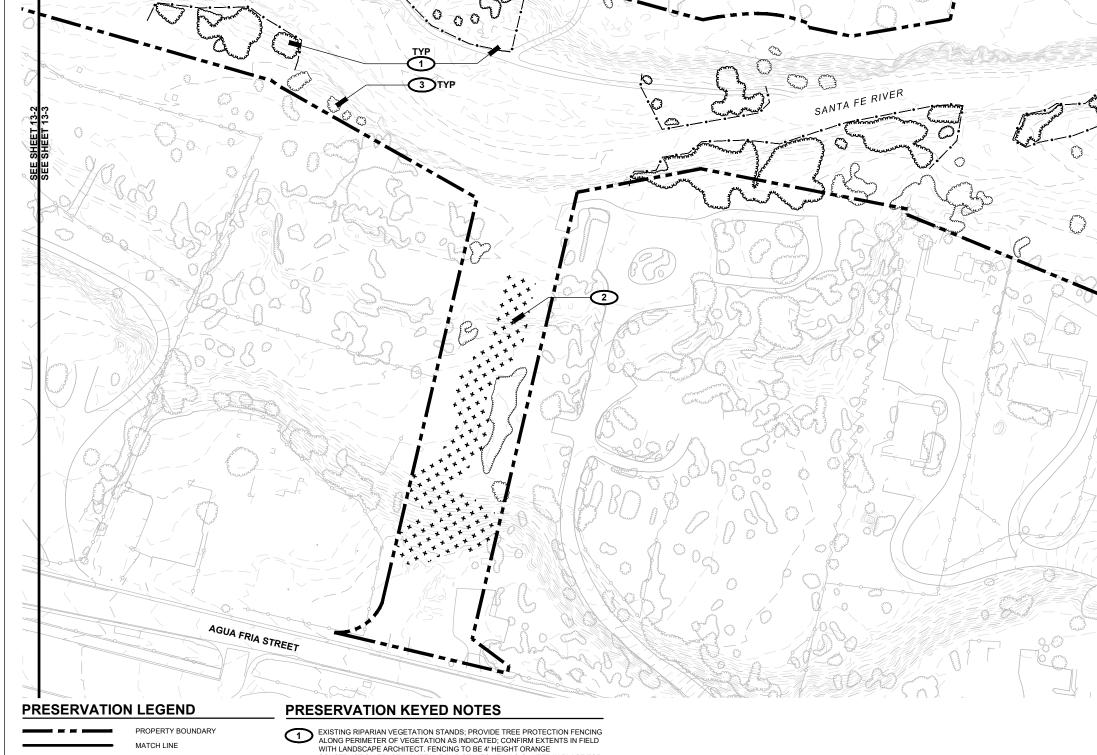

SANTA FE RIVER **GREENWAY PROJECT** (SECTION B)

CLIENT

SANTA FE COUNTY

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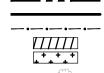
PROJECT NUMBER

357-7708

SHEET TITLE

LANDSCAPE PRESERVATION PLAN

SHEET NUMBER



TREE PROTECTION FENCING

SEE SHEET 13-2

PLANT SALVAGE AREA TOPSOIL HARVESTING AREA

VEGETATION, EXISTING

AS POSSIBLE


VEGETATION, PRESERVE

VEGETATION, PRESERVE

EXISTING RIPARIAN VEGETATION STANDS; PROVIDE TREE PROTECTION FENCING ALONG PERIMETER OF VEGETATION AS INDICATED; CONFIRM EXTENTS IN FIELD WITH LANDSCAPE ARCHITECT. FENCING TO BE 4' HEIGHT ORANGE CONSTRUCTION FENCE WI METAL T-BAR STAKES AT 10' O.C.; KEEP IN PLACE FOR DURATION OF CONSTRUCTION.

TOPSOIL AND NATIVE SEED BANK HARVESTING AREA; REMOVE EXISTING TOP 4* OF SOIL AND STOCKPILE ON SITE FOR FUTURE REUSE; CONFIRM EXTENT OF HARVESTING AREA IN FIELD W/ LANDSCAPE ARCHITECT. SEE LANDSCAPE PLANS FOR AREAS TO RECEIVE HARVESTED TOPSOIL AS PART OF RESTORATION EFFORTS.

3 EXISTING VEGETATION TO BE PRESERVED AS POSSIBLE.

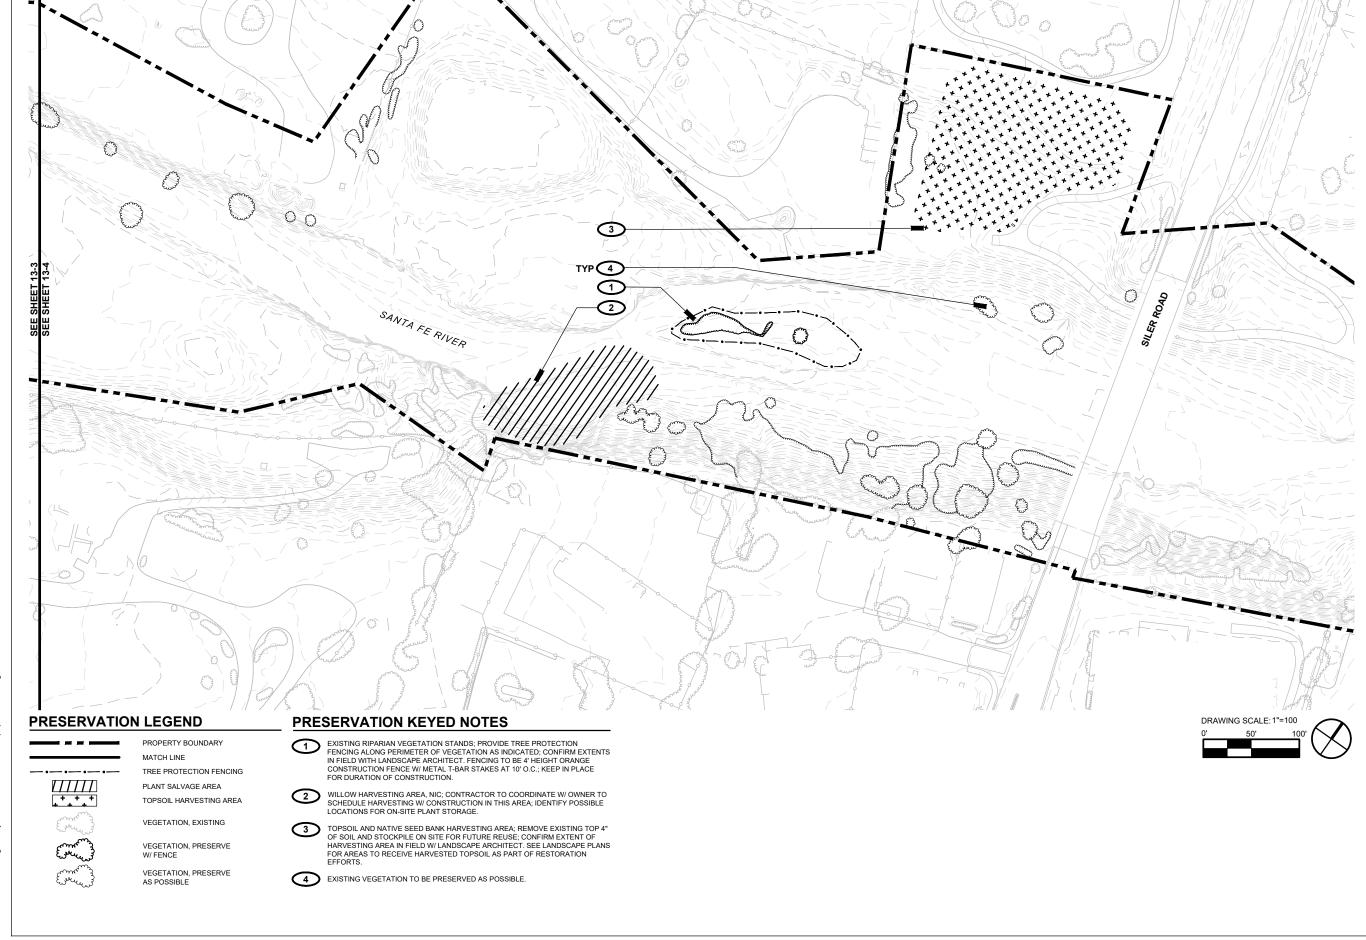



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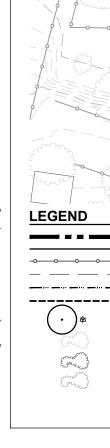
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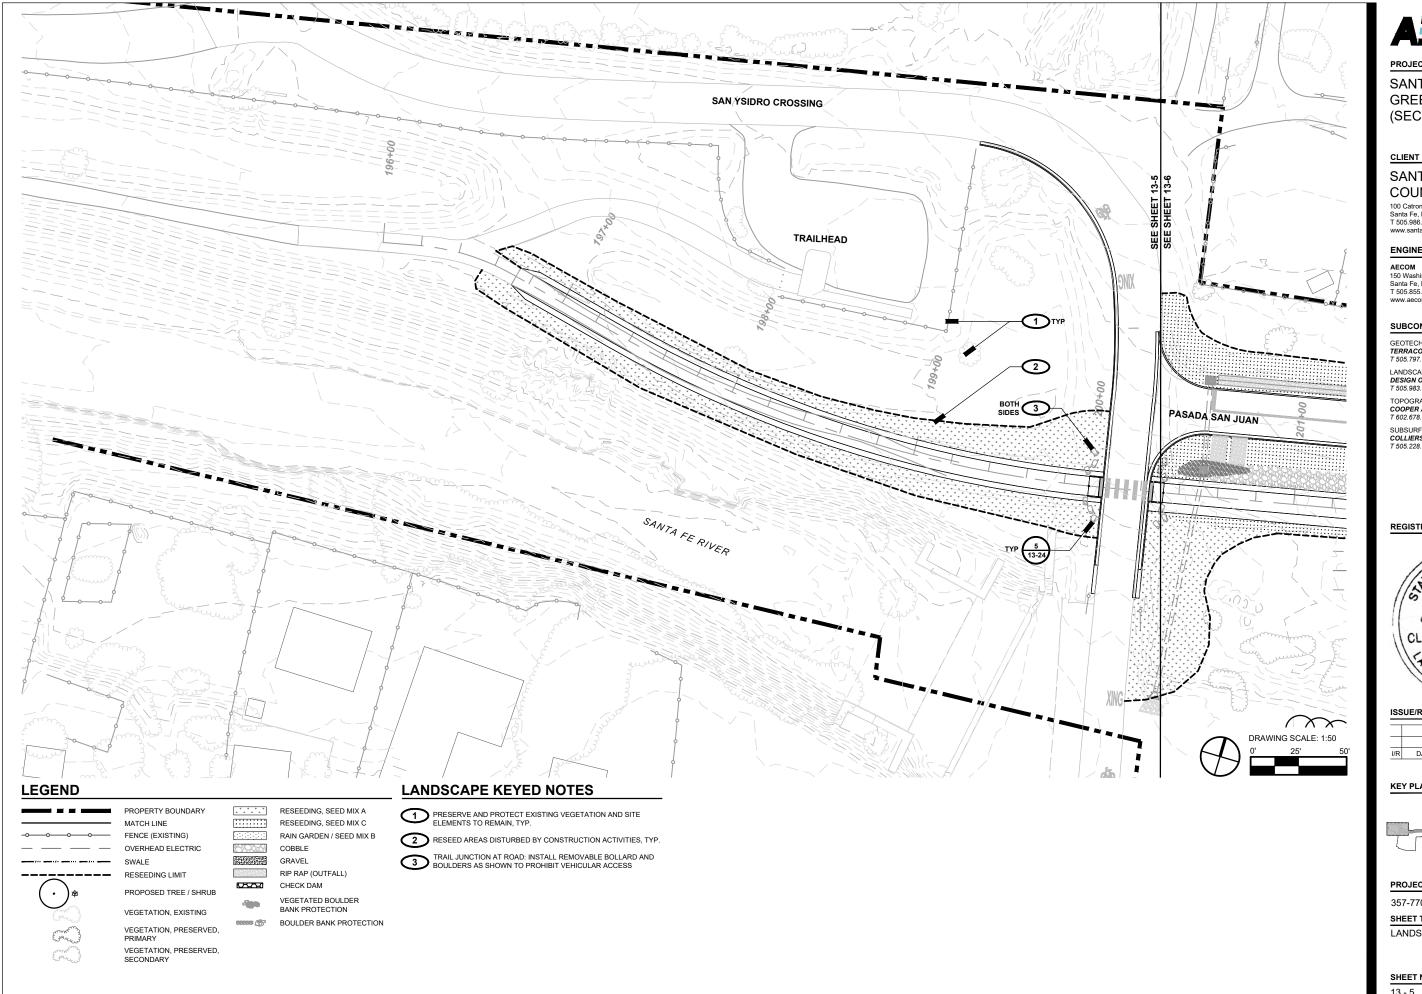
SHEET TITLE

LANDSCAPE PRESERVATION

SHEET NUMBER







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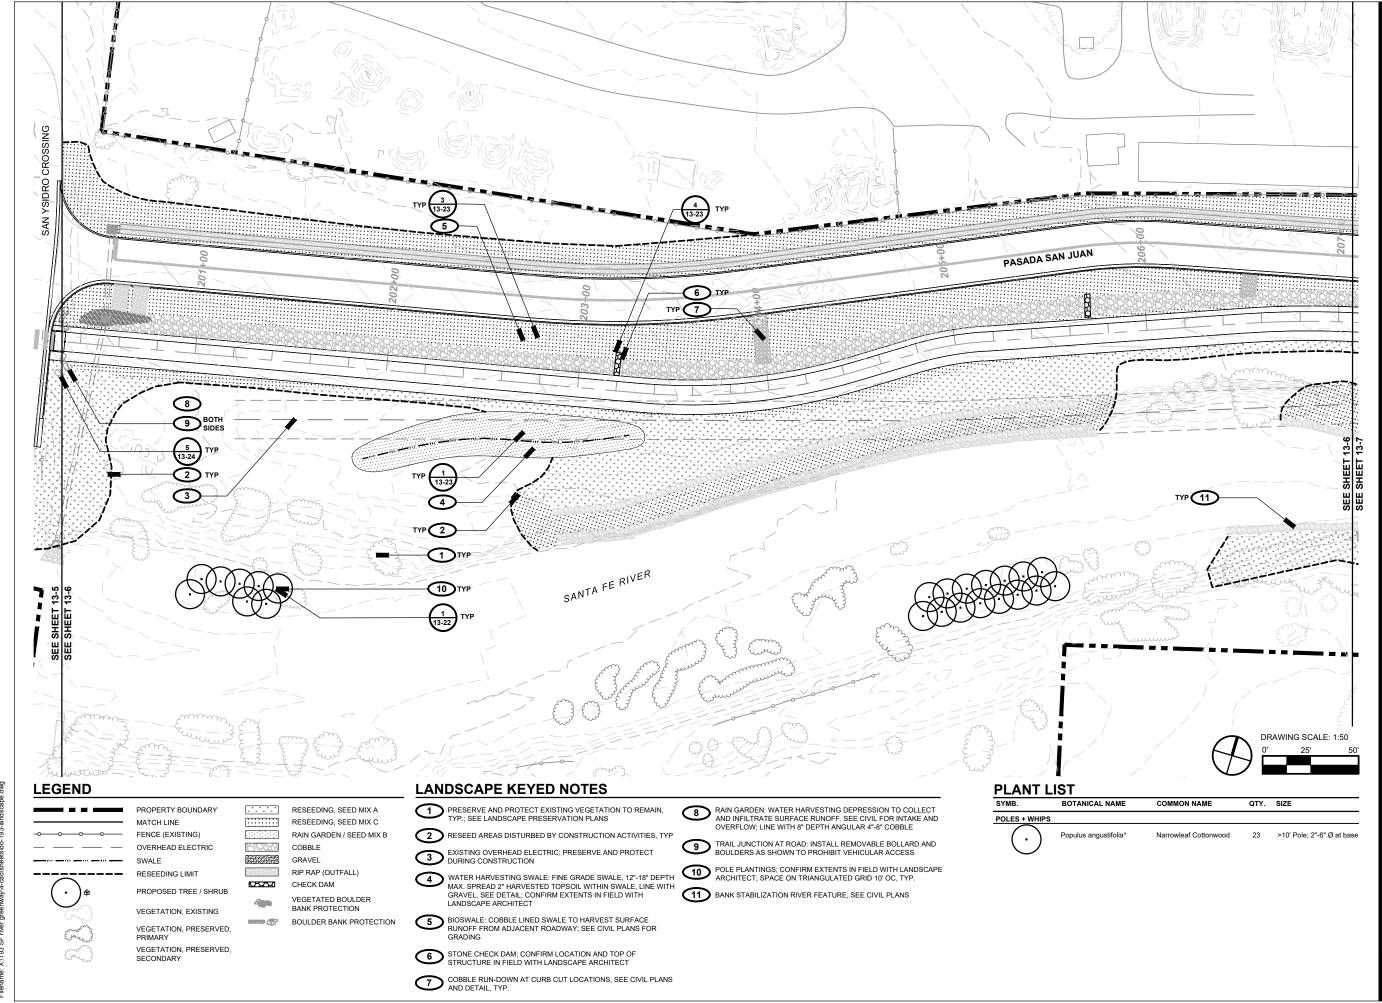


PROJECT NUMBER

357-7708

SHEET TITLE

LANDSCAPE PLAN



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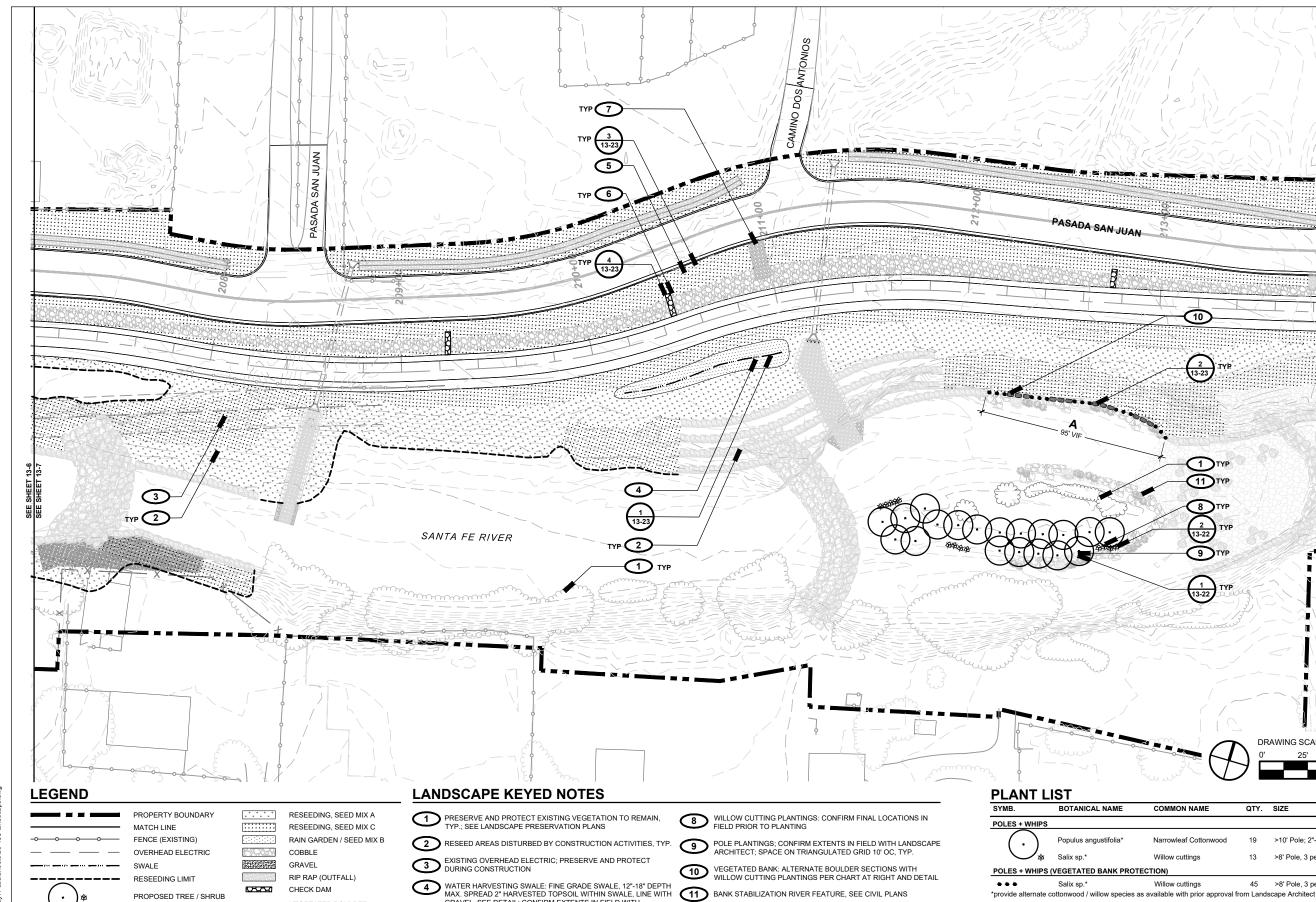
PROJECT NUMBER

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SHEET TITLE

LANDSCAPE PLAN

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8 TYI

9 TYP

VEGETATED BANK SEQUENCE CHART

/ LENGTH

10' LENGTH

5 SEGMENTS AT

Α

PLAN ID VEGETATED SEGMENTS | BOULDER SEGMENTS | PLAN DIAGRAM (NTS)

/ LENGTH

4 / ±12'

QTY. SIZE

>10' Pole; 2"-6" Ø at base

>8' Pole, 3 per hole

45 >8' Pole, 3 per hole



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I/R DATE I	DESCRIPTION

KEY PLAN



PROJECT NUMBER

357-7708

SHEET TITLE LANDSCAPE PLAN

SHEET NUMBER

GRAVEL, SEE DETAIL; CONFIRM EXTENTS IN FIELD WITH LANDSCAPE ARCHITECT

5 BIOSWALE: COBBLE LINED SWALE TO HARVEST SURFACE RUNOFF FROM ADJACENT ROADWAY; SEE CIVIL PLANS FOR

6 STONE CHECK DAM; CONFIRM LOCATION AND TOP OF STRUCTURE IN FIELD WITH LANDSCAPE ARCHITECT

VEGETATED BOULDER

BOULDER BANK PROTECTION

BANK PROTECTION


VEGETATION, EXISTING

VEGETATION, PRESERVED,

VEGETATION PRESERVED

SECONDARY

COBBLE RUN-DOWN AT CURB CUT LOCATIONS, SEE CIVIL PLANS AND DETAIL, TYP.

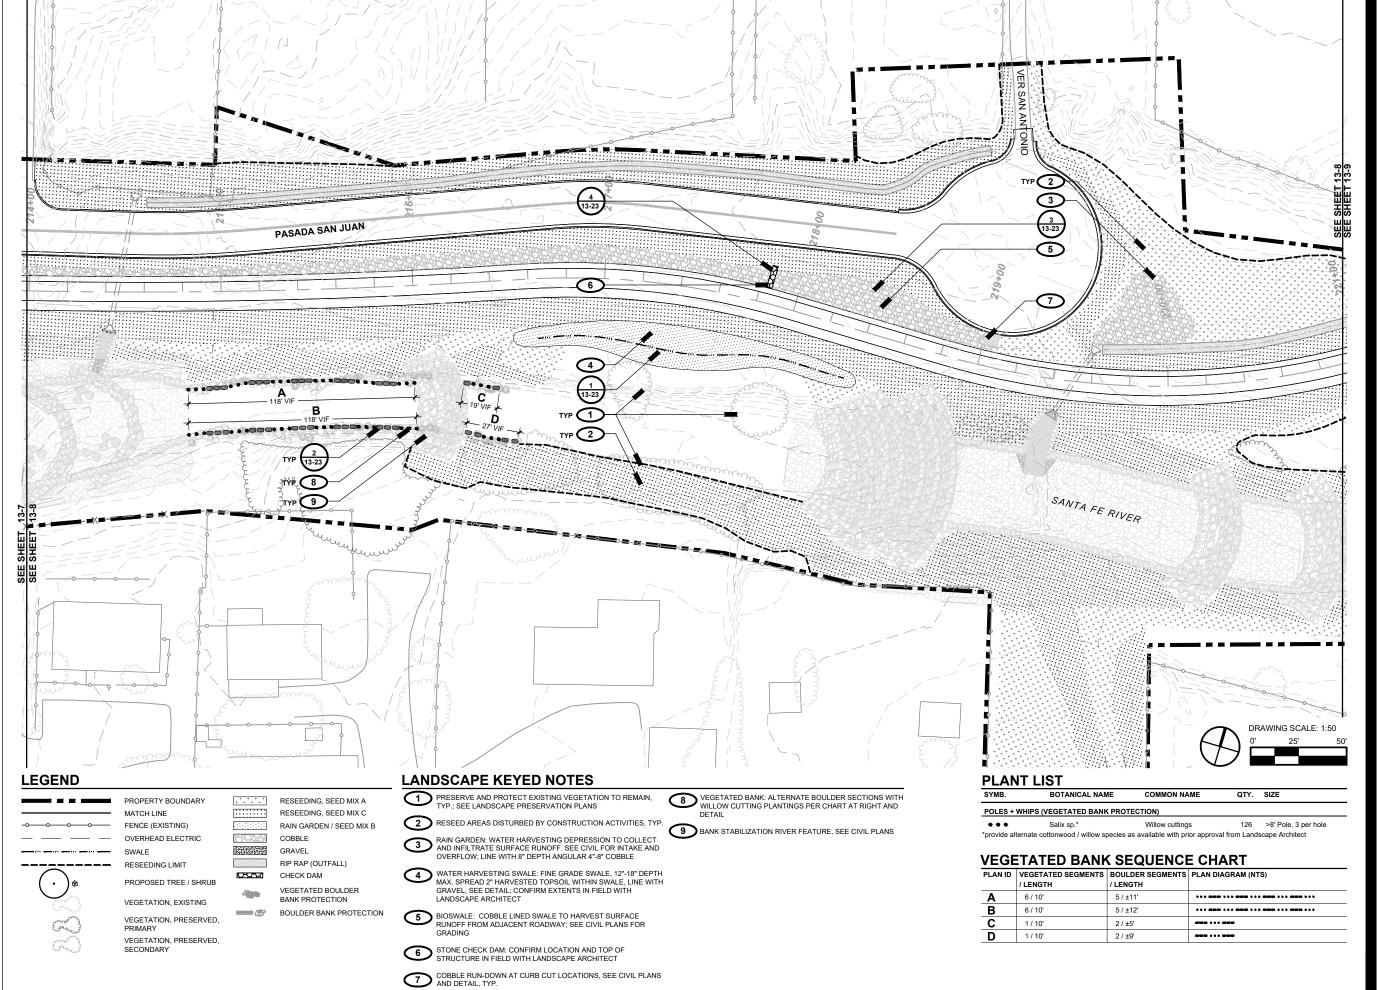

PROJECT

SANTA FE RIVER GREENWAY PROJECT (SECTION B)

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KEY PLAN




PROJECT NUMBER

357-7708

SHEET TITLE

LANDSCAPE PLAN

SHEET NUMBER

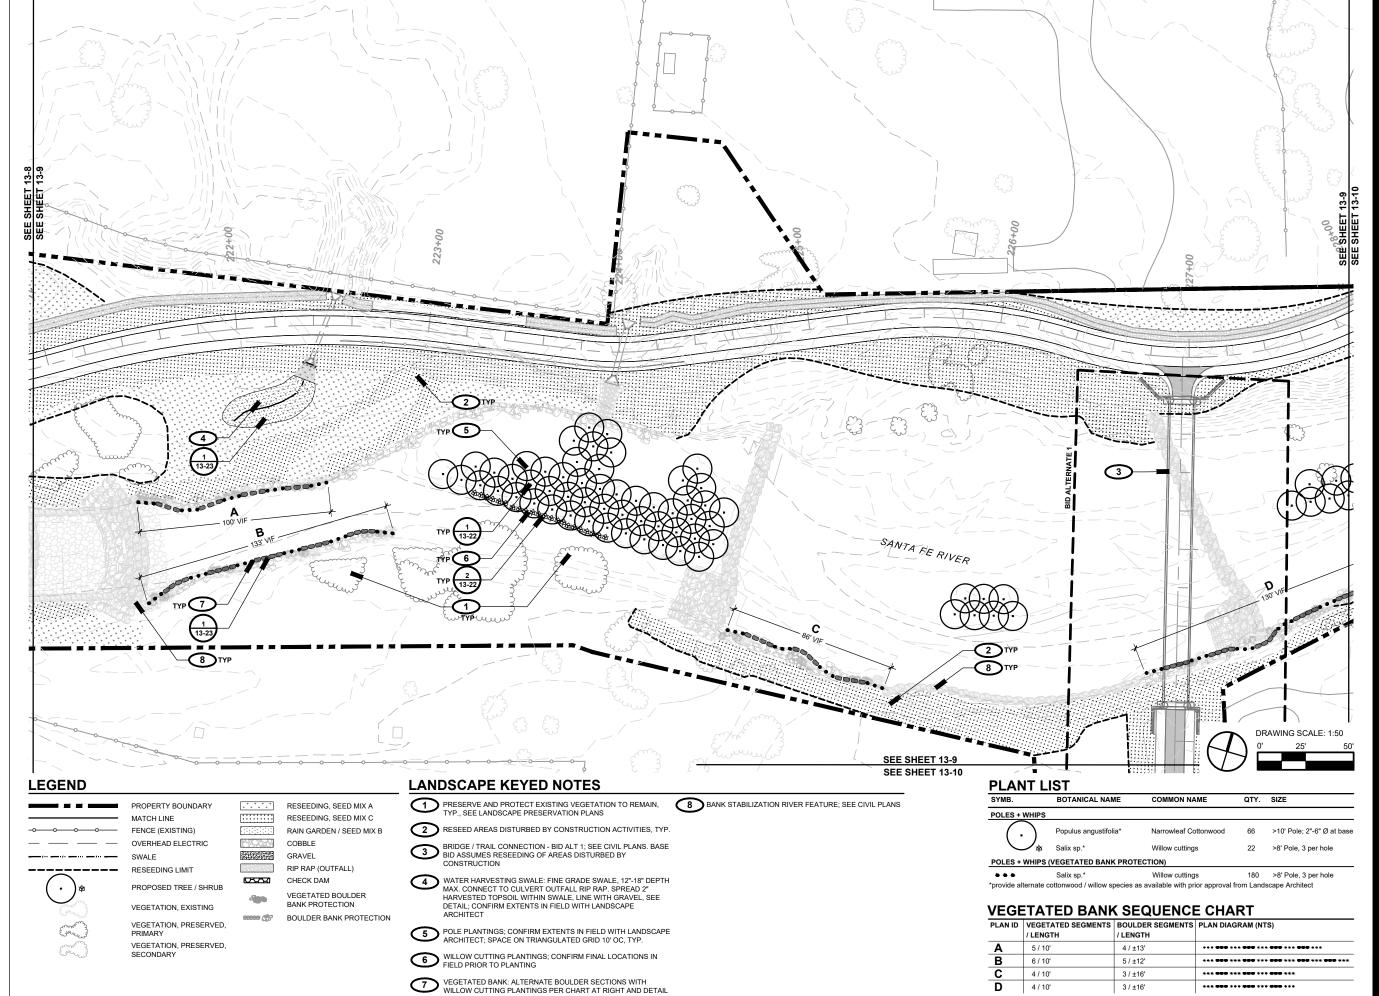

PROJECT

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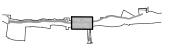
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KEY PLAN





PROJECT NUMBER

357-7708

SHEET TITLE
LANDSCAPE PLAN

SHEET NUMBER

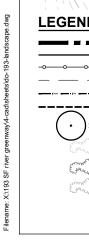

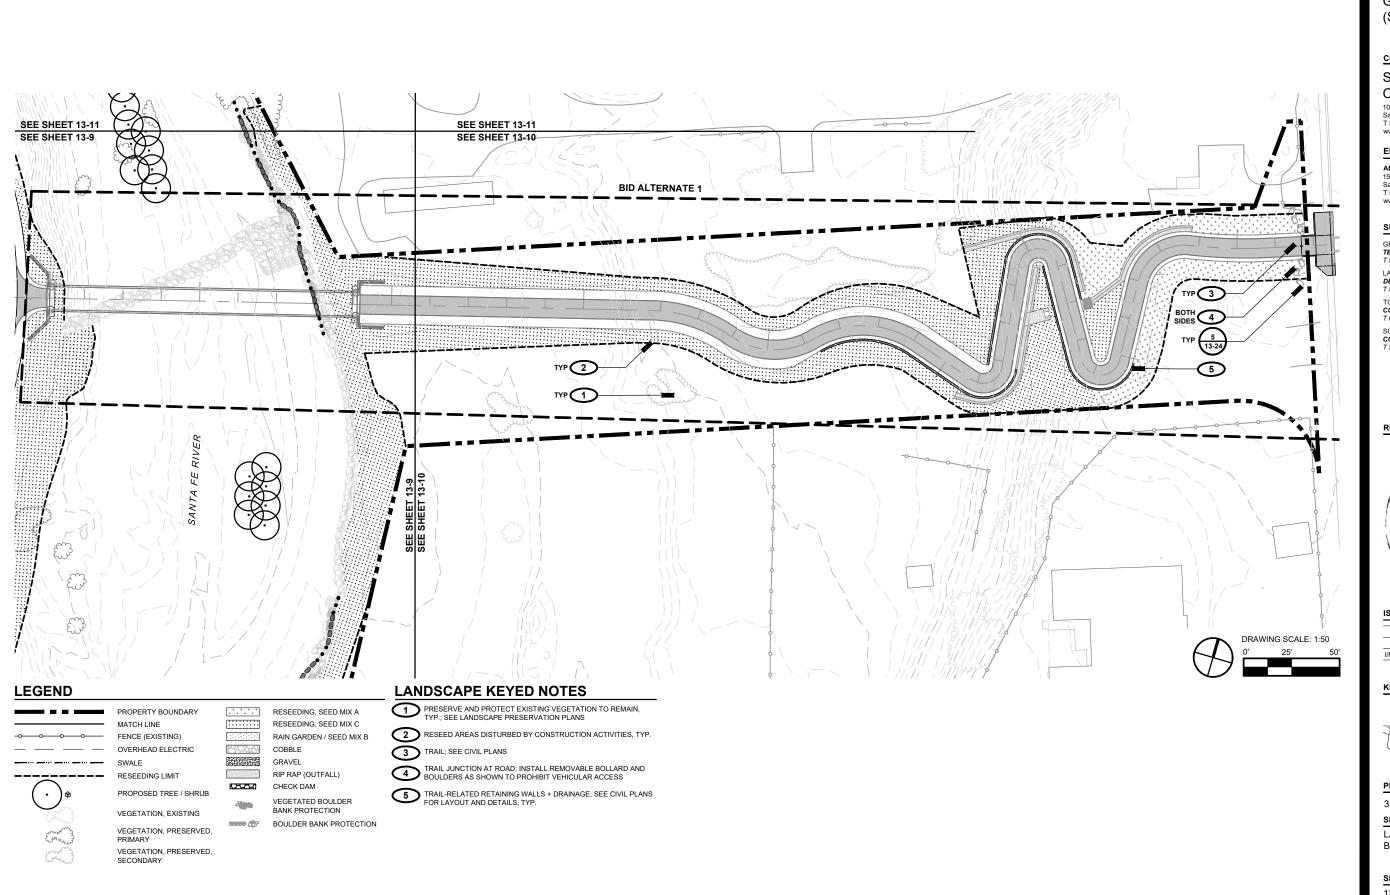

PROJECT

SANTA FE RIVER **GREENWAY PROJECT** (SECTION B)

CLIENT

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KEY PLAN




PROJECT NUMBER

357-7708

SHEET TITLE

LANDSCAPE PLAN BID ALTERNATE 1

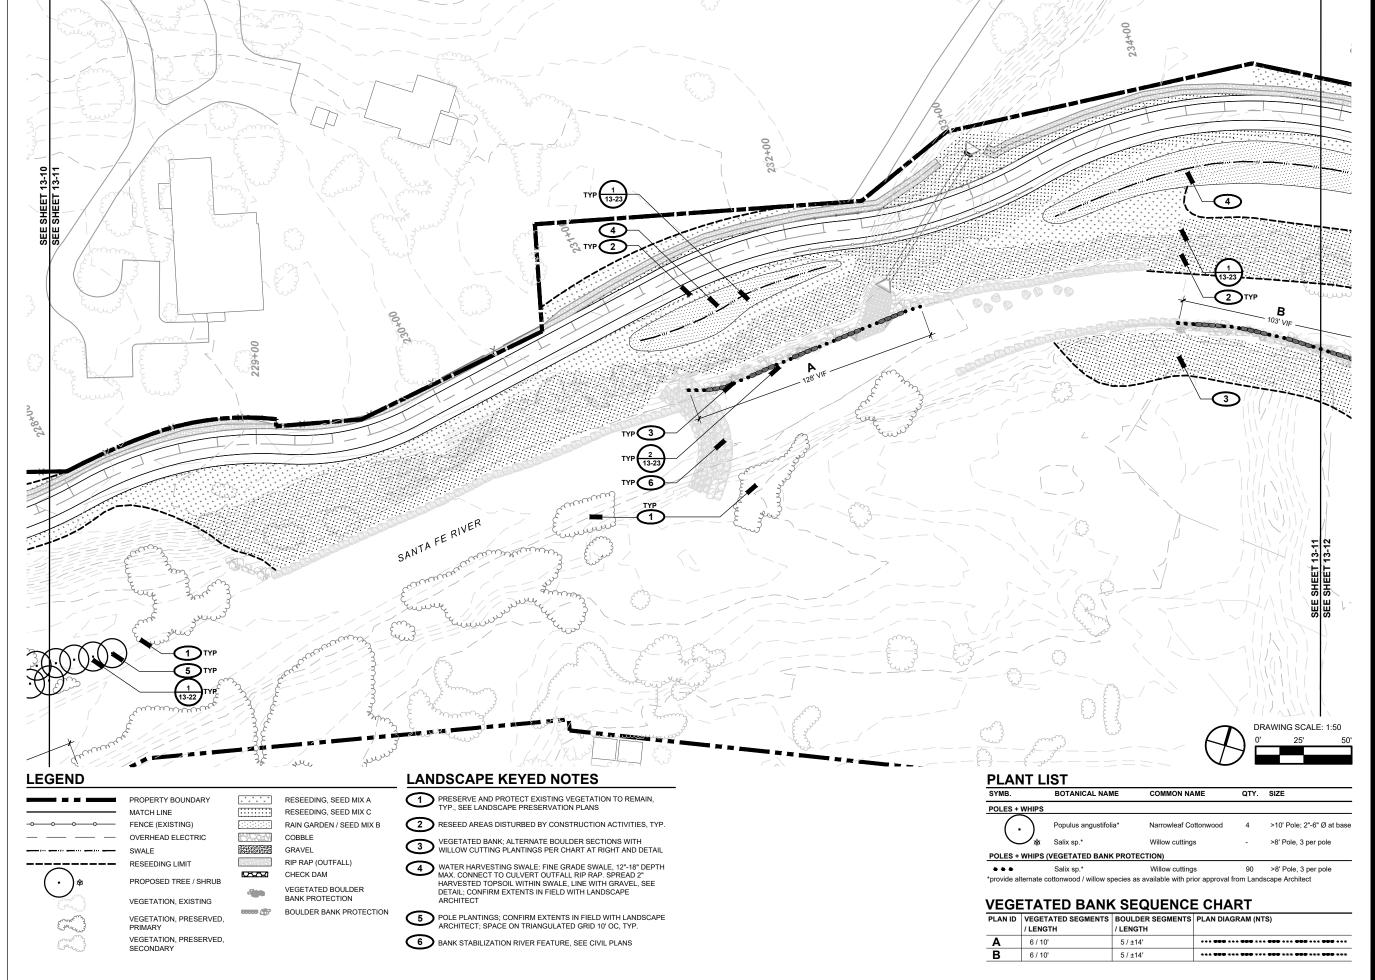

PROJECT

SANTA FE RIVER GREENWAY PROJECT (SECTION B)

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KEY PLAN




PROJECT NUMBER

357-7708 **SHEET TITLE**

LANDSCAPE PLAN

SHEET NUMBER

STILLT NO

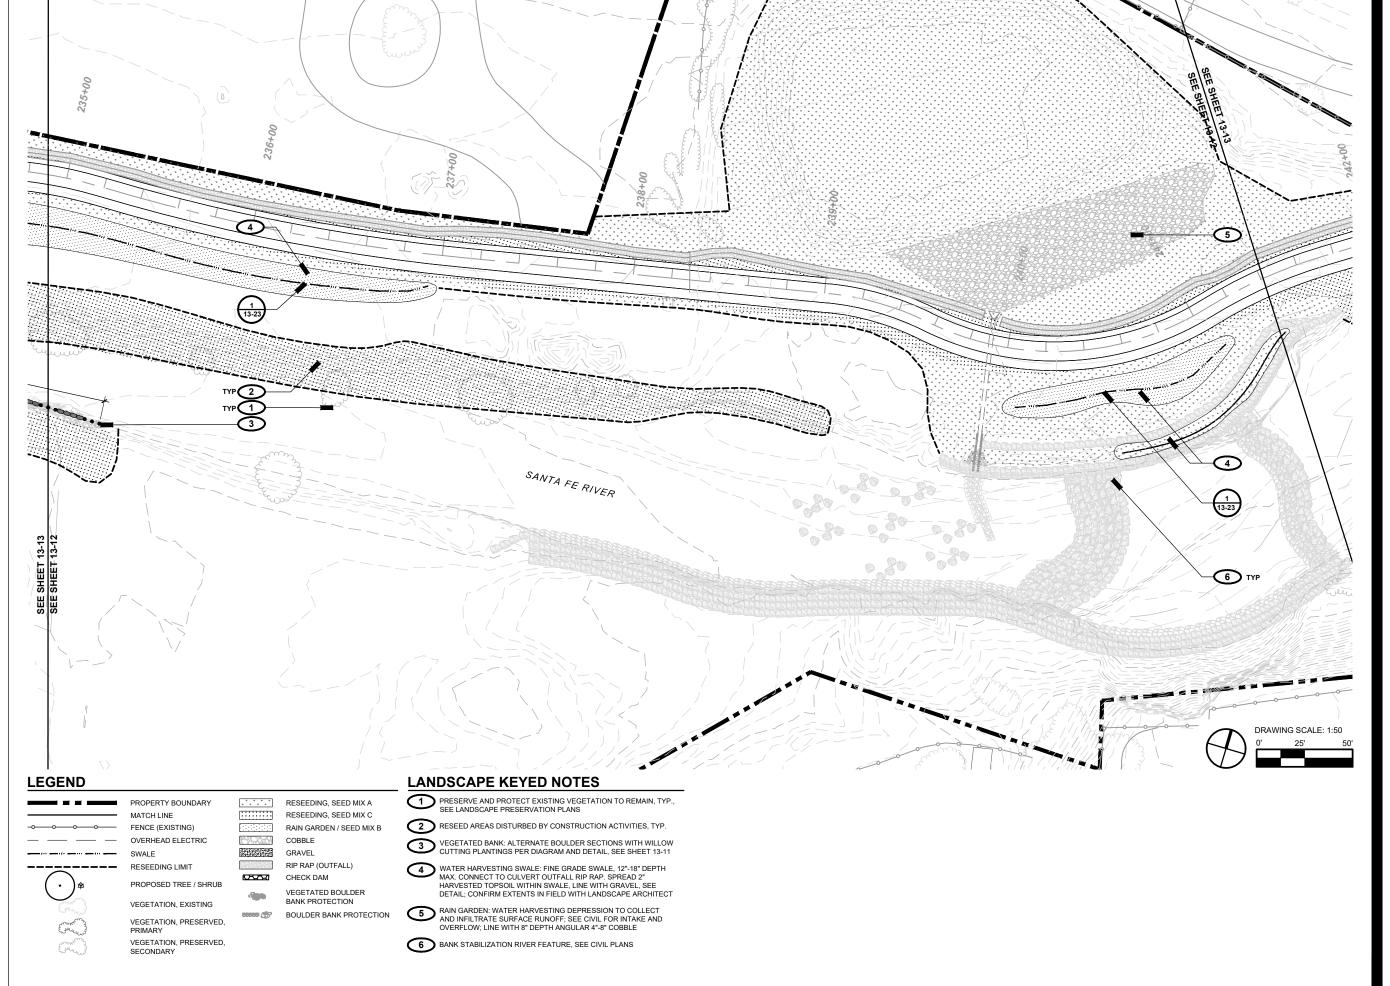

PROJECT

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KEY PLAN



PROJECT NUMBER

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SHEET TITLE


LANDSCAPE PLAN

SHEET NUMBER



ct Management Initials: Designer: JRO Check



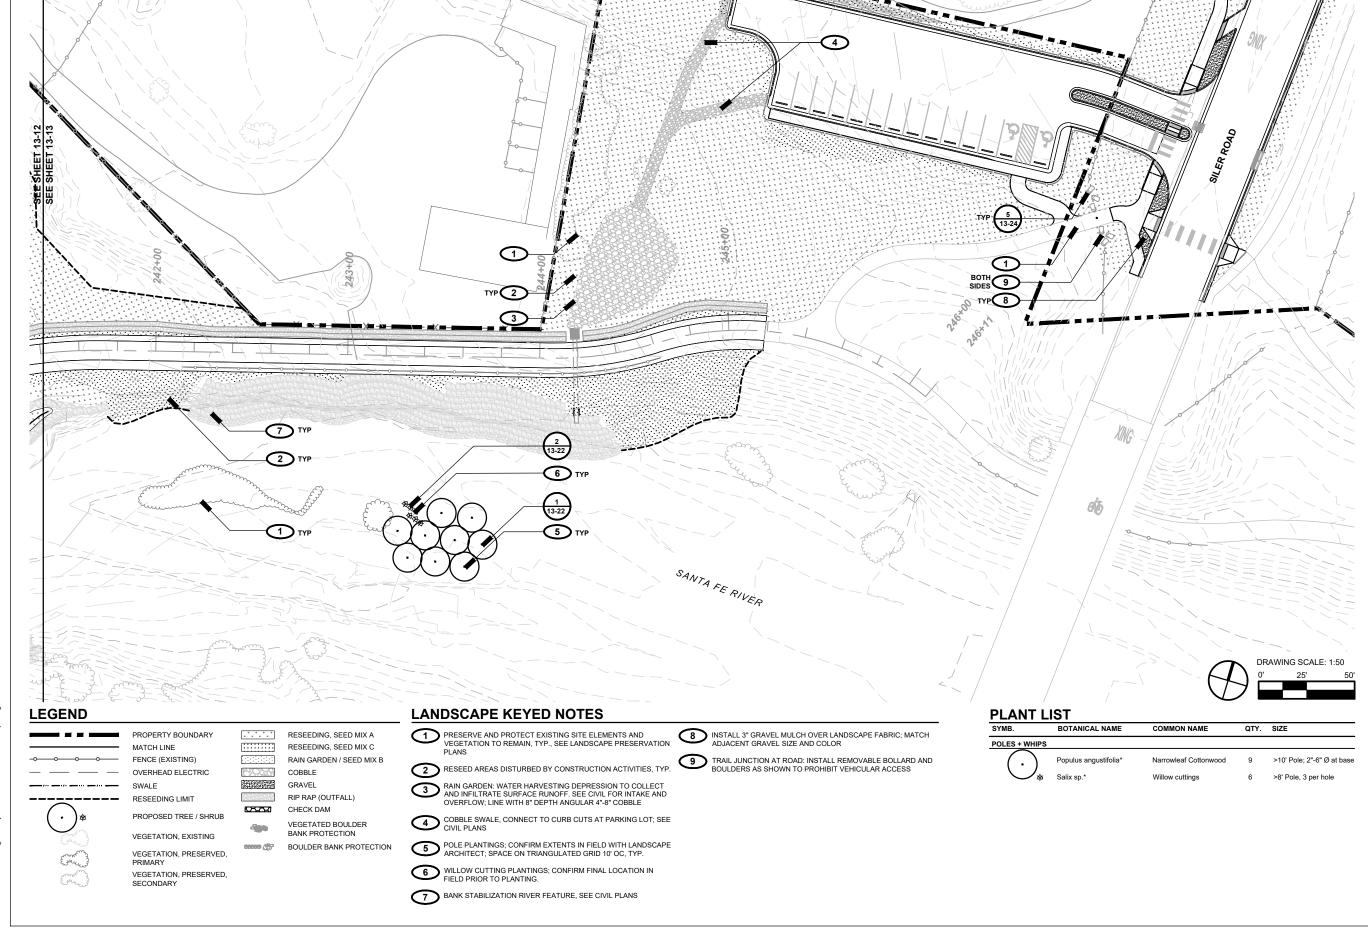

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PROJECT

SANTA FE RIVER GREENWAY PROJECT (SECTION B)

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I/R	DATE	DESCRIPTION

KEY PLAN



PROJECT NUMBER

357-7708

SHEET TITLE

LANDSCAPE PLAN

SHEET NUMBER

DRAWING SCALE: 0' 175' 350

SIGN DIM.

WAYFINDING LEGEND

PROPERTY BOUNDARY
PROPOSED TRAIL

■ MARKER: NHT SIGN

ROAD DESIGNATION SIGN

SIGNAGE GENERAL NOTES

- ALL SIGN POSTS TO BE LOCATED PARALLEL TO TRAIL TREAD AT A MINIMUM OF 2'
 CLEAR FROM EDGE OF DEFINED TRAIL TREAD, UNLESS OTHERWISE NOTED.
- 2. COORDINATE FINAL LOCATION OF WAYFINDING SIGNAGE WITH CONSTRUCTED TRAIL FEATURES, EXISTING VEGETATION, AND PROPOSED SFC SIGNAGE.

SIGNAGE KEYED NOTES

1 NEW SILER ROAD TRAILHEAD MONUMENT SIGN WITHIN ROW, NIC.

2 PRESERVE AND PROTECT EXISTING 'EL CAMINO REAL HIKING TRAIL' SIGN, TYP.

3 SEE CIVIL DRAWINGS FOR REGULATORY SIGNS, TYP.

DIRECTIONAL SIGN / MARKER; CONFIRM FINAL LOCATION IN FIELD WITH LANDSCAPE ARCHITECT.

5 DIRECTIONAL SIGN MARKER; BID ALTERNATE 1; CONFIRM LOCATION IN FIELD WITH LANDSCAPE ARCHITECT.

SIGNAGE SCHEDULE

SIGN FACE

M-1	NHT SIGN, SEE DETAIL 2/13-24	198+40	WOOD	6'	12"x12"; 5.25"x3.75"
M-2	NHT SIGN, SEE DETAIL 2/13-24	201+60	WOOD	6'	12"x12"; 5.25"x3.75"
M-3	NHT SIGN, SEE DETAIL 2/13-24	219+50	WOOD	6'	12"x12"; 5.25"x3.75"
M-4	NHT SIGN, SEE DETAIL 2/13-24	219+60	WOOD	6'	12"x12"; 5.25"x3.75"
M-5	NHT SIGN, SEE DETAIL 2/13-24	233+50	WOOD	6'	12"x12"; 5.25"x3.75"
M-6	NHT SIGN, SEE DETAIL 2/13-24	233+60	WOOD	6'	12"x12"; 5.25"x3.75"
R-1	SEE DETAIL 3/13-24	199+80	WOOD	6'	3"x40"
R-2	SEE DETAIL 3/13-24	200+40	WOOD	6'	3"x40"
R-3-A	SEE DETAIL 3/13-24	227+00	WOOD	4'	3"x36"
R-3-B	SEE DETAIL 3/13-24	227+00	WOOD	4'	3"x36"
R-4	SEE DETAIL 3/13-24	308+20	WOOD	6'	3"x24";18"x18"

STATION POST TYPE POST HEIGHT

AECOM

PROJECT

SANTA FE RIVER GREENWAY PROJECT (SECTION B)

CLIENT

SANTA FE COUNTY



100 Catron St. Santa Fe, New Mexico 87501 T 505.986.6200 www.santafecountynm.gov

ENGINEERING CONSULTANT

AECOM

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SUBCONSULTANTS


GEOTECHNICAL TERRACON T 505.797.4287

LANDSCAPE ARCHITECTURE **DESIGN OFFICE** T 505.983.1415

TOPOGRAPHIC MAPPING COOPER AERIAL SURVEYS CO. T 602.678.5111

SUBSURFACE UTILITY ENGINEERING COLLIERS ENGINEERING & DESIGN T 505.228.3154

REGISTRATION

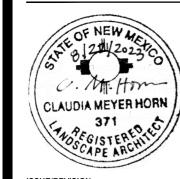

ISSUE/REVISION

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I/R	DATE	DESCRIPTION

KEY PLAN



PROJECT NUMBER

357-7708 SHEET TITLE


SHEET NUMBER

SIGNAGE PLAN

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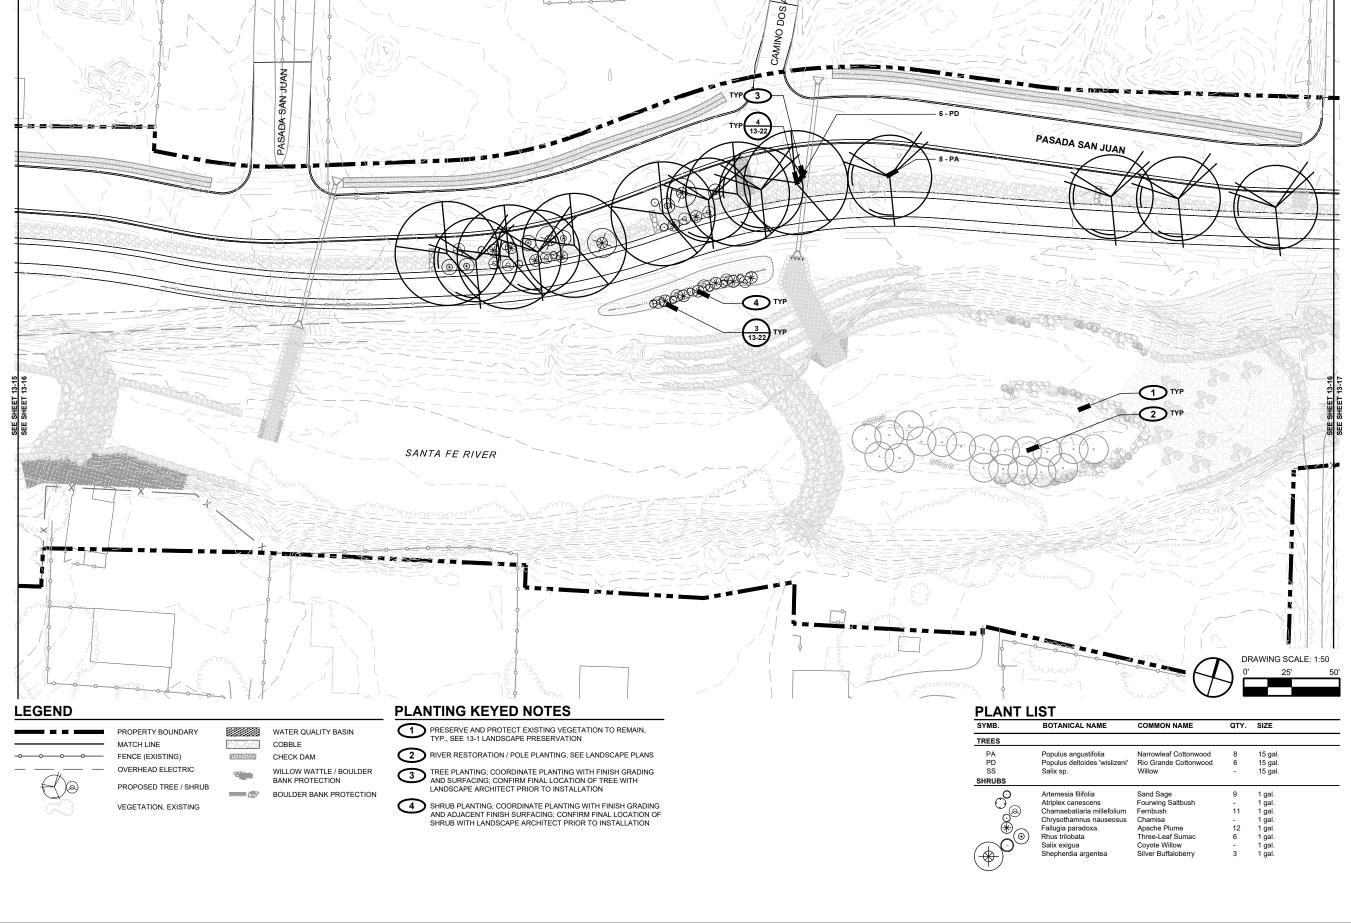
357-7708 SHEET TITLE

PLANTING PLAN

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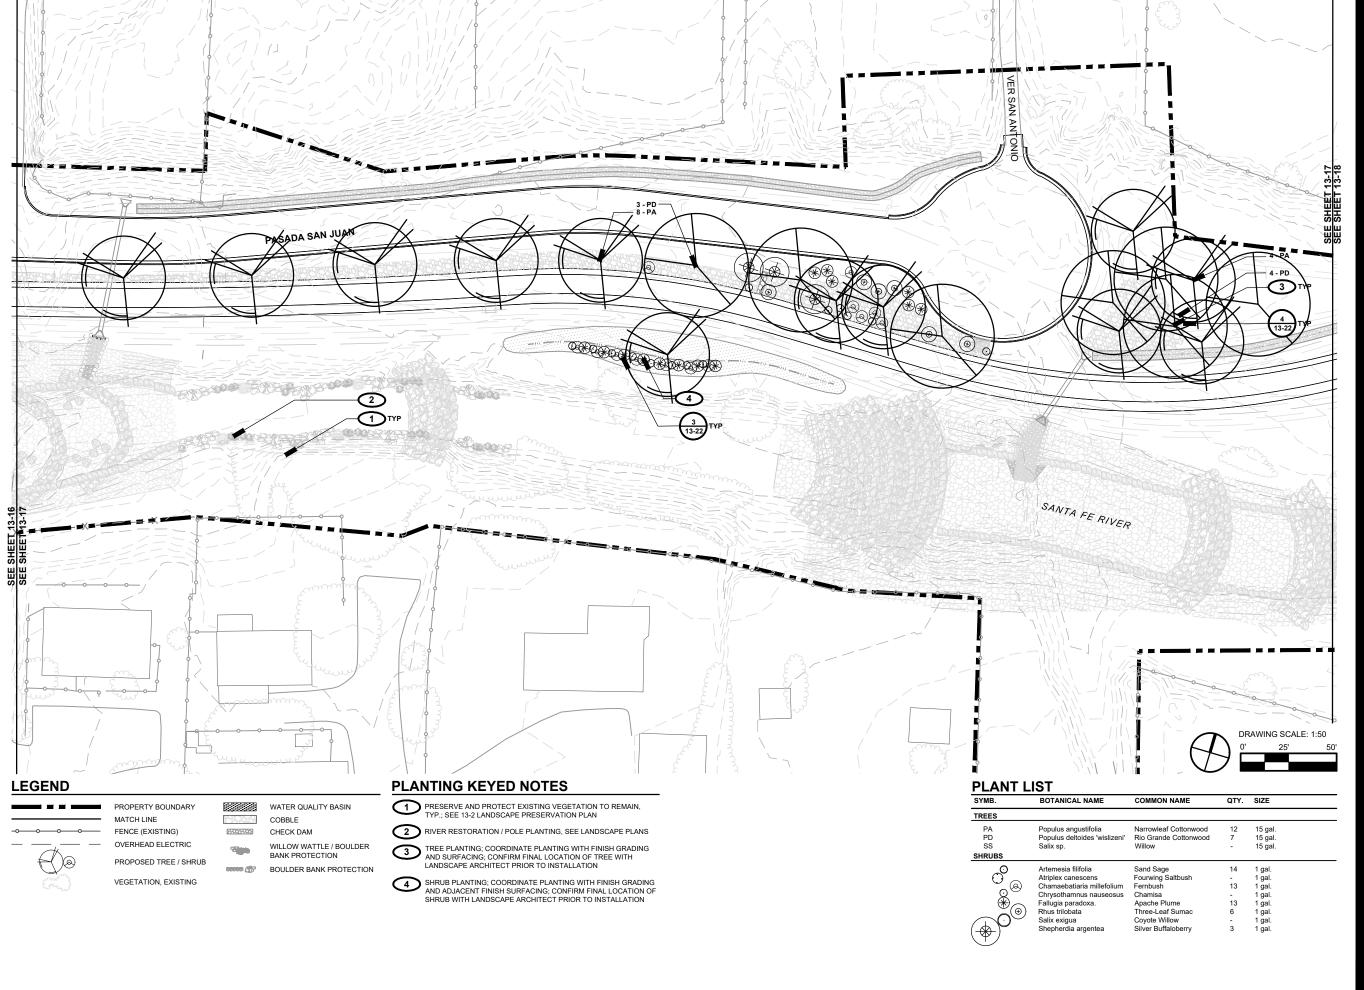
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PLANTING PLAN
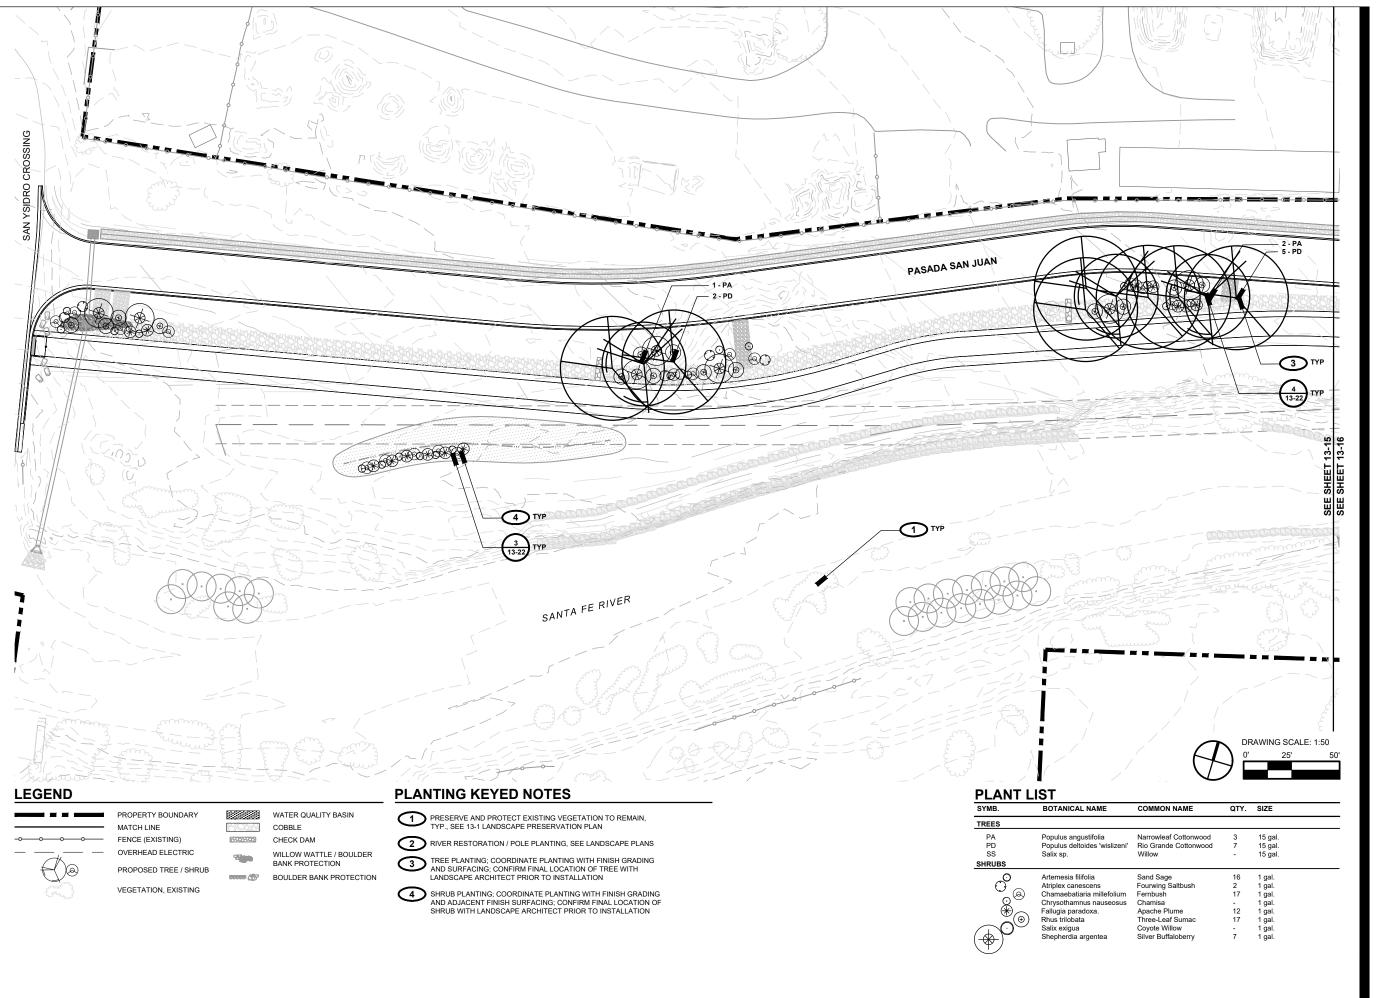
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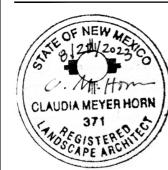
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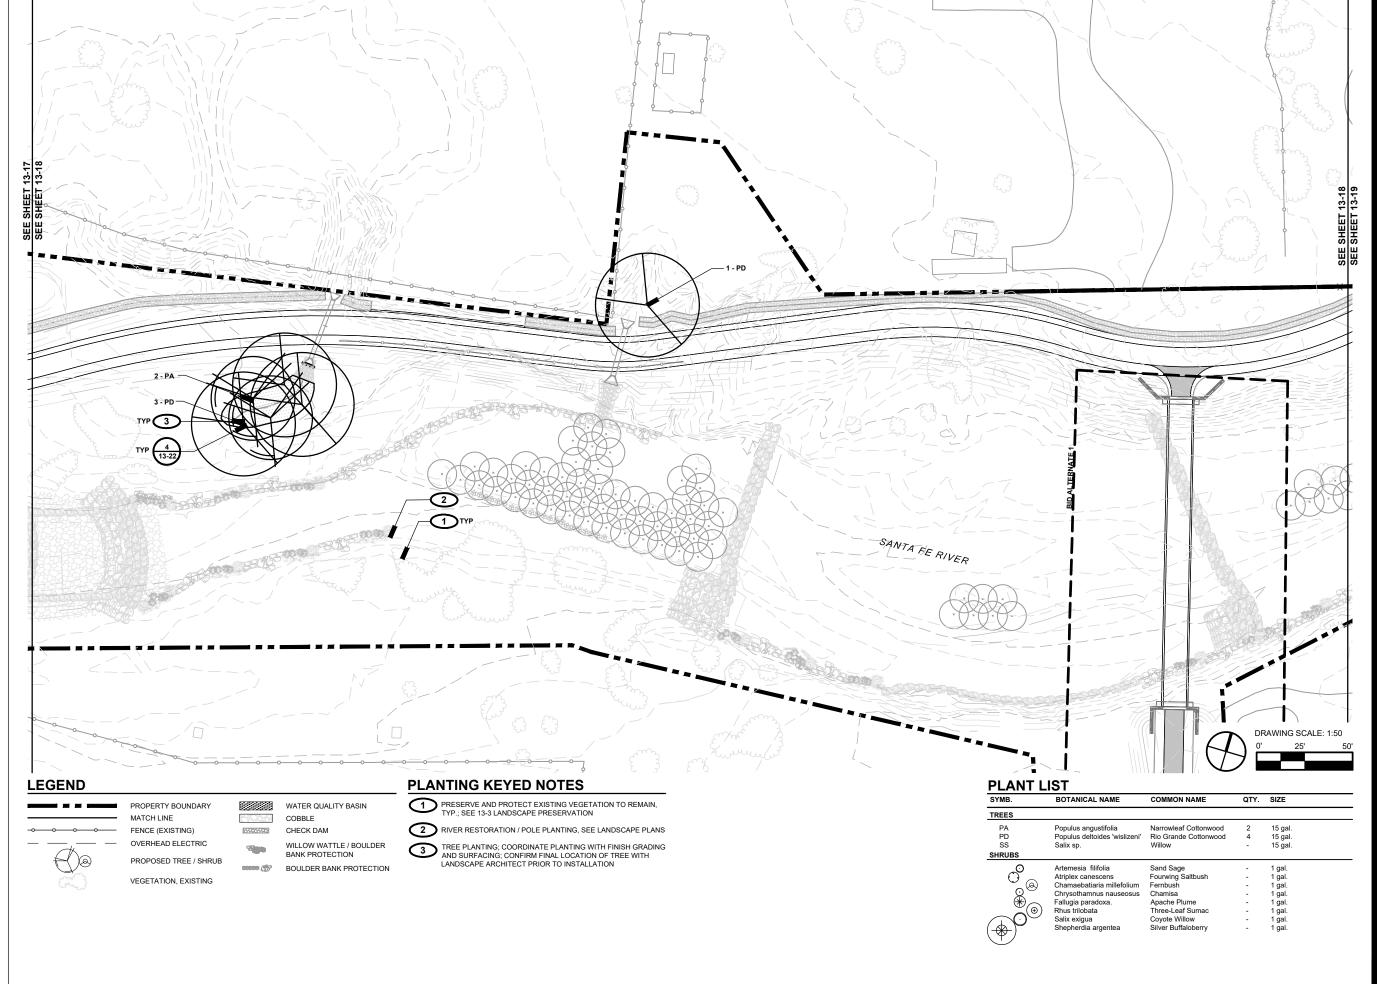
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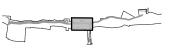
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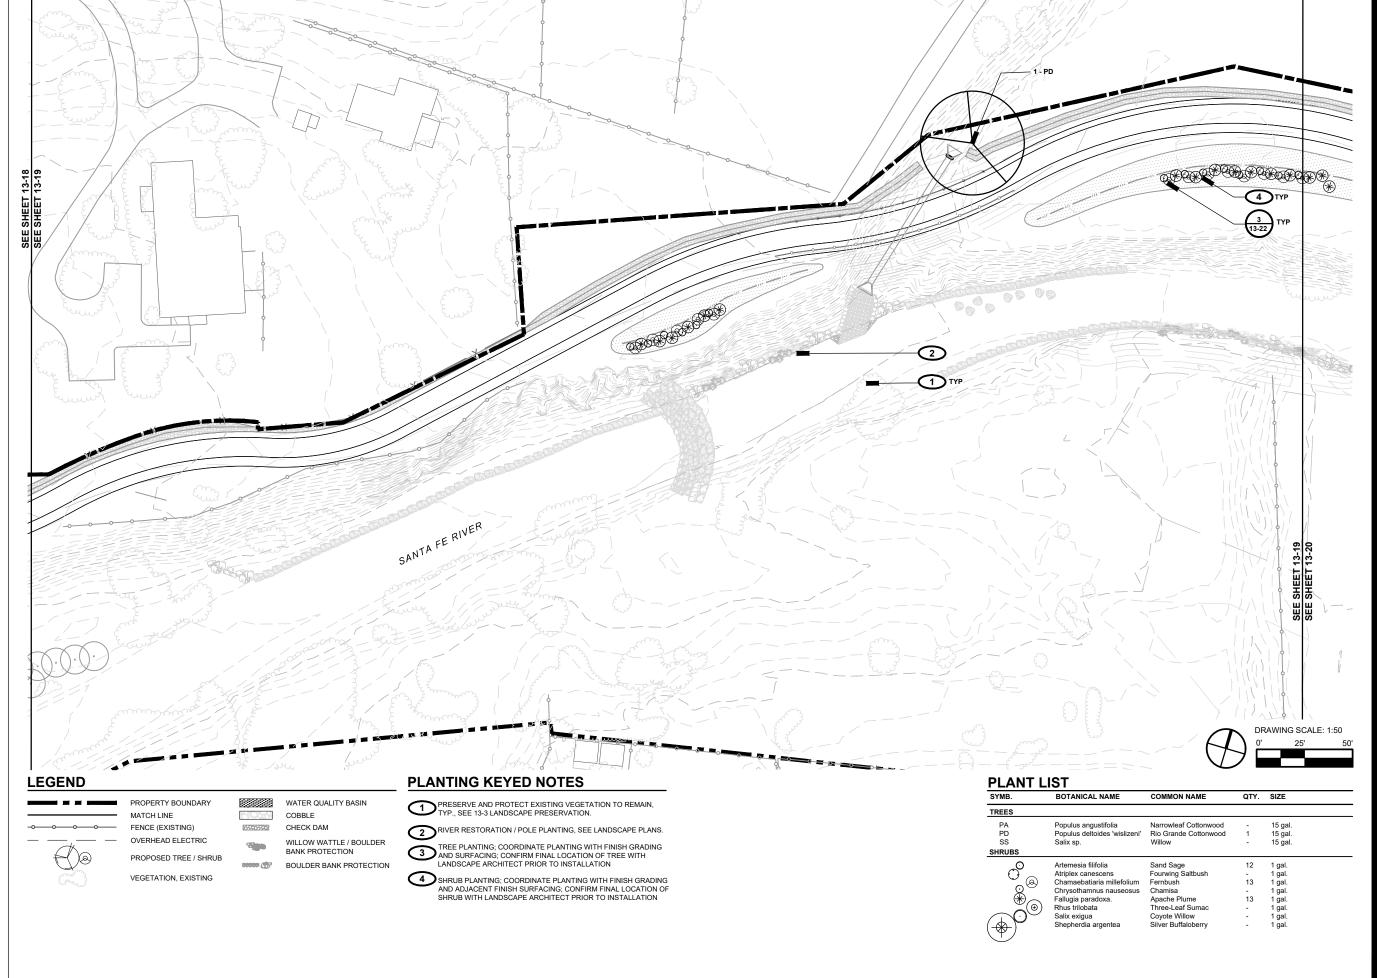
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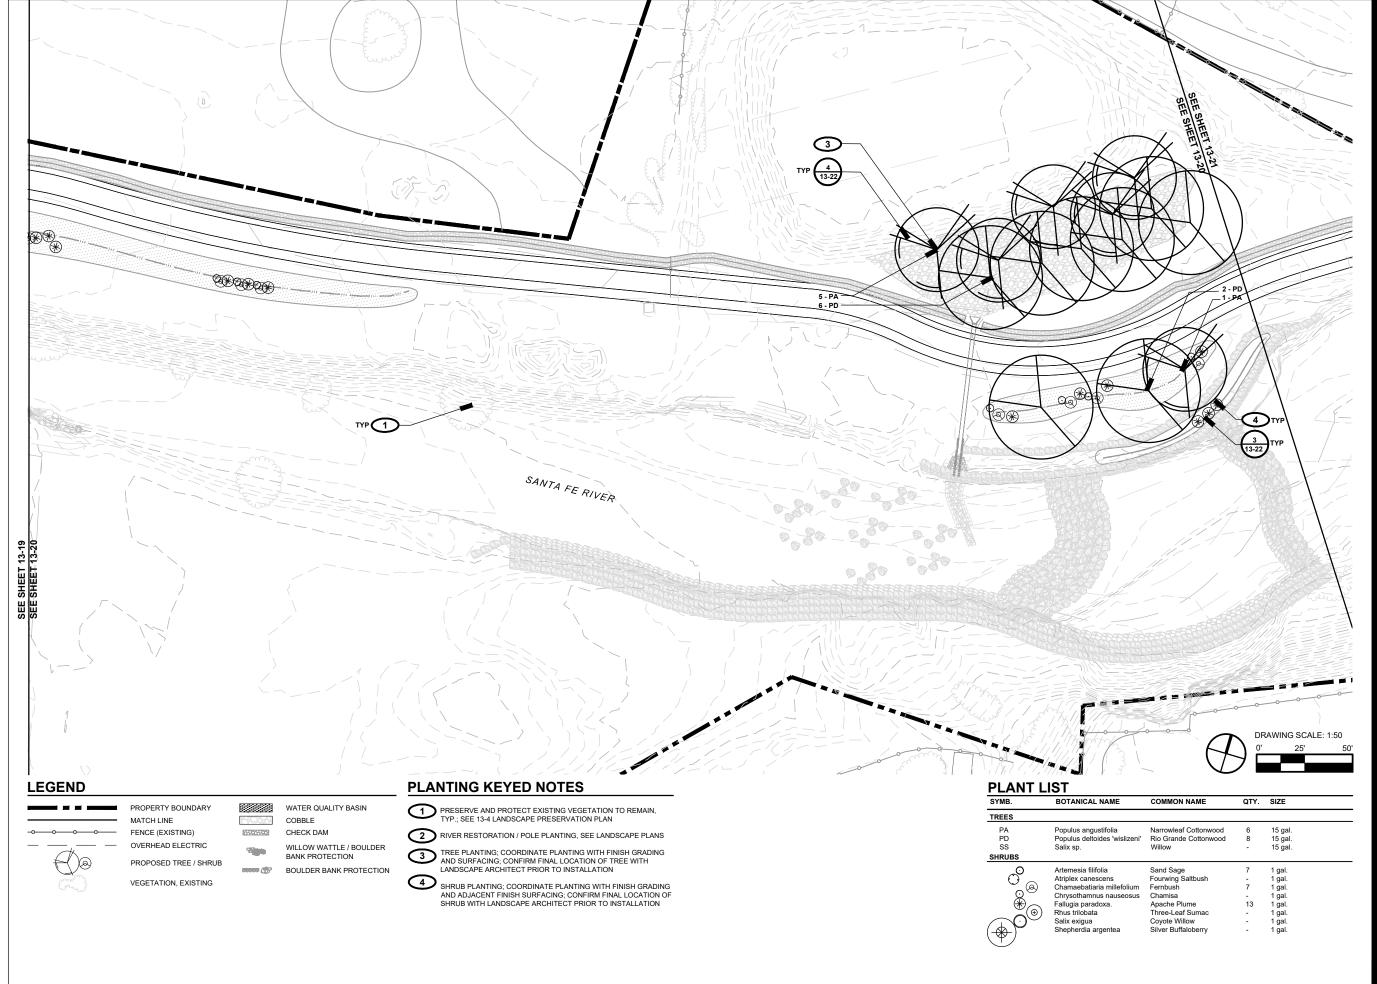


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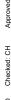



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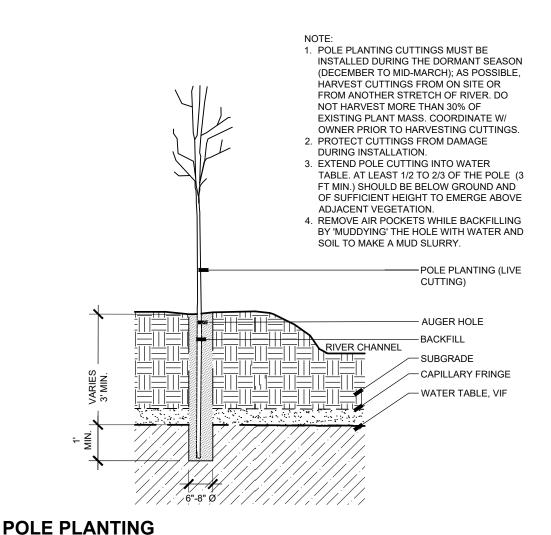


PROJECT NUMBER

357-7708 SHEET TITLE

PLANTING PLAN


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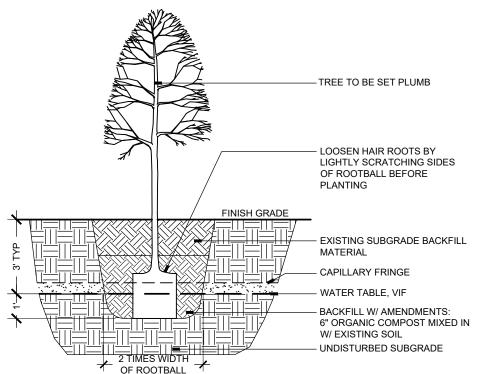
CREATE WATER WELL AROUND SHRUB WITH COMPACTED SOIL LOOSEN HAIR ROOTS BY LIGHTLY SCRATCHING SIDES OF ROOTBALL BEFORE PLANTING MULCH, 2" DEPTH; SEE PLANS **BACKFILL W/ AMENDMENTS** UNDISTURBED **EXISTING SUBGRADE** TWICE WIDTH OF ROOTBALL MIN.

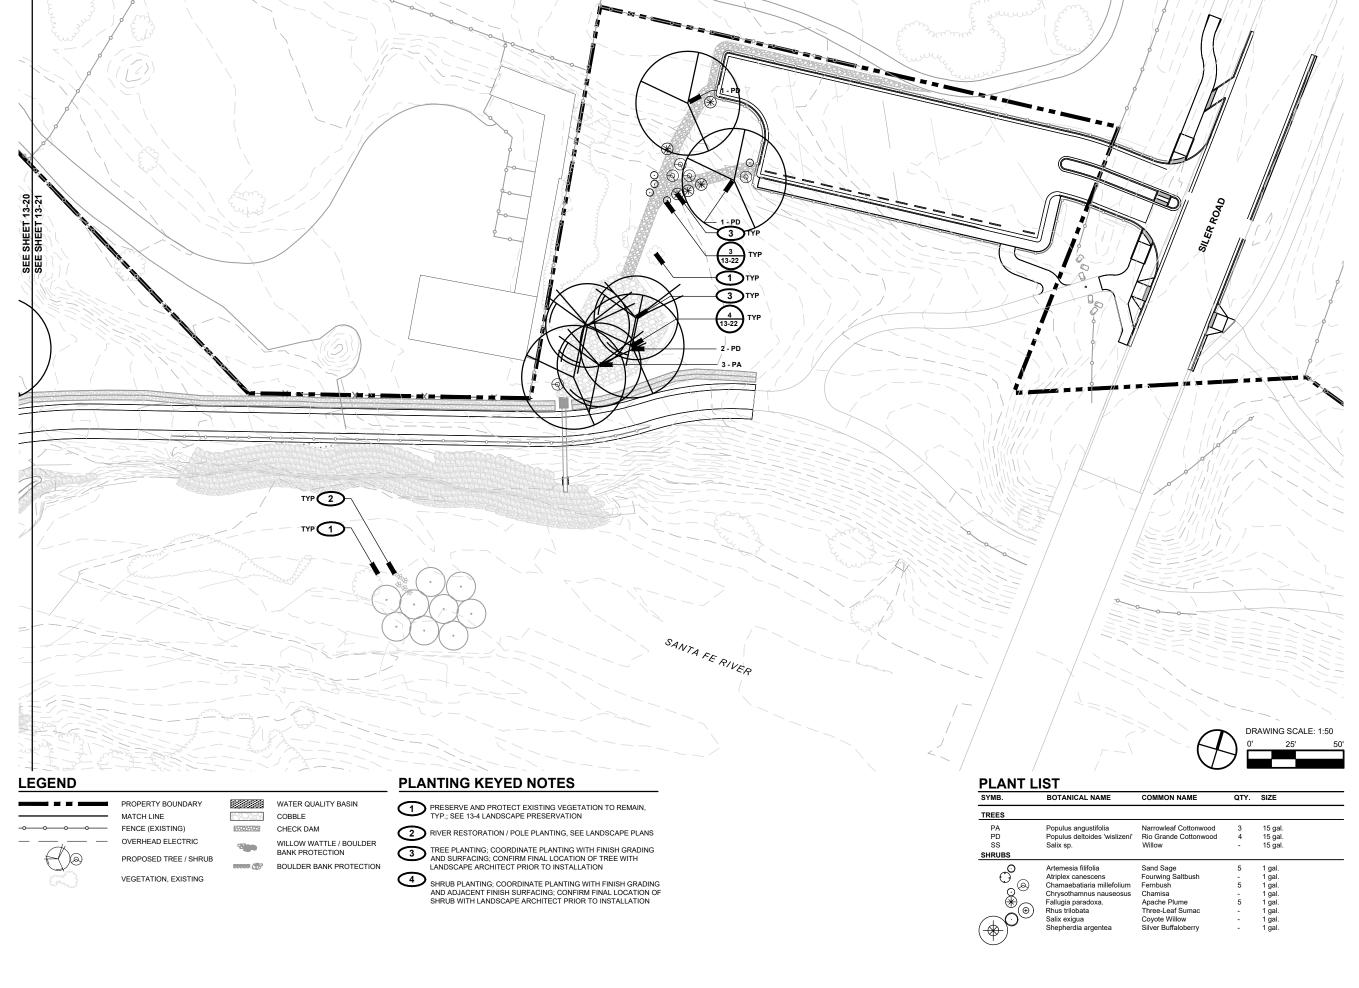SECTION

SHRUB PLANTING



WILLOW WHIP PLANTING

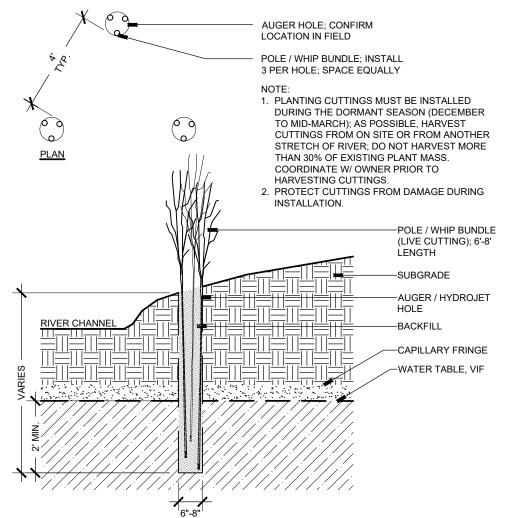

SECTION

TREE PLANTING

PROJECT

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SUBCONSULTANTS


GEOTECHNICAL TERRACON

T 505.797.4287 LANDSCAPE ARCHITECTURE **DESIGN OFFICE** T 505.983.1415

TOPOGRAPHIC MAPPING COOPER AERIAL SURVEYS CO. T 602.678.5111

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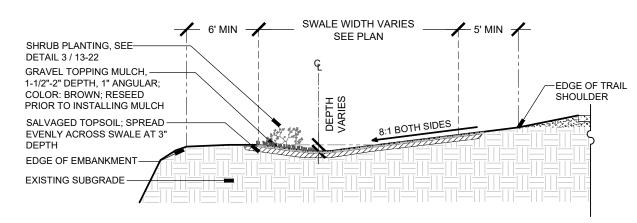
357-7708

SHEET TITLE

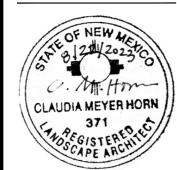PLANTING DETAILS

SHEET NUMBER







LOW SWALE

NOTE:


- 1. POLE PLANTING CUTTINGS MUST BE INSTALLED DURING THE DORMANT SEASON (DECEMBER TO MID-MARCH), SEEDLINGS MAY BE PLANTED IN EARLY SPRING OR LATE FALL.
- 2. PROTECT CUTTINGS FROM DAMAGE DURING INSTALLATION.
- 3. INSTALL CUTTINGS IN COORDINATION WITH BANK PROTECTION INSTALLATION, OR INSTALL TEMPORARY TUBING FOR PLANTING AT A LATER DATE

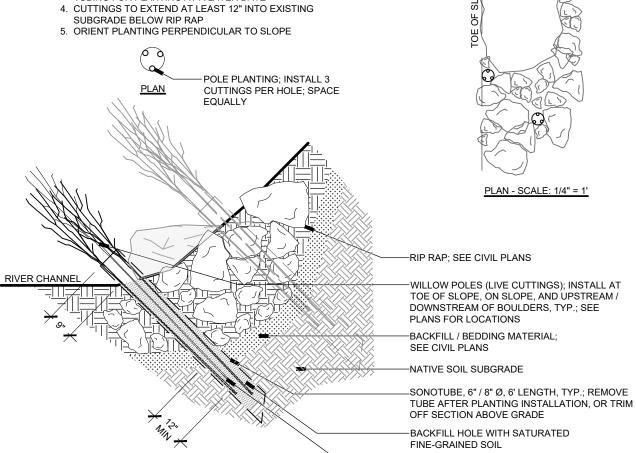

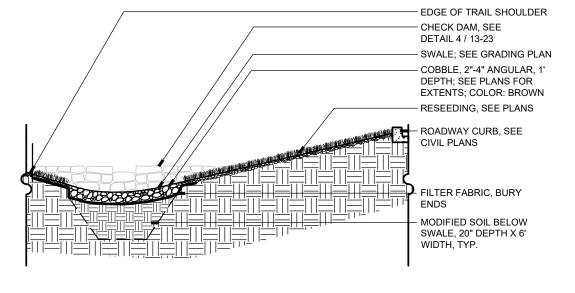




SECTION

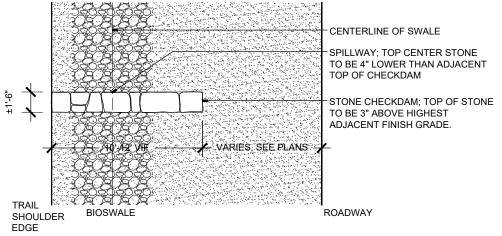

PLAN DIAGRAM

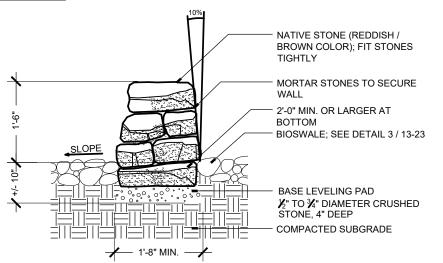

SECTION





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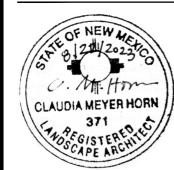
GEOTECHNICAL TERRACON T 505.797.4287

LANDSCAPE ARCHITECTURE DESIGN OFFICE T 505.983.1415

TOPOGRAPHIC MAPPING COOPER AERIAL SURVEYS CO. T 602.678.5111

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KEY PLAN

PROJECT NUMBER

357-7708

SHEET TITLE

PLANTING DETAILS

SHEET NUMBER

13-23



WILLOW CUTTINGS - BANK PROTECTION

EXTEND POLES INTO SOIL BENEATH

BACKFILL / BEDDING MATERIAL, TYP.