### APPLICATION FOR PERMIT TO CONSTRUCT AN ACCESS OR MEDIAN OPENING ON PUBLIC RIGHT-OF-WAY

District No. 5 Project No. Posted Speed 55 Type of Vehicle	Department U Permit NoC-2023-015 Station No.(s) Highway ADT_8574 Esti	State Highway No. NM 14 Mile Post(s) 41.53 positive Sight Distance Adequate imated Driveway ADT 8	
ATTN: DISTRICT ENG	PARTMENT OF TRANSPORTA INEER Roswell	TION  ☐ Las Vegas ☑ Santa Fe	<b></b> Milan
Application is hereby m	nade by Rancho Viejo Limited Pa (Owner of Property , to develop or redevelop	(Mailing According Accordi	
opening(s) or to () modillegal access to a lawfe	dify or transfer an existing lawful a ul access at the following describ cess to a 24' wide turnout located		
The proposed driveway on NMAC, State Highway Addrives Structure (), will closed to livestock. The address of the state of	(month, day, year) r median opening must be located, d ccess Management Requirements. A I be required which owner agrees to applicant shall submit a construction	in accordance with the attack and will require approximately 60 lesigned and constructed in accordance Gate (), Cattle Guard (), Additional Fe furnish and hereafter maintain in good retraffic control plan for approval. The own	with 18.31.3 nce ( ), repair and ner will protect,
owner, or third parties, by comply with all condition, constructed, this permit w permittee shall notify the construction, and upon con heirs, successors-in-inter-	owner's failure to comply with the all restrictions, and regulations of the N ill expire six (6) months from the date District Engineer of the pending consumpletion, which shall be within 45 daest, assigns, and occupants of the preserved.	ation harmless from any injury or damage bove. If this permit is granted, owner furt ew Mexico Department of Transportatio e of issue unless otherwise noted and a struction at least three (3) working days pays of initiation of construction. The perm reperty serviced by the access shall be reported.	ther agrees to n. If not pproved. The orior to any nittee, his or her responsible for
the removal of snow or ic	e upon the access even though depo Any work in state highway right-of-	he roadway including any cattle guard a osited on the access in the course of the way must be approved in writing by the	Department
Place (Of Notary) Sa	enta Fe	(Owner's Signature)	<del>~</del>
Sworn to and subscribe  Day of March	ed before me this 3040.	President, Los Atra Title General Partner to	n' vidos, Inc
My commission expires		Rancho Viejo Lin Owner's Phone No. 105-474	

STATE OF NEW MEXICO
NOTARY PUBLIC
CHRISTINE GARCIA
COMMISSION NUMBER 1127051
EXPIRATION DATE 09-11-2023

Permission granted this 31 day of May , 20 23 , subject to the above stated conditions and the following additional requirements (attach separate sheet as required:)					
Deviation from the stated conditions or the approved sketch may be grounds for revocation.					
Distri	bution:	NEW MEXICO DEPARTMENT OF TRANSPORTATION			
Copies:	G.O. Files District Engineer Applicant Traffic Services Engineer	By			
	and the second s	ACCESS INFORMATION			
NAME:	Rancho Viejo Limite	ed Partnership			
ADDRES	s: PO Box 236				
CITY:	Santa Fe	STATE: NM ZIP: 87504			
COUNTY:	Santa Fe	<b>PHONE</b> : 505-474-4870			
1. ROUTE	No. (S.R./US):	State Road 14			
2. LOCAT	ION (NEAREST MILEPOST	y 42 Mile Post 41.63			
3. ACCES	<b>S WIDTH:</b> 24'				
4. LENGT	H OF PROPERTY FRONTA	<b>GE</b> : 5,389'			
5. ACCES	S TYPE (commercial/resid	ential/other): Commercial			
6. ACCES	S RADIUS: 30'				
7. GATE/	CATTLE GUARD/OTHER:	Cattle guard at R/W			
8. TYPE C	F SURFACE MATERIAL:	Asphalt concrete pavement			
*****FOR OFFICIAL USE ONLY****					
1. POSTE	D SPEED: 55				
	DISTANCE: Adequate				
3. DRAINAGE: Must meet Santa Fe County Land Development Code					
4. CULVE	RT SIZE: N/A				
5. CONC.	END BLANKETS: N/A				
6. R.O.W.	TO R.O.W. WIDTH: 200'				
7. DRIVIN	G LANE WIDTH: 12'	SHOULDER WIDTH: 8'			
8. HIGHW	HIGHWAY A.D.T.: 8574 ESTIMATED ACCESS A.D.T.: 8				
SPECIAL NOTES AND/OR CONDITIONS					



May 31, 2023

Rancho Viejo Limited Partnership PO Box 236 Santa Fe, NM 87504

#### SUBJECT: PERMIT #5-C DRIVE-2023-015 – NM 14 Milepost 41.53 positive

#### Dear Applicant:

Your request to permit a commercial access on NM 14 at Milepost 41.53 positive within the New Mexico Department of Transportation (NMDOT) right-of-way has been approved. The regulations and requirements of the New Mexico Administrative Code in Title 18, Chapter 31, Part 6 entitled "State Highway Access Management Requirements" apply. In addition, we are requiring that the following items, which are indicated by an "X", be strictly complied with:

The access shall be used as a residential access only as stated on the application. The number of residential housing units shall not exceed four (4) on this permit. If at any time in the future the number of residential housing units exceeds four (4) it shall be the responsibility of the property owner to re-apply for a new access or median opening. X The access shall be used as a commercial access or median opening only as stated on the application for Photovoltaic Site. X The property owner shall remove any vegetation originating on their property which obscures sight distance to and from the state highway. (DRAINAGE CONDITION TWO) A minimum of a twenty-four inch (24") diameter drainage culvert pipe, with concrete end blankets and safety grates, shall be installed beneath the *median opening*. If a drainage study indicates a larger size pipe is needed then that studies recommendation will determine the appropriate size of the drainage culvert. The transverse slopes, or side slopes, of the median opening shall be a minimum of 8:1. (DRAINAGE CONDITION THREE) A twenty-four inch (24") diameter

drainage culvert pipe, with standard metal end sections, shall be installed beneath the **access**. The transverse slopes, or side slopes, of the access shall be a minimum of 8:1.

Michelle Lujan Grisham

Governor

Ricky Serna Cabinet Secretary

#### Commissioners

**Jennifer Sandoval** Commissioner, Vice-Chairman District 1

**Bruce Ellis**Commissioner
District 2


Hilma E. Chynoweth Commissioner

Walter G. Adams Commissioner, Chairman District 4

Thomas C. Taylor Commissioner District 5

Charles Lundstrom
Commissioner, Secretary
District 6

Rancho Viejo Limited Partnership PO Box 236 Santa Fe, NM 87504

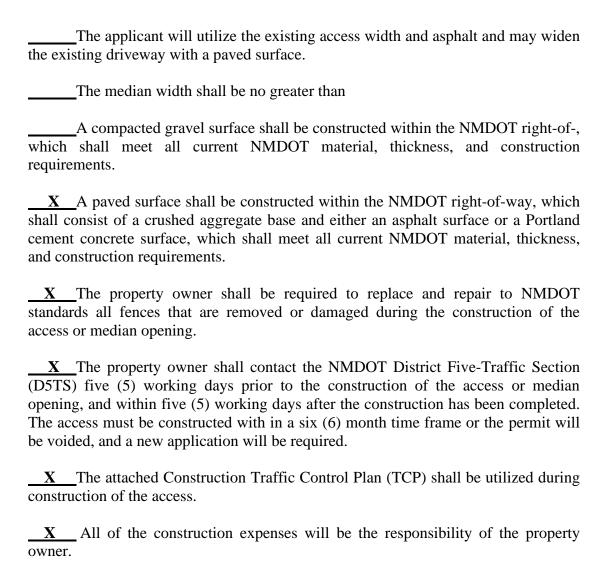

Rancho Viejo Limited Partnership PO Box 236 Santa Fe, NM 87504

If you have any questions regarding this matter, please do not hesitate to contact me at (505) 500-2360.

Thank you,

Javier Martinez Javier Martinez, P.E.

Assistant District Engineer – Engineering Support

cc: Highway Maintenance Supervisor (Patrol 4546)

Records Management, General Office (B-17)

File (NM 14 MP 41.53 positive)

#### DRIVEWAY PERMIT CONSTRUCTION NOTIFICATION FORMS

The property owner shall complete these forms in order to notify the NMDOT D5TS on the status of all access or median construction activities. The "Notice of Construction" shall be mailed or delivered to the NMDOT D5TS five (5) working days prior to the construction of the access or median opening. The "Notice of Construction Completion" shall be similarly mailed or delivered to the NMDOT D5TS upon the completion of the access or median opening.

NEW MEXICO DEPARTMENT OF TRANSPORTATION DISTRICT FIVE TRAFFIC SECTION P.O. BOX 4127 SANTA FE, NM 87502-4127

\_\_\_\_\_\_

#### NOTICE OF DRIVEWAY CONSTRUCTION COMPLETION

Rancho Viejo Limited Partnership PO Box 236 Santa Fe, NM 87504

SUBJECT: PERMIT #5-C DRIVE-2023-015 – NM 14 Milepost 41.53 positive

\_\_\_\_\_\_

#### NOTICE OF DRIVEWAY CONSTRUCTION

Rancho Viejo Limited Partnership PO Box 236 Santa Fe, NM 87504

SUBJECT: PERMIT #5-C DRIVE-2023-015 – NM 14 Milepost 41.53 positive

WARNING: Failure to properly notify the NMDOT D5TS, concerning your access or median opening construction activities, may be grounds for revocation of the access or median opening permit. THIS PERMIT WILL EXPIRE ON 12/1/2023. IF WORK DOES NOT COMMENCE BY THAT DATE REAPPLICATION WILL BE REQUIRED!



#### **GENERAL NOTES**

- 1. ALL CURVE DATA AND DIMENSIONS REFER TO EDGE OF PAVEMENT, UNLESS OTHERWISE NOTED.
- 2. CONTRACTOR IS RESPONSIBLE FOR REPAIR AND/OR REPLACEMENT OF ALL EXISTING UTILITY CONDUITS AND UTILITY LINES THAT ARE DAMAGED DURING CONSTRUCTION.
- 3. CONTRACTOR SHALL PARK EQUIPMENT AND VEHICLES AS NOT TO INTERFERE WITH NORMAL ACTIVITIES OR VEHICULAR TRAFFIC.
- 4. ANY DAMAGE TO THE EXISTING FACILITIES DURING CONSTRUCTION SHALL BE REPLACED AT THE CONTRACTOR'S EXPENSE.
- ALL EXCAVATION, TRENCHING, AND SHORING ACTIVITIES MUST BE CARRIED OUT IN ACCORDANCE WITH OSHA 29 CFR1926.650 SUBPART P.
- 6. ALL PAVEMENT, STRIPING, AND SIGNAGE WITHIN THE NMDOT RIGHT-OF-WAY SHALL CONFORM TO NMDOT STANDARD SPECIFICATIONS.
- DEMOLITION OF EXISTING PAVEMENT SHALL BE PERPENDICULAR AND/OR PARALLEL TO DIRECTION OF TRAVEL AND ALL EDGES SHALL BE SAWCUT TO FULL PAVEMENT DEPTH.
- 8. ALL TRAFFIC CONTROL DEVICES SHALL COMPLY WITH NEW MEXICO STANDARD SPECIFICATIONS FOR HIGHWAY AND BRIDGE CONSTRUCTION, 2019 EDITION, AND THE CURRENT EDITION, WITH REVISIONS, OF THE MUTCD.
- REVISIONS, OF THE MUTCD.

  9. THE LATERAL CLEARANCE OF SIGNS SHALL BE NO CLOSER THAN 6 FEET FROM THE EDGE OF SHOULDER OR 12 FEET FROM THE EDGE OF TRAVELED WAY FOR RURAL AREAS.
- 10. ALL SIGNAGE HARDWARE IS CONSIDERED INCIDENTAL TO SIGN INSTALLATION; THEREFORE, NO
- CONTRACTOR SHALL FIELD VERIFY ALL SIGNING INFORMATION, TEXT, AND LOCATIONS PRIOR TO FABRICATION AND INSTALLATION. NEW SIGN LOCATIONS SHALL BE APPROVED BY THE PROJECT MANAGER OR THE DISTRICT TRAFFIC ENGINEER.
- 12. ALL STRIPING SHALL CONSIST OF TWO APPLICATIONS OF RETROFLECTORIZED PAINT.
- 13. ALL PAVEMENT MARKINGS SHALL BE HOT THERMOPLASTIC.
- 14. THE CONTRACTOR SHALL MARK THE LAYOUT OF ALL STRIPING AND PAVEMENT MARKINGS AND SHALL OBTAIN CONCURRENCE FROM THE DISTRICT TRAFFIC ENGINEER OR HIS/HER DESIGNEE BEFORE APPLYING THE FINAL STRIPING AND MARKINGS. THIS LAYOUT WILL BE CONSIDERED INCIDENTAL TO THE COST OF THE PAVEMENT MARKINGS AND NO SEPARATE PAYMENT WILL BE MADE.
- 15. WATER BLASTING IS THE ONLY APPROVED METHOD FOR REMOVING STRIPING AND MARKINGS. THE USE OF BLACK PAINT TO COVER ANY STRIPING OR MARKINGS IS STRICTLY PROHIBITED. WHEN WATER BLASTING ON OPEN GRADED FRICTION COURSE (OGFO, OR ON THE FINAL LIFT OF PAVEMENT. THE CONTRACTOR SHALL APPLY A SEAL OF TACK COAT MATERIAL TO THE WATER BLASTED AREA. THIS SEAL SHALL BE INCIDENTAL TO THE REMOVAL OF PAVEMENT STRIPE AND THEREFORE NO SEPARATE PAYMENT WILL BE MADE.

#### O KEYED NOTES


- EXISTING EDGE OF ASPHALT.
- 2. EXISTING FIRE HYDRANT. PROTECT IN PLACE.
- 3. BEGIN ASPHATL PAVEMENT IMPROVEMENTS.
- 4. INSTALL HMA PAVEMENT SECTION.
- 5. MATCH EXISTING ASPHALT ELEVATION.
- FULL DEPTH SAWCUT PARALLEL TO DIRECTION OF TRAFFIC. SEE GRADING PLANS. PROTECT DROP-OFF AT EDGE.
- 7. END ASPHALT PAVEMENT IMPROVEMENTS.
- 8. EXISTING SHOULDER STRIPE.
- INSTALL CATTLEGUARD PER NMDOT STANDARD DETAIL 610-01, LENGTH PER PLAN. RECONNECT FENCE WITH BRACING PER STANDARD DETAILS.
- 10. INSTALL STOP SIGN PER MUTCD STANDARD DETAIL R1-1-24.
- 11. 24\* SOLID WHITE RETROFLECTIVE PAVEMENT STRIPE FOR STOP BAR, PER NMDOT STANDARD DETAIL 704-03.

#### LEGEND




## RANCHO VIEJO SOLAR SITE SITE PLAN

20	DRAWN BY: JTN	DATE: 12/22/2022	
	CHECKED BY:  GSB	BHI PROJECT NO. 20230219	SHEET NO. 2

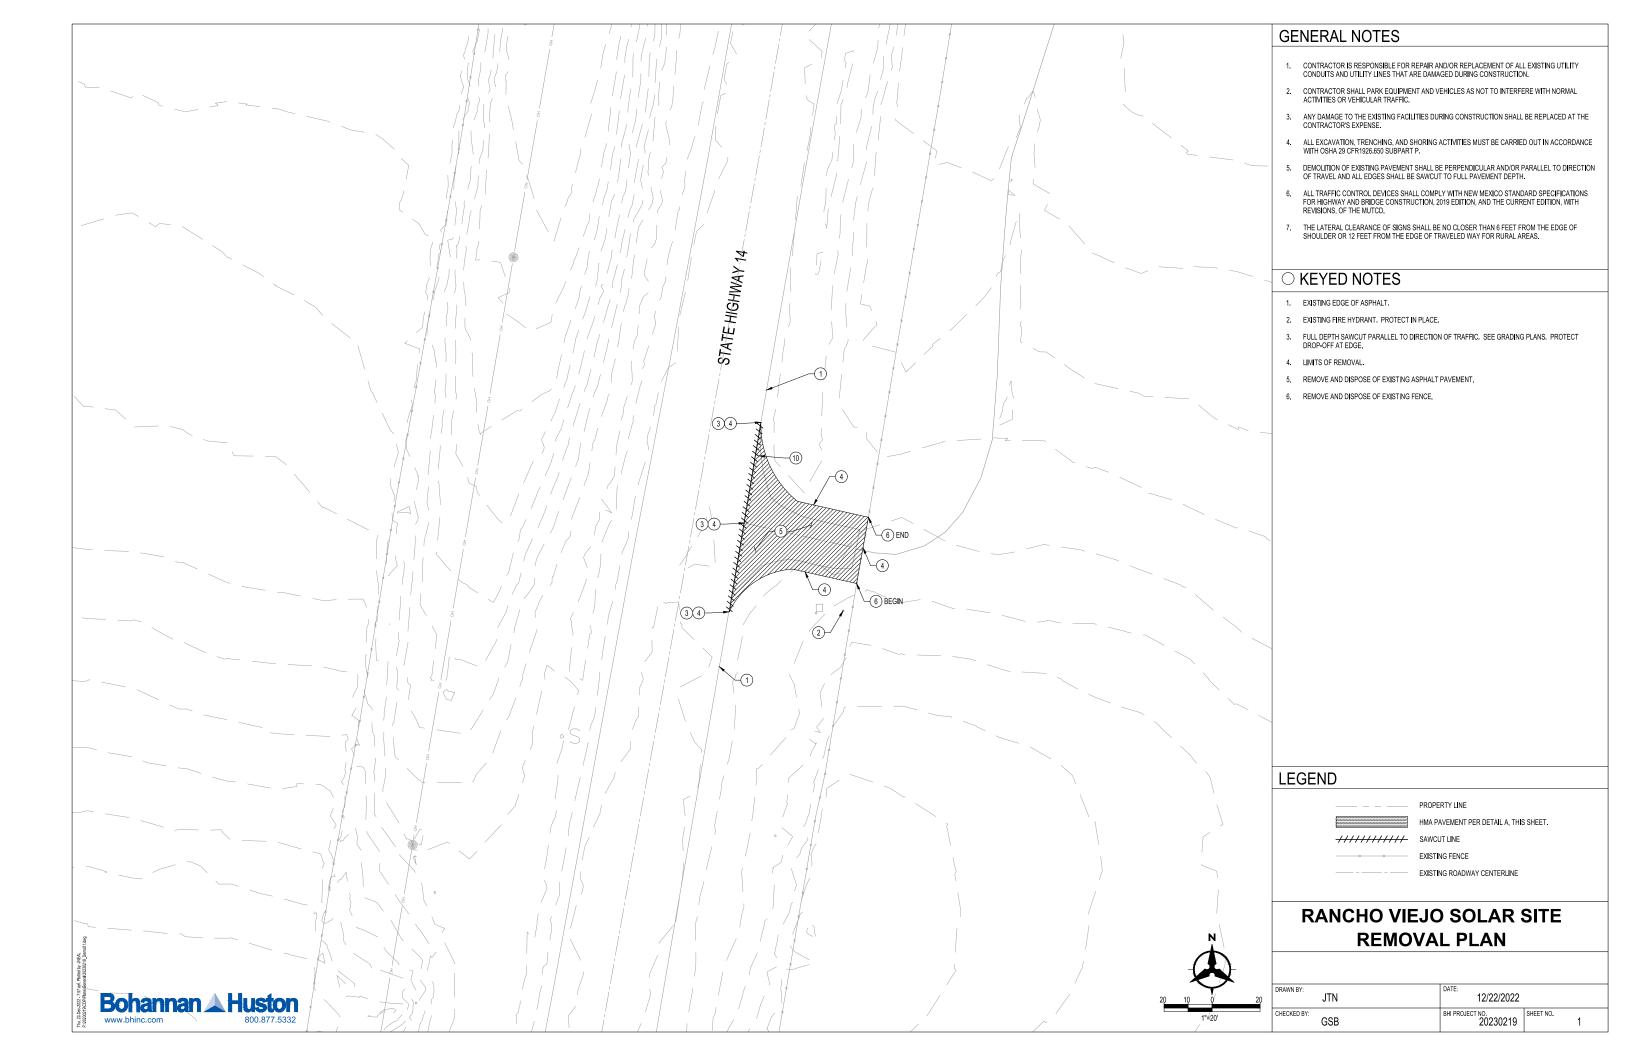



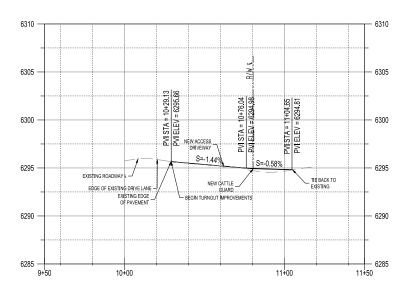

PROFILE VIEW: Rancho Viejo Dvwy I

ALG: Rancho Viejo Dvwy Entrance HORZ. SCALE: 1"=30'

VERT. EXAG.: 6
VERT. SCALE: 1"=5"



### GENERAL NOTES

- ALL SAWCUTS TO BE PERPENDICULAR OR PARALLEL TO DIRECTION OF TRAVEL.
- 2. LANE WIDENING TO MATCH EXISTING TRAVEL LANE CROSS SLOPE(S). NOTIFY ENGINEER OF DISCREPANCIES FROM SURVEY.
- ALL WORK WITHIN THE NMDOT ROW SHALL BE COMPLETED IN ACCORDANCE WITH NMDOT STANDARD SPECIFICATIONS, CURRENT EDITION, AND NMDOT STANDARD DRAWINGS.

#### ○ KEYED NOTES

- 1. MAINTAIN EXISTING SWALE FLOWLINE.
- 2. SAWCUT EXISTING PAVEMENT, FULL DEPTH.
- 3. MATCH EXISTING GRADE; NOTIFY ENGINEER OF ANY DISCREPANCIES.
- 4. EXISTING FENCE TO REMAIN.
- 5. EDGE OF ASPHALT WIDENING.

### **LEGEND**

PROPOSED SPOT ELEVATION
TC=TOP OF CURB
FL=FLOW LINE
TOC=TOP OF CONCRETE
TS=TOP OF SIDEWALK
TG=TOP OF GRATE 95 40 FG=FINISHED GRADE FGH=FINISHED GRADE HIGH FGL=FINISHED GRADE LOW INV=INVERT EXISTING INDEX CONTOUR EXISTING INTERMEDIATE CONTOUR PROPOSED INDEX CONTOUR PROPOSED INTERMEDIATE CONTOUR DIRECTION OF FLOW WATER BLOCK/GRADE BREAK PROPOSED STORM DRAIN MANHOLE PROPOSED STORM DRAIN INLETS PROPOSED STORM DRAIN CAP PROPOSED DRAINAGE SWALE SAWCUT LINE

# RANCHO VIEJO SOLAR SITE GRADING PLAN

DRAWN BY:	JTN	DATE: 12/22/2022		
CHECKED BY:	GSB	BHI PROJECT NO. 20230219	SHEET NO.	



